

From: Scala, Mary Joy
Sent: Wednesday, March 20, 2013 12:01 PM
To: Chris Weatherford (chris.weatherford@bartonmalow.com)
Subject: 500 Court Square - BAR Action

March 20, 2013

James C. Weatherford
100 Tenth Street NE Suite 100
Charlottesville, VA 22902

Certificate of Appropriateness Application

BAR 13-03-03
500 Court Square
Tax Map 53 Parcel 96
James C. Weatherford, Applicant
500 Court Square Association, Owner
Reroof and replace balustrade

Dear Applicant,

The above referenced project was discussed before a meeting of the City of Charlottesville Board of Architectural Review (BAR) on March 19, 2013. The following action was taken:

Approved (9-0) as submitted.

In accordance with Charlottesville City Code 34-285(b), this decision may be appealed to the City Council in writing within ten working days of the date of the decision. Written appeals, including the grounds for an appeal, the procedure(s) or standard(s) alleged to have been violated or misapplied by the BAR, and/or any additional information, factors or opinions the applicant deems relevant to the application, should be directed to Paige Barfield, Clerk of the City Council, PO Box 911, Charlottesville, VA 22902.

This certificate of appropriateness shall expire in 18 months (September 19, 2014), unless within that time period you have either: been issued a building permit for construction of the improvements if one is required, or if no building permit is required, commenced construction. The expiration date may differ if the COA is associated with a valid site plan. You may request an extension of the certificate of appropriateness *before this approval expires* for one additional year for reasonable cause.


Upon completion of construction, please contact me for an inspection of the improvements included in this application. If you have any questions, please contact me at 434-970-3130 or scala@charlottesville.org.

Sincerely yours,

Mary Joy Scala, AICP
Preservation and Design Planner

Mary Joy Scala, AICP
Preservation and Design Planner
City of Charlottesville
Department of Neighborhood Development Services
City Hall - 610 East Market Street
P.O. Box 911
Charlottesville, VA 22902
Ph 434.970.3130 FAX 434.970.3359
scala@charlottesville.org

**CITY OF CHARLOTTESVILLE
BOARD OF ARCHITECTURAL REVIEW
STAFF REPORT
March 19, 2013**

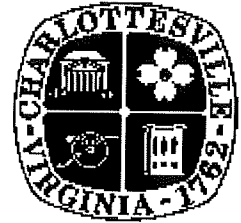

Certificate of Appropriateness Application

BAR 13-03-03

500 Court Square

Tax Map 53 Parcel 96

James C. Weatherford, Applicant

500 Court Square Association, Owner

Reroof and replace balustrade

Background

This property is a contributing structure in the North Downtown ADC district and the Charlottesville Albemarle County Courthouse National Register District. The 1980 National Register nomination describes the building as a 9 story brick (Flemish bond) building with a flat roof designed in the Colonial Revival by architect Stanhope Johnson of Lynchburg. The building was constructed between 1924-26 and originally called the Monticello Hotel.

July 19, 2011 – The BAR approved the replacement of nine existing wood windows in a 6th floor unit facing Market Street with aluminum clad wood window sash kits with exterior applied 7/8” putty profile muntins. This is the only approved window replacement at this time for the entire structure.

June 21, 2011 – The BAR approved on the consent agenda to replace the balustrade with a painted terne-coated stainless steel replica.

September 21, 2004 – Install revolving door

June 17, 2003 - Add two new rectangular windows in south elevation.

July 2001- Locate up to 6 to 9 antennas with accessory telecommunication cabinets

March 2001 -Upgrade rooftop cabinets and co-locate antenna on roof

BAR 94-06-448 -Replace new sliding doors

BAR 90-01-335A -Screening for rear heat pumps

BAR 90-01 -Install six new rear windows; close two fire door entrances; install vent;
add two heat pump units on fire stairs

BAR 89-6-327 -Install new railings on towers and two sets of stairs on roof

BAR 88-2-323 -New windows in south wall façade and 2-3 outdoor mechanical units on fire stair

Application

The applicant proposes to replace the EPDM rubber roof and to replace the existing painted galvanized steel balustrade with a lead coated copper balustrade to match. A similar application was approved in June 2011 but has expired. The proposed replacement balustrade in June 2011 was to be painted terne-coated stainless steel.

Criteria, Standards and Guidelines

Review Criteria Generally

Sec. 34-284(b) of the City Code states that,

In considering a particular application the BAR shall approve the application unless it finds:

(1) That the proposal does not meet specific standards set forth within this division or applicable provisions of the Design Guidelines established by the board pursuant to Sec.34-288(6); and

- (2) *The proposal is incompatible with the historic, cultural or architectural character of the district in which the property is located or the protected property that is the subject of the application.*

Pertinent Standards for Review of Construction and Alterations include:

- (1) *Whether the material, texture, color, height, scale, mass and placement of the proposed addition, modification or construction are visually and architecturally compatible with the site and the applicable design control district;*
- (2) *The harmony of the proposed change in terms of overall proportion and the size and placement of entrances, windows, awnings, exterior stairs and signs;*
- (3) *The Secretary of the Interior Standards for Rehabilitation set forth within the Code of Federal Regulations (36 C.F.R. §67.7(b)), as may be relevant;*
- 6. Deteriorated historic features shall be repaired rather than replaced. Where the severity of deterioration requires replacement of a distinctive feature, the new feature shall match the old in design, color, texture, and other visual qualities and, where possible, materials. Replacement of missing features shall be substantiated by documentary, physical, or pictorial evidence.*
- (4) *The effect of the proposed change on the historic district neighborhood;*
- (5) *The impact of the proposed change on other protected features on the property, such as gardens, landscaping, fences, walls and walks;*
- (6) *Whether the proposed method of construction, renovation or restoration could have an adverse impact on the structure or site, or adjacent buildings or structures;*
- (7) *When reviewing any proposed sign as part of an application under consideration, the standards set forth within Article IX, Sections 34-1020, et seq. shall be applied; and*
- (8) *Any applicable provisions of the city's Design Guidelines (see Sec. 34-288(6)).*

Pertinent Design Review Guidelines – Rehabilitation

NOTE: There are no guidelines specific to a balustrade. Many of the cornice guidelines apply.

E. Cornice

- 1) *Keep the cornice well sealed and anchored, and maintain the gutter system and flashing.*
- 2) *Repair rather than replace the cornice.*
- 3) *Do not remove elements of the original composition, such as brackets or blocks, without replacing them with new ones of a like design.*
- 4) *Match materials, decorative details, and profiles of the existing original cornice design when making repairs.*
- 5) *Do not replace an original cornice with a new one that conveys a different period, style, or theme from that of the building.*
- 6) *If the cornice is missing, the replacement should be based on physical or documented evidence, or barring that, be compatible with the original building.*
- 7) *Do not wrap or cover a cornice with vinyl or aluminum; these substitute materials may cover up original details and also may hide underlying moisture problems.*

Discussion and Recommendations

Staff recommends approval as submitted.

Suggested Motion

Having considered the standards set forth within the City Code, including City Design Guidelines for Rehabilitation, I move to find that the proposed balustrade and roof replacement project satisfies the BAR's criteria and is compatible with this property and other properties in this district, and that the BAR approves the application as submitted.



Board of Architectural Review (BAR) Certificate of Appropriateness

Please Return To: City of Charlottesville
Department of Neighborhood Development Services
P.O. Box 911, City Hall
Charlottesville, Virginia 22902
Telephone (434) 970-3130 Fax (434) 970-3359

Please submit ten (10) copies of application form and all attachments.
For a new construction project, please include \$375 application fee. For all other projects requiring BAR approval, please include \$125 application fee. For projects that require only administrative approval, please include \$100 administrative fee. Make checks payable to the City of Charlottesville.

The BAR meets the third Tuesday of the month.
Deadline for submittals is Tuesday 3 weeks prior to next BAR meeting by 4 p.m.

Owner Name 500 CT. SQUARE ASSOCIATION Applicant Name JAMES C WEATHERFORD
Project Name/Description RE ROOFING 500 CT. SQ Parcel Number _____
Property Address 500 CT. SQ CHARLOTTESVILLE VA

Applicant Information

Address: 100 TENTH ST. SUITE 100
CHARLOTTESVILLE VA
Email: CHRIS.WEATHERFORD@VIRGINIA.GOV
Phone: (W) 434.984.8800 (H) _____
FAX: 434 984 8815

Signature of Applicant

I hereby attest that the information I have provided is, to the best of my knowledge, correct. (Signature also denotes commitment to pay invoice for required mail notices.)

[Signature] 2.23.13
Signature Date

Property Owner Information (if not applicant)

Address: 500 CT SQ
Email: KADBE@adelphia.net
Phone: (W) 434.979.8900 (H) 966.2438
FAX: _____

JAMES C WEATHERFORD 2.23.13
Print Name Date

Property Owner Permission (if not applicant)

I have read this application and hereby give my consent to its submission.

Do you intend to apply for Federal or State Tax Credits for this project? N

Signature _____ Date _____

Print Name _____ Date _____

Description of Proposed Work (attach separate narrative if necessary):

REPLACE EXISTING EPDM ROOF AND EXISTING BALUSTRADE TO MATCH

List All Attachments (see reverse side for submittal requirements):

DRAWING A-1 through A-6


For Office Use Only
Received by: D. Evans
Fee paid: 12500 Cash/Ck. # _____
Date Received: 2/23/11
Approved/Disapproved by: _____
Date: _____
Conditions of approval: _____

500 COURT SQUARE ROOF REPLACEMENT

500 COURT SQUARE
CHARLOTTESVILLE, VIRGINIA
1217



REVISIONS	
NO.	DATE

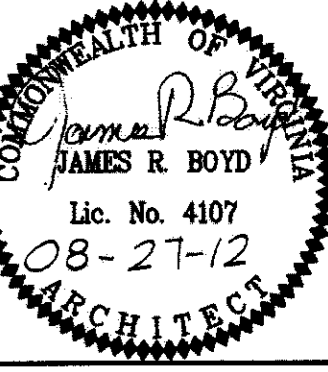

ISSUE: PRELIM. DOCUMENTS

HEYWARD BOYD ARCHITECTS, P.C.
111 West High Street
Charlottesville, Virginia 22902
434-296-5353 434-971-6634 F

CHECKED BY: JRB
DRAWN BY:
FILE NAME:


ABBREVIATIONS

ABV. ABOVE	INSUL. INSULATION
ACT. ACOUSTIC CEILING TILE	J. JOINT
ADA. AMERICANS WITH DISABILITIES ACT	KVA. KILOWATT
ADJ. ADJUST(ABLE)	LAM. LAMINATE
AFF. ABOVE FINISH FLOOR	LIN. LINEAR
AHU. AIR HANDLING UNIT	LT. LIGHT
ALT. ALTERNATE	LVL. LAMINATED VENEER LUMBER
ALUM. ALUMINUM	MAS. MASONRY
ANOD. ANODIZED	MATL. MATERIAL
APPROX. APPROXIMATELY	MAX. MAXIMUM
ARCH. ARCHITECTURAL	M.C.C.J. MASONRY CONTROL JOINT
AV. AUDIO VISUAL	MECH. MECHANICAL
BD. BOARD	MFR. MANUFACTURER
BEL. BELOW	MIN. MINIMUM
BLDG. BUILDING	MISC. MISCELLANEOUS
BLK. BLOCK	M.O. MASONRY OPENING
BLKG. BLOCKING	MTD. MOUNTED
BM. BEAM	MTL. METAL
B.O.C. BOTTOM OF CURB	NEUT. NEUTRAL
B.O.W. BOTTOM OF WALL	N.I.C. NOT IN CONTRACT
BRDG. BRIDGING	NO. NUMBER
BRK. BRICK	NOM. NOMINAL
BRNG. BEARING	NTS. NOT TO SCALE
BTU. BRITISH THERMAL UNIT	O.C. ON CENTER
BTUH. BTU PER HOUR	O.D. OUTSIDE DIAMETER
BTW. BETWEEN	OF. OWNER FURNISHED
CAPY. CAPACITY	O.F.C.I. CONTRACTOR INSTALLED
CF. CUBIC FOOT	OF.O.I. OWNER FURNISHED
CFM. CUBIC FOOT PER MINUTE	OPP. OPPOSITE
CI. CAST IRON	OPP. HD. OPPOSITE HAND
C.J. CONTROL JOINT	OVHD. OVERHEAD
CL. CLOSET	PAV. PAVING
CL.G. CEILING	P.LAM. PLASTIC LAMINATE
CLR. CLEAR	PLYWD. PLYWOOD
CMU. CORRUGATED METAL PIPE	PR. PAIR
CMU. CONCRETE MASONRY UNIT	PROJ. PROJECTION
C.O. CLEAN OUT	P.S.F. POUNDS PER SQUARE FOOT
COL. COLUMN	P.T. PRESSURE TREATED
CONC. CONCRETE	PTD. PAINTED
COND. CONDENSER/CONDUIT	P.V. TILE PORCELAIN TILE
CONN. CONNECTION	P.V.C. POLY-VINYL CHLORIDE
CONST. CONSTRUCTION	Q.T. QUARRY TILE
CONT. CONTINUOUS	RAD. RADIUS
CPT. CARPET	R.B. RESILIENT BASE
C. TILE CERAMIC TILE	R.C.P. REINFORCED CONCRETE PIPE
CTR. CENTER	R.D. ROOF DRAIN
CW. COLD WATER	RFR. REINFORCING BAR
DBL. DOUBLE	REC. RECORD
DES. DESIGN	REFRIG. REFRIGERATION
DET. DETAIL(S)	REIN. REINFORCE(D)
DIA. DIAMETER	REQ'D. REQUIRED
DIAG. DIAGONAL	RM. ROOM
DIFF. DIFFUSER(S)	R.O. ROUGH OPENING
DIM. DIMENSION	RFR. REMOVE & REPLACE
DIV. DIVISION	RS. RISER
DN. DOWN	RT. RIGHT
DS. DOWNSPOUT	R. TILE RUBBER TILE
DWG. DRAWING	S.C. SOLID CORE
EA. EACH	SCHED. SCHEDULE
EJ. EXPANSION JOINT	SHT. SHEET
ELEC. ELECTRIC(AL)	SIM. SIMILAR
ELEV. ELEVATION	S.O. SASH OPENING
ENCL. ENCLOSE/ENCLOSURE	SP. SPACE
EQ. EQUAL	SPEC. SPECIFICATIONS
EQUIP. EQUIPMENT	SQ. SQUARE
ESMT. EASEMENT	S.S. STAINLESS STEEL
EVAP. EVAPORATIVE(OR)	STD. STANDARD
EXG. EXISTING	STL. STEEL
EXH. EXHAUST	STOR. STORAGE
EXP. EXPANSION	STRUCT. STRUCTURE(AL)
EXP. ST. EXPOSED STRUCTURE	SUSP. SUSPENDED
EXT. EXTERIOR	SW. SWITCH
F.A.I. FRESH AIR INTAKE	SYM. SYMMETRIC(AL)
F.B. FACE BRICK	SYS. SYSTEM
F.C.O. FLOOR CLEAN-OUT	TBR. TO BE REMOVED
F.D. FLOOR DRAIN	TERR. TERRAZZO
FEC. FIRE EXTINGUISHER CABINET	THK. THICKNESS
FDN. FOUNDATION	THRU. THROUGH
FIN. FINISH(ED)	T.O.C. TOP OF CURB
FL. FINISHED FLOOR	T.O.P. TOP OF PAVEMENT
FL. FLOOR	T.O.S. TOP OF STEP
F.O.B. FACE OF BRICK	T.O.W. TOP OF WALL
F.O.S. FACE OF STUD	TR. TREAD
FT. FOOT/FEET	TS. TUBULAR STEEL
F.TRD. FIRE TREATED	TSTAT. THERMOSTAT
FTG. FOOTING	TYP. TYPICAL
G. GAS	UG. UNDERGROUND
G.A. GAGE	UL. UNDERWRITERS LABORATORY
GALV. GALVANIZED	VCT. VINYL COMPOSITION TILE
GFI. GROUND FAULT INTERRUPTER	VERT. VERTICAL
GL. GLASS	VTR. VENT THROUGH ROOF
GND. GROUND	VWC. VINYL WALL COVERING
G.P.H. GALLONS PER HOUR	W. WITH
GWB. GYPSUM WALL BOARD	W/O. WITHOUT
H.C. HANDICAPPED ACCESSIBLE	WB. WET BULB
HDWD. HARDWOOD	WC. WATER CLOSET
HDWR. HARDWARE	WD. WOOD
H.M. HOLLOW METAL	WDW. WINDOW
HORIZ. HORIZONTAL	WP. WEATHERPROOF
HR. HOUR	WR. WATER RESISTANT
HT. HEIGHT	WT. WEIGHT
HVAC. HEATING VENTILATING & AIR CONDITIONING	

VICINITY MAP



LOCATION MAP

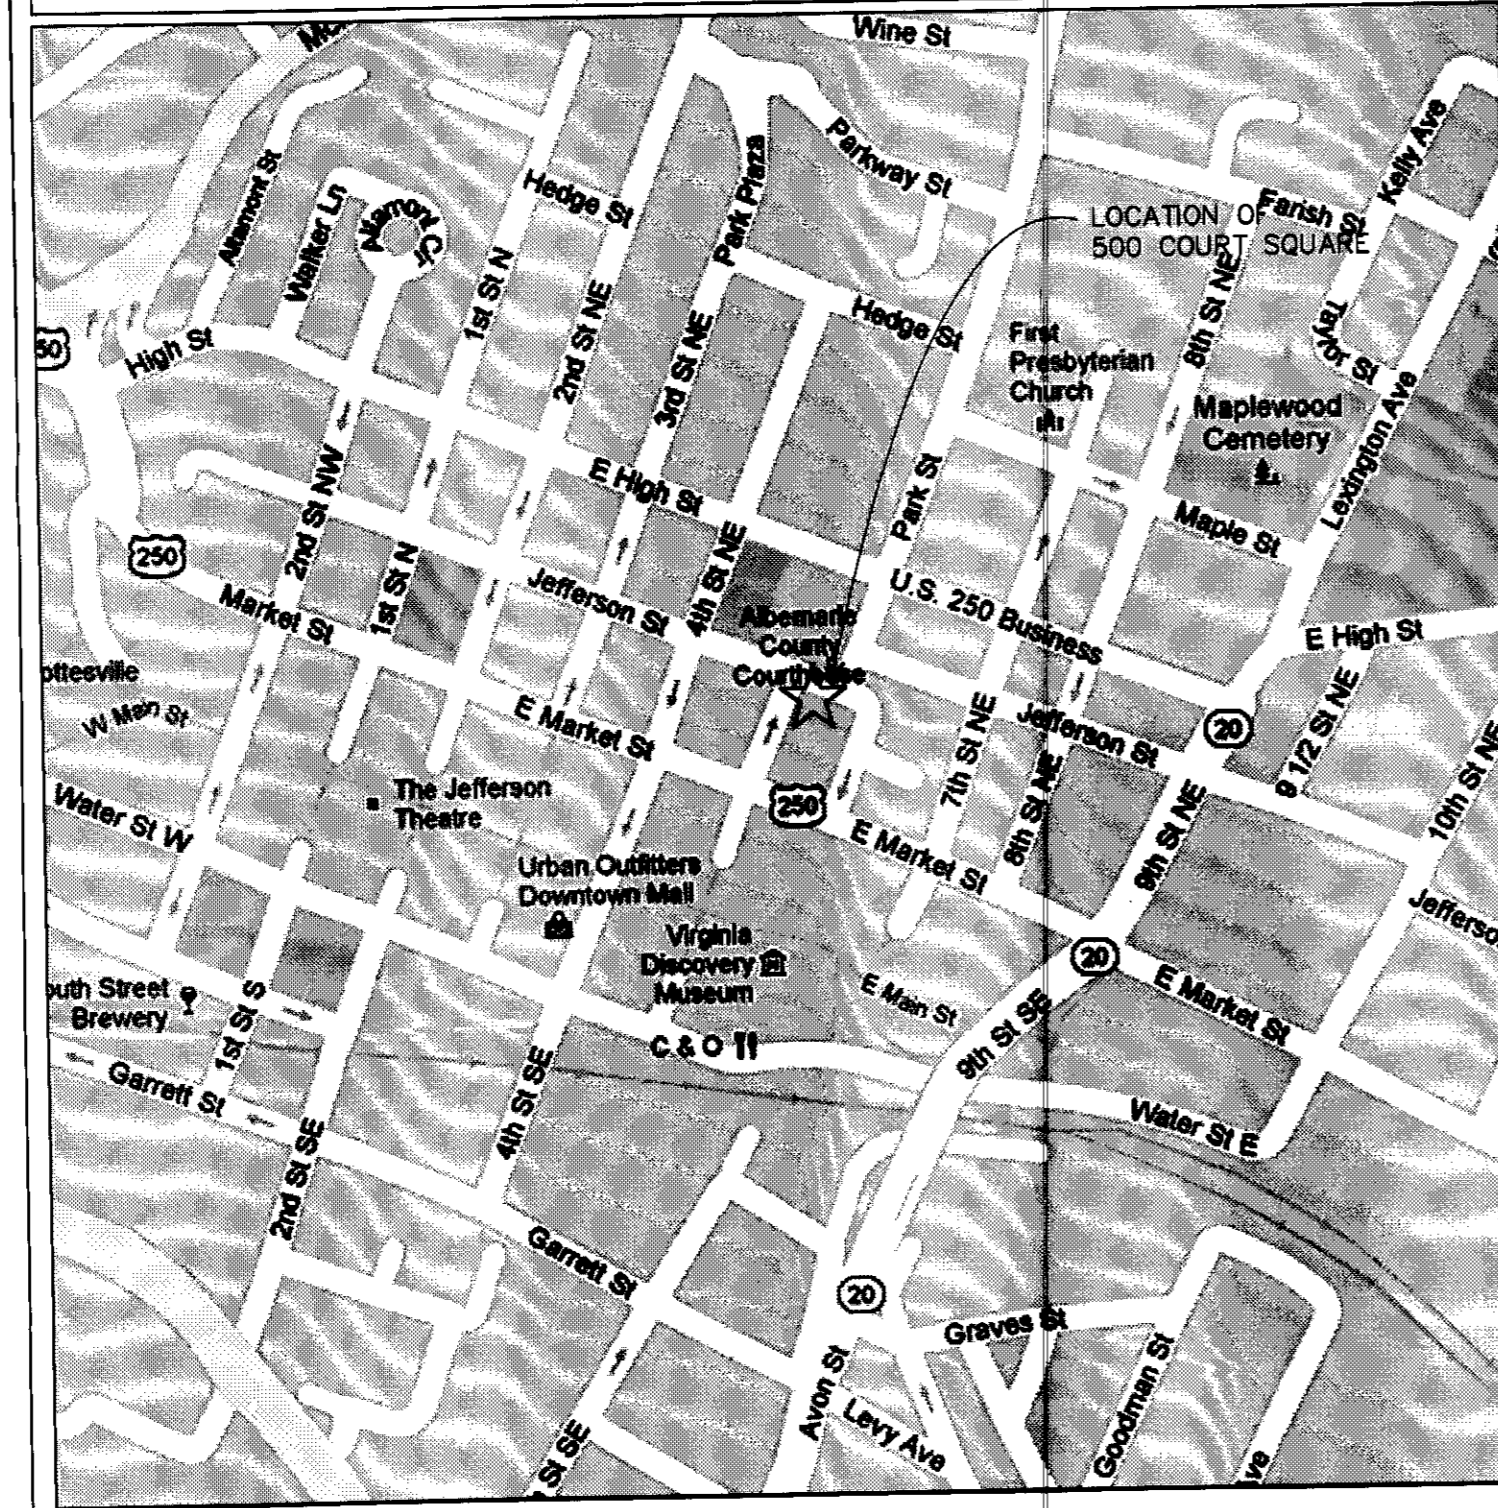

PROJECT/CODE DATA

EXISTING DEVELOPMENT

DESCRIPTION: 500 COURT SQUARE, CHARLOTTESVILLE VIRGINIA
 PHYSICAL ADDRESS: 500 COURT SQUARE, CHARLOTTESVILLE VIRGINIA
 NUMBER OF STORIES: 11
 BUILDING HEIGHT: 121'-0" ±

CODE DATA

APPLICABLE CODES: 2009 IBC WITH VIRGINIA AMENDMENTS
 USE GROUP CLASSIFICATION: RESIDENTIAL
 CONSTRUCTION TYPE: R-4

PROJECT DIRECTORY

ARCHITECT

HEYWARD, BOYD ARCHITECTS, PC
 JAMES R. BOYD, AIA
 111 WEST HIGH STREET
 CHARLOTTESVILLE, VA 22902
 PHONE: 434-296-5353
 FAX: 434-971-6634

SHEET INDEX

COV	COVER SHEET
A1	PLANS
A2	DETAILS
A3	DETAILS
A4	DETAILS
A5	SPECIFICATIONS
A6	SPECIFICATIONS

SITE STAGING NOTES


CONTRACTOR SHALL COORDINATE ALL STAGING AND ACCESS TO SITE/BUILDING WITH OWNER.
 ALL INTERUPTIONS IN TRAFFIC FLOW ON PROPERTY AS WELL AS OCCUPANCY OF PARKING SPACES MUST BE COORDINATED WITH OWNER.
 FREE AND CLEAR ACCESS AND EGRESS MUST BE MAINTAINED AROUND BUILDING AT ALL TIMES, EXCEPT AS REQUIRED BY THE WORK. COORDINATE WITH OWNER.

COVER SHEET


DRAWING TITLE:
 PROJECT NUMBER:
 SHEET NUMBER:

PROJECT NUMBER: 1206.06
 SHEET NUMBER: **COV**
 DATE: 8.27.12

500 COURT SQUARE
 ROOF REPLACEMENT
 500 COURT SQUARE
 CHARLOTTESVILLE, VIRGINIA

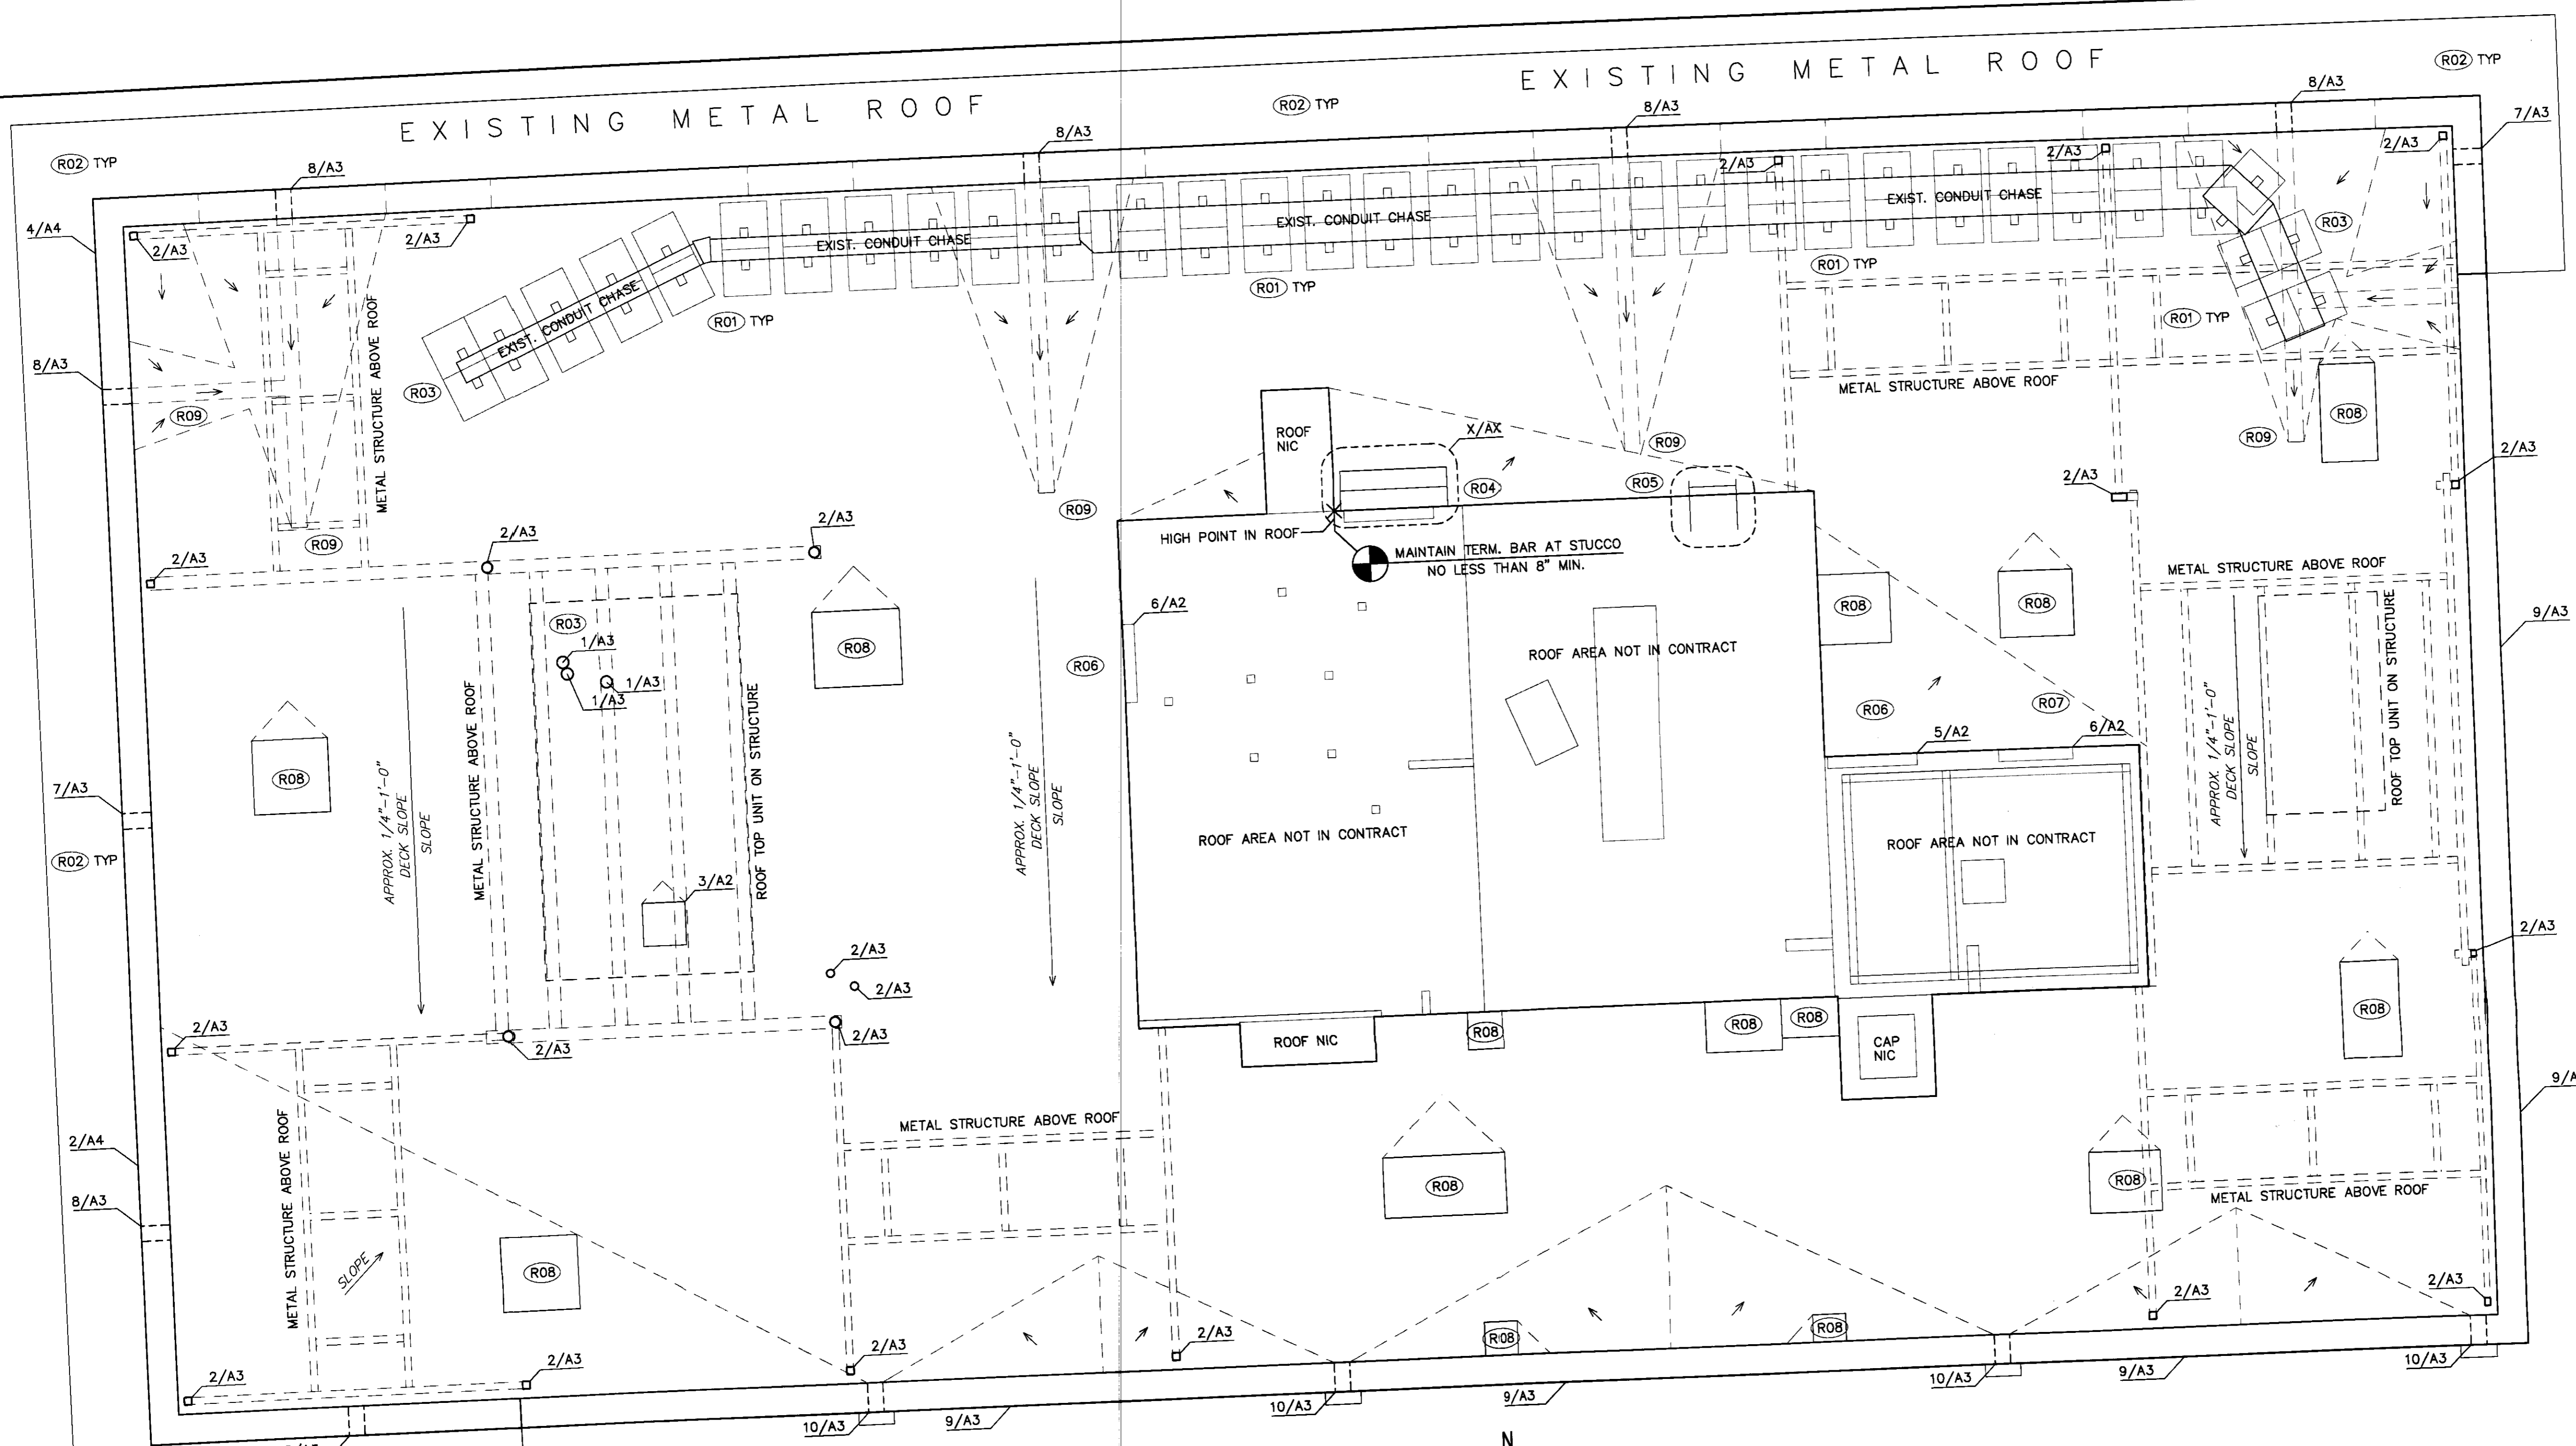

1 NEW ROOF PLAN
 A1 SCALE: 1/4" = 1'-0"

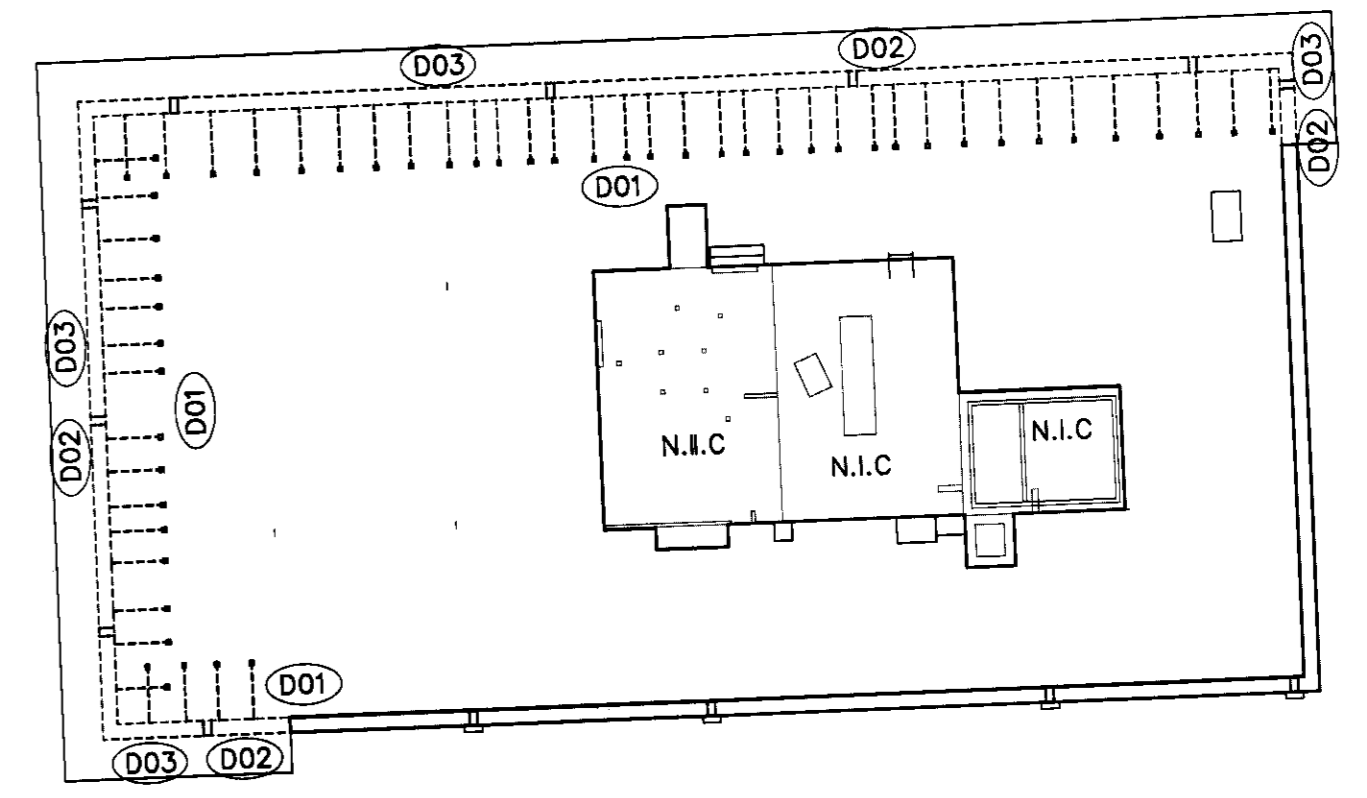

2 DEMOLITION PLAN
 A1 NOT TO SCALE

KEYED ROOF REPLACEMENT NOTES:

- (R01) INSTALL A LAYER OF WALK PAD UNDER SLEEPERS CONTINUOUS.(TYP)
- (R02) REPLACE ALL METAL CORNICE AND BALUSTRADE AS DETAILED AND SPECIFIED
- (R03) EXISTING ANTENNAE AND CONDUIT ON ROOF TO REMAIN.
- (R04) EXISTING METAL STAIR SHALL BE RE-INSTALLED.
- (R05) EXISTING LADDER SHALL HAVE RAILS CUT JUST BELOW BOTTOM RUNG.
- (R06) RAISE EXISTING DOOR SILL AND INSTALL NEW DOOR TO DIMENSIONS AS FIELD VERIFIED
- (R07) RAISE EXISTING WINDOW AND INSTALL NEW WINDOW TO DIMENSIONS AS FIELD VERIFIED
- (R08) FULLY COVER EXIST. CURBS AS SPECIFIED TO MEET OR EXCEED NEW ROOF WARRANTY
- (R09) NEW TROUGH FROM SCUPPER AT 1/8" : 1' TO MEET NEW FINISHED ROOF AT 1/4":1'


KEYED ROOF REPLACEMENT NOTES:

- (D01) REMOVE PARAPET SUPPORTS DOWN TO STRUCTURAL DECKING
- (D02) REMOVE METAL BALUSTRADE
- (D03) EXISTING METAL ROOF TO REMAIN

GENERAL ROOF REPLACEMENT NOTES:


1. COORDINATE ALL NEW WORK WITH ANY MECHANICAL AND ELECTRICAL EQUIP. AND DEMOLITION WORK.
2. REMOVE ALL EXISTING BALLAST, EPDM MEMBRANE, FLASHINGS, (UNLESS OTHERWISE NOTED), AND INSULATION DOWN TO STRUCTURAL DECK (CONCRETE)
3. PROTECT ALL FINISHED SURFACES DURING CONSTRUCTION. PATCH FINISHES AFFECTED/DAMAGED BY NEW WORK.
4. DO NOT PILE BALLAST ON ROOF. PROPERLY DISPOSE OF OFF-SITE.
5. OWNER TO EVALUATE DECK PRIOR TO RECOVERING - IF DAMAGE OR UNEVEN DECKING IS ENCOUNTERED, IMMEDIATELY NOTIFY THE CONSTRUCTION MANAGER.
6. USE TAPERED INSULATION TO SLOPE EPDM AWAY FROM ROOF EDGE TOWARD ROOF DRAINS/SCUPPERS AS REQUIRED.(TYP.) SLOPE denotes TAPERED INSULATION SLOPE DIRECTION. PROVIDE TAPER DIAGRAM OF NEW INSULATION BEFORE INSTALLATION. MAIN FIELD PORTION OF ROOF SHALL BE INSTALLED OVER SLOPED DECK AND REQUIRES NO TAPERED INSULATION. SEE PLAN FOR LOCATIONS OF TAPERED/CRICKET MATERIAL.
7. REPLACE ANY EXISTING VENT EXTENSIONS THAT ARE DAMAGED. (VERIFY IN FIELD) EXTEND PLUMBING VENTS TO BE 12" MINIMUM ABOVE NEW FINISHED ROOF IF REQUIRED.
8. ALL ROOF AREAS TO BE REPLACED SHALL RECEIVE A BASE LAYER OF (2) SHEETS 1 1/2" POLYISOCYANURATE INSULATION FULLY ADHERED TO DECK. SEE PLANS FOR CRICKET LOCATIONS AND SLOPE.
9. ALL MEASUREMENTS ON DRAWINGS ARE APPROXIMATE. ALL MEASUREMENTS SHALL BE VERIFIED BY THE ROOFING CONTRACTOR.
10. CONTRACTOR IS RESPONSIBLE FOR COORDINATING OF DISCONNECTION AND RECONNECTION OF ALL ELECTRICAL EQUIPMENT W/ OWNER.
11. SEE SPECIFICATIONS FOR BASE LAYER POLYISOCYANURATE INSULATION FASTENING TO DECK.
12. ALL EXPOSED EDGES OF NEW SEAM TAPE INSTALLATIONS SHALL RECEIVE A CONTINUOUS BEAD OF APPROVED SEALANT - SEE ROOFING DETAILS FOR MORE INFORMATION.
13. INSTALL NEW CRICKET ON HIGHER SLOPE SIDE OF ALL SIGNIFICANT CURBS. SEE PLAN FOR LOCATIONS.
14. VERIFY HEIGHT ABOVE DECK OF ALL METAL CORNICE/BALUSTRADE AND SCUPPER COMPONENTS. CONTRACTOR TO FIELD VERIFY LOCATIONS OF ALL ROOF TOP EQUIPMENT. COORDINATE ANY VARIATIONS IN PLAN WITH OWNER REPRESENTATIVE.
15. REPLACE ANY DAMAGED CONDENSATE LINES TO MATCH EXISTING. VERIFY PROPER DRAINAGE AT EACH LOCATION PRIOR TO AND AFTER INSTALLATION OF NEW PIPING.
16. ALL EXISTING ROOF DECK SLOPES DOWN FROM NORTH TO SOUTH.
17. ALL NEW SCUPPER SLEEVES SHALL BE FULLY SOLDERED LEAD COATED COPPER.

NOTES:
1. END LAPS OF EPDM MUST OVERLAP SPLICE TAPE A MINIMUM OF 6" (25.4 mm).
2. END LAPS OF 5" FLASHING MUST OVERLAP A MINIMUM OF 2" (76.2 mm).

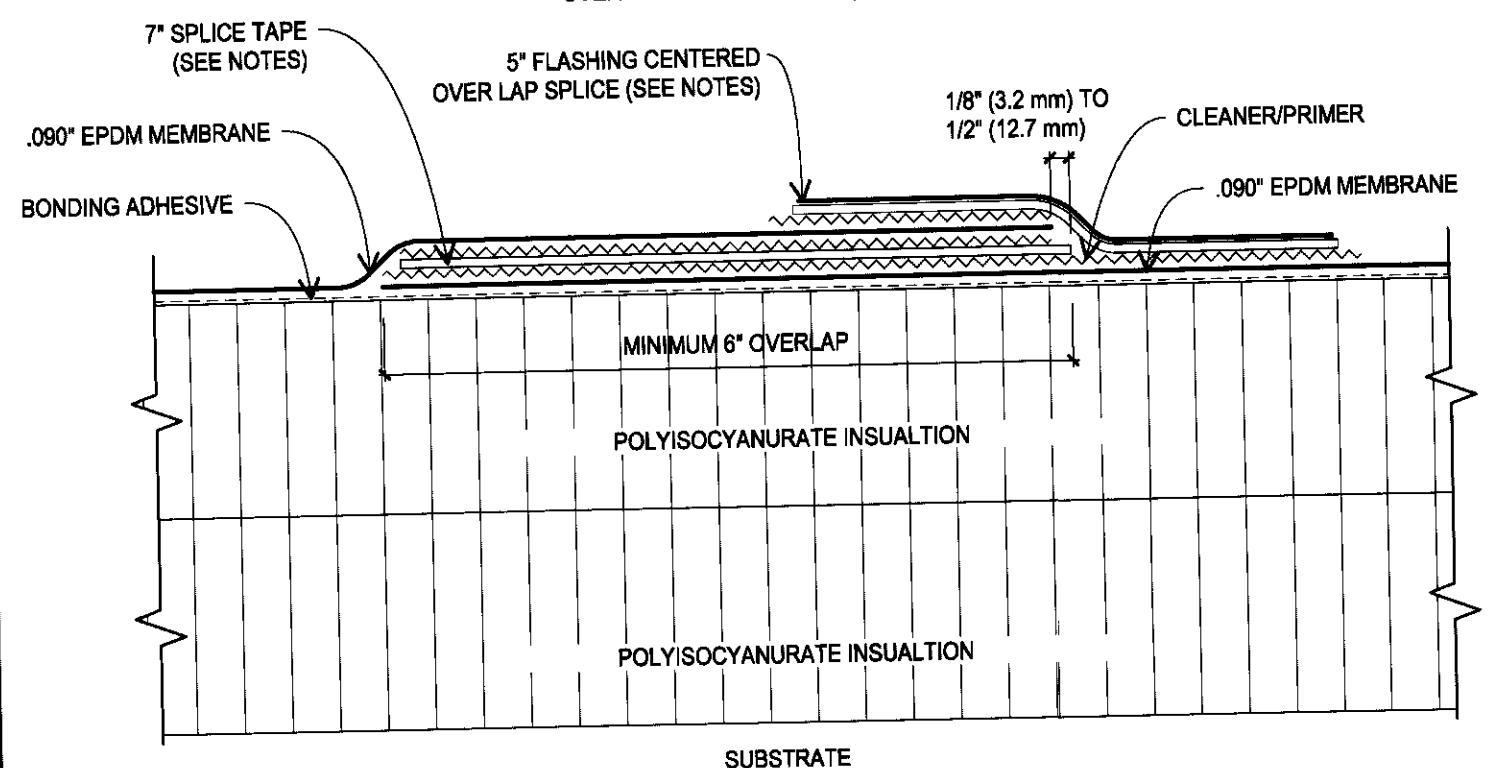


1 TYP SEAM DETAIL
A2 NOT TO SCALE


NOTE:
REMOVE EXISTING STUCCO TO 12" FROM DECK

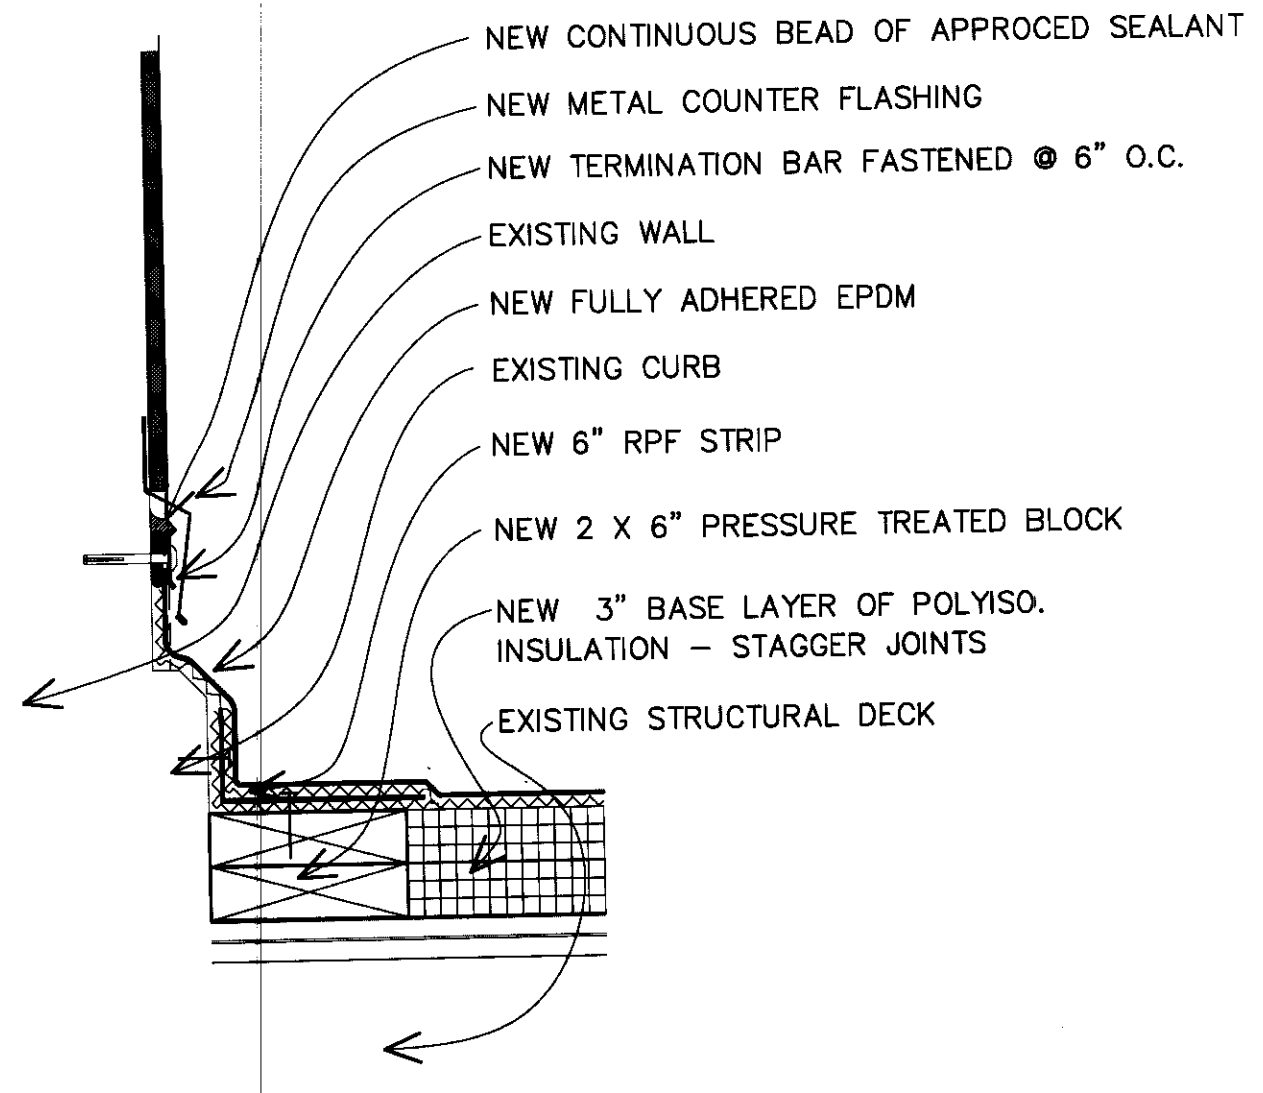


2 TYP STUCCO DETAIL
A2 SCALE: 2" = 1'-0"

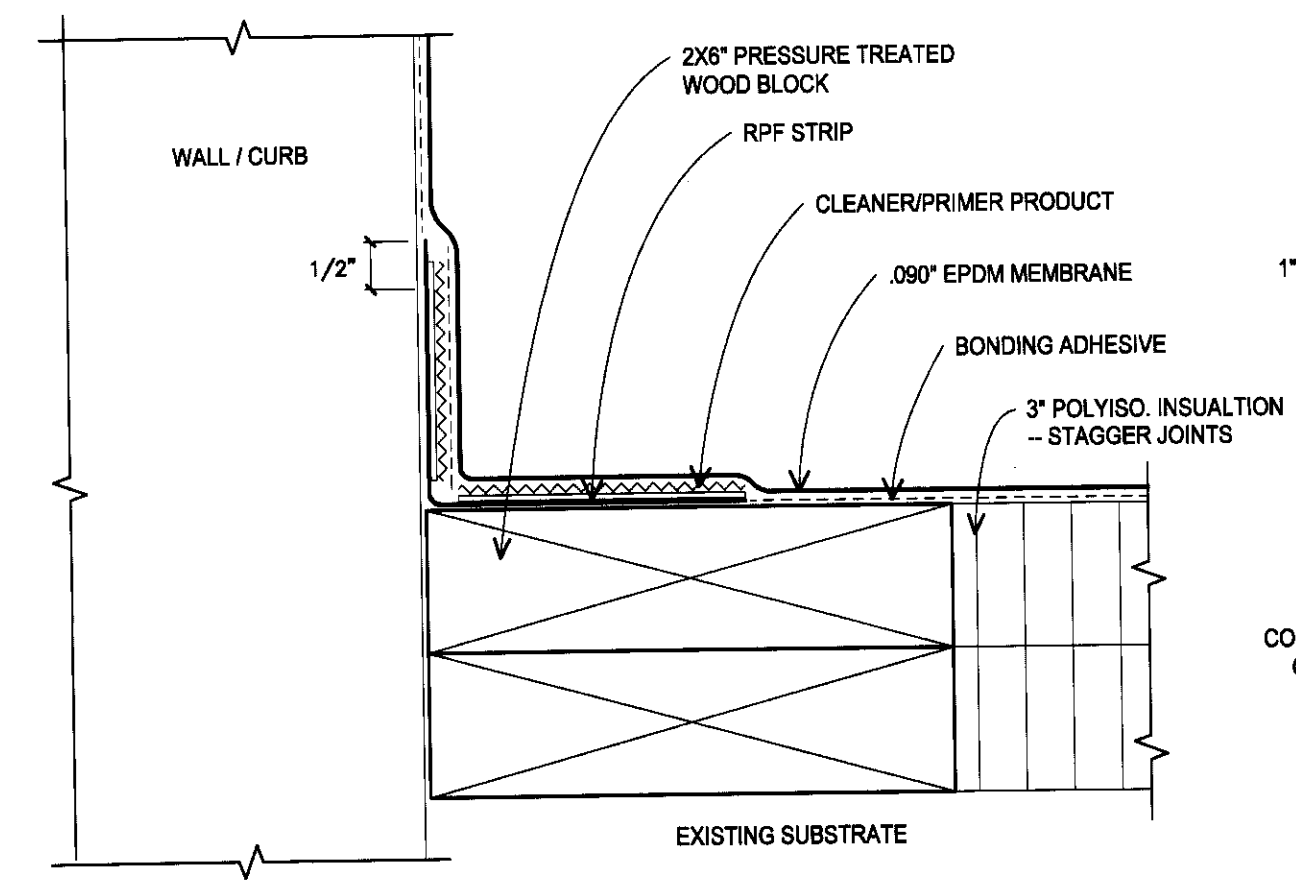


3 TYP RISING WALL DETAIL
A2 SCALE: 6" = 1'-0"

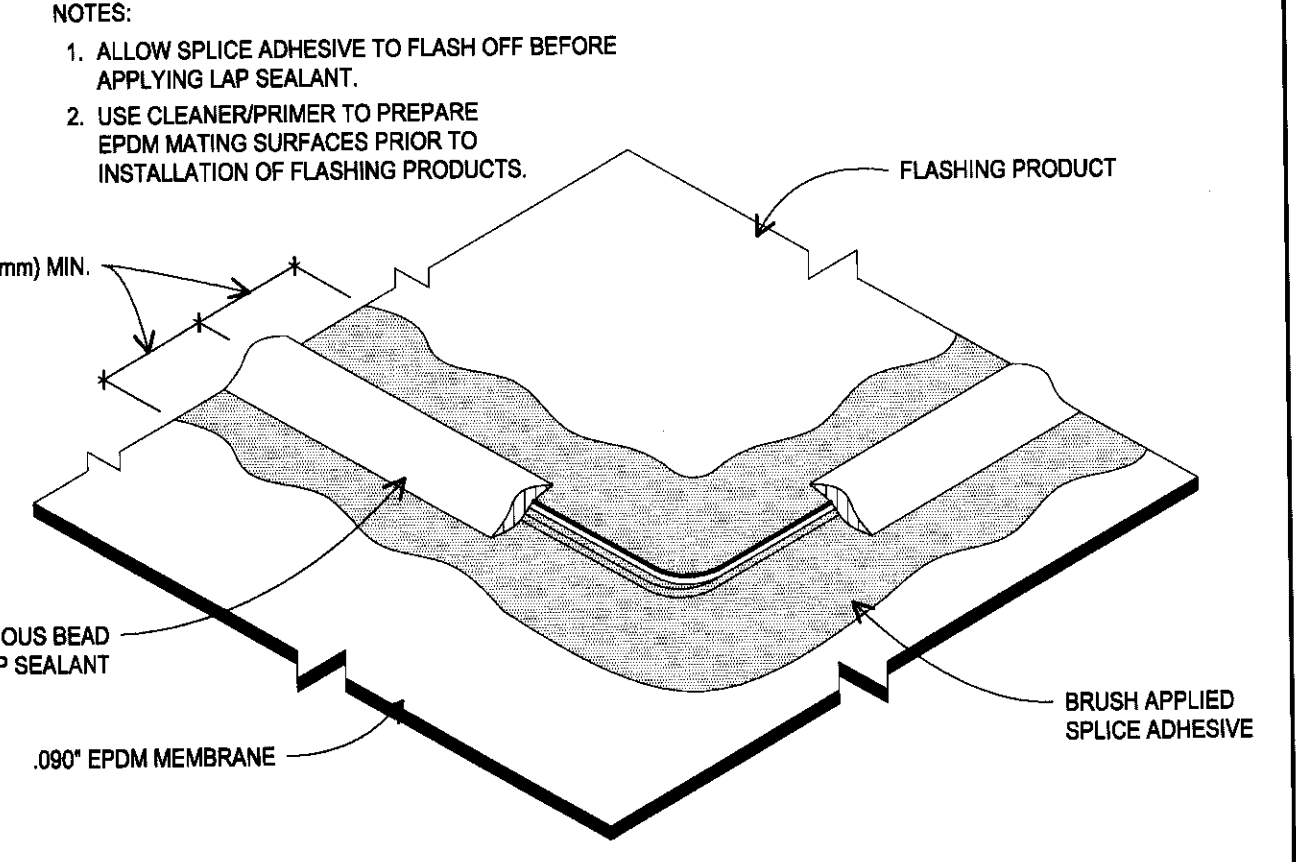


4 TYP LAP SEALANT
A2 SCALE: 6" = 1'-0"

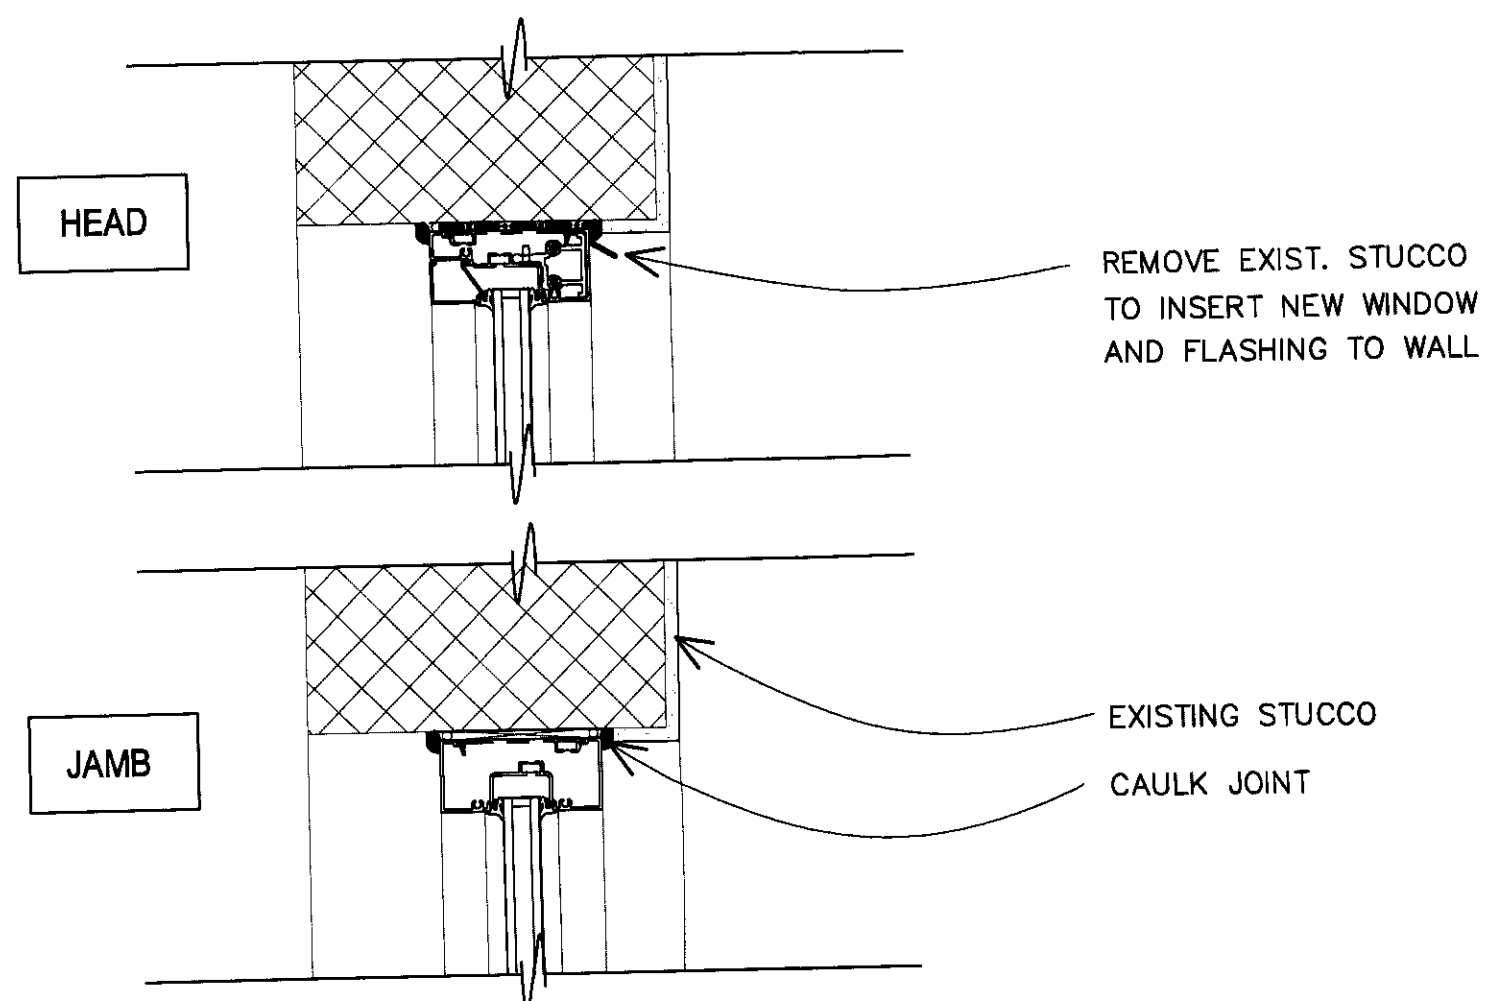




5 TYP WINDOW DETAIL
A2 SCALE: 2" = 1'-0"

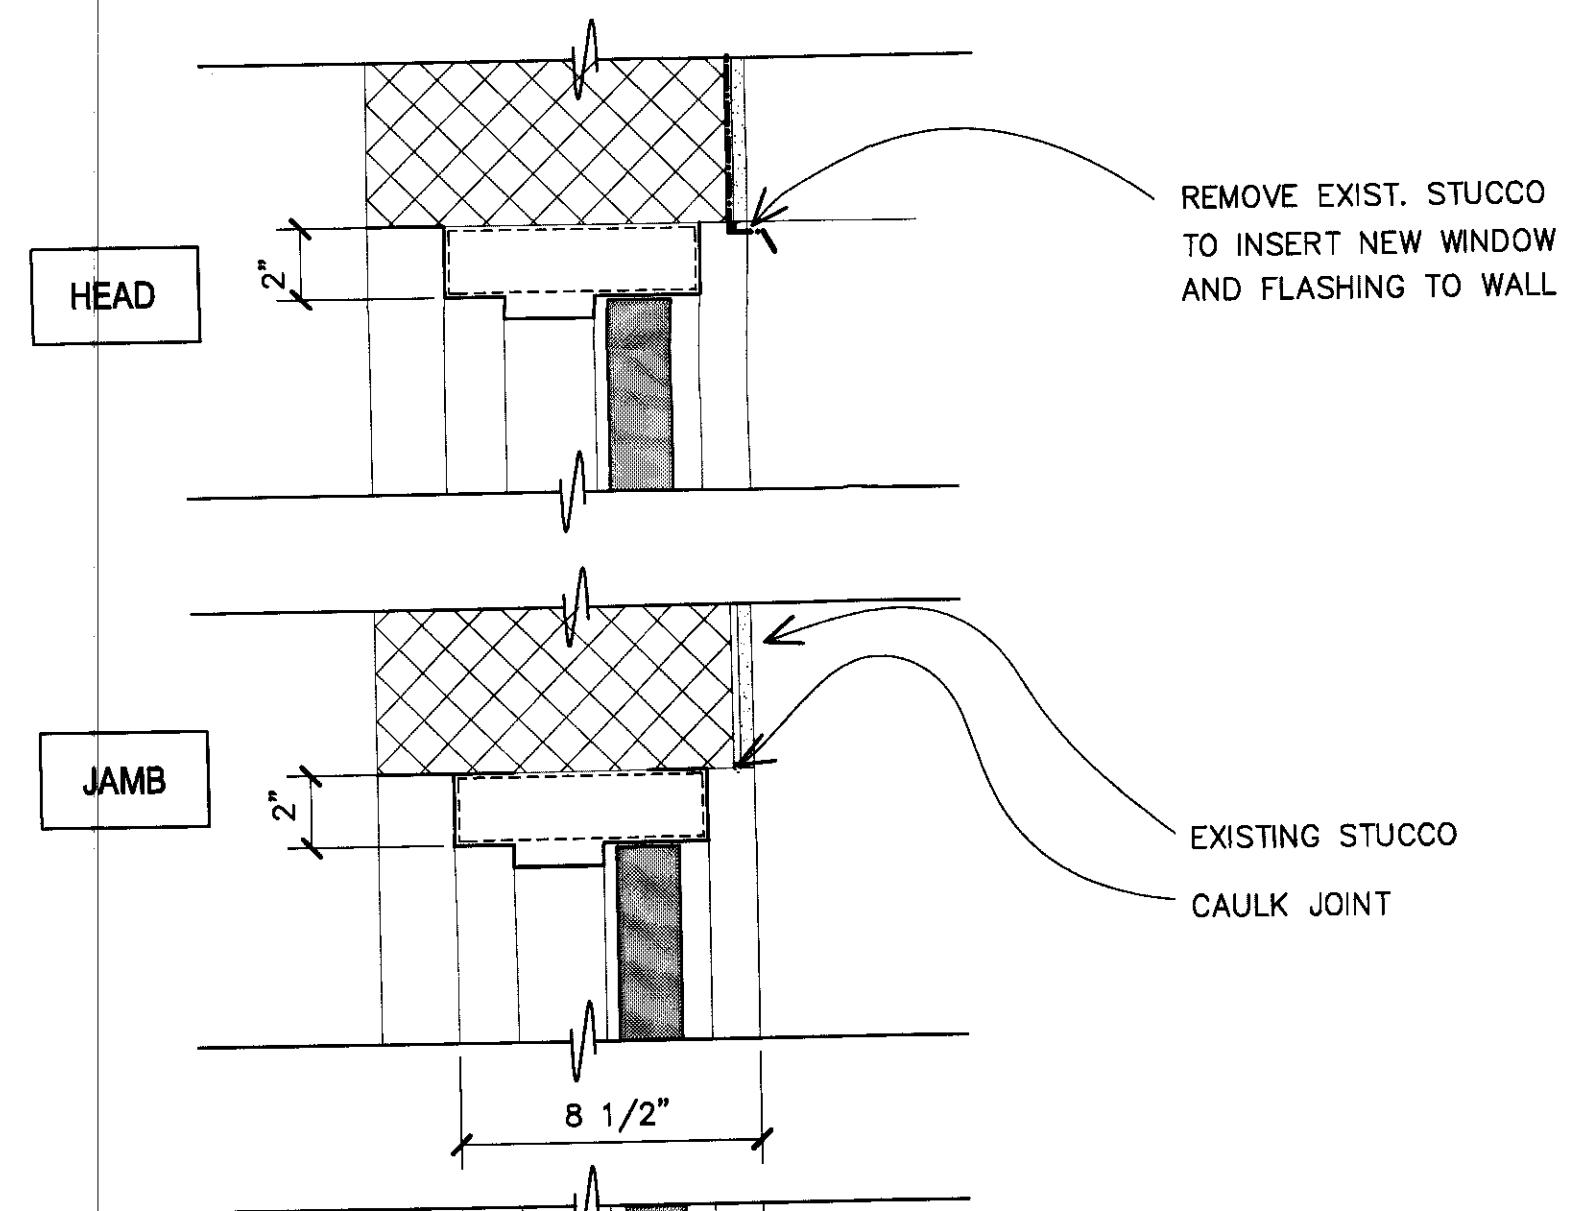

6 TYP DOOR DETAIL
A2 SCALE: 2" = 1'-0"

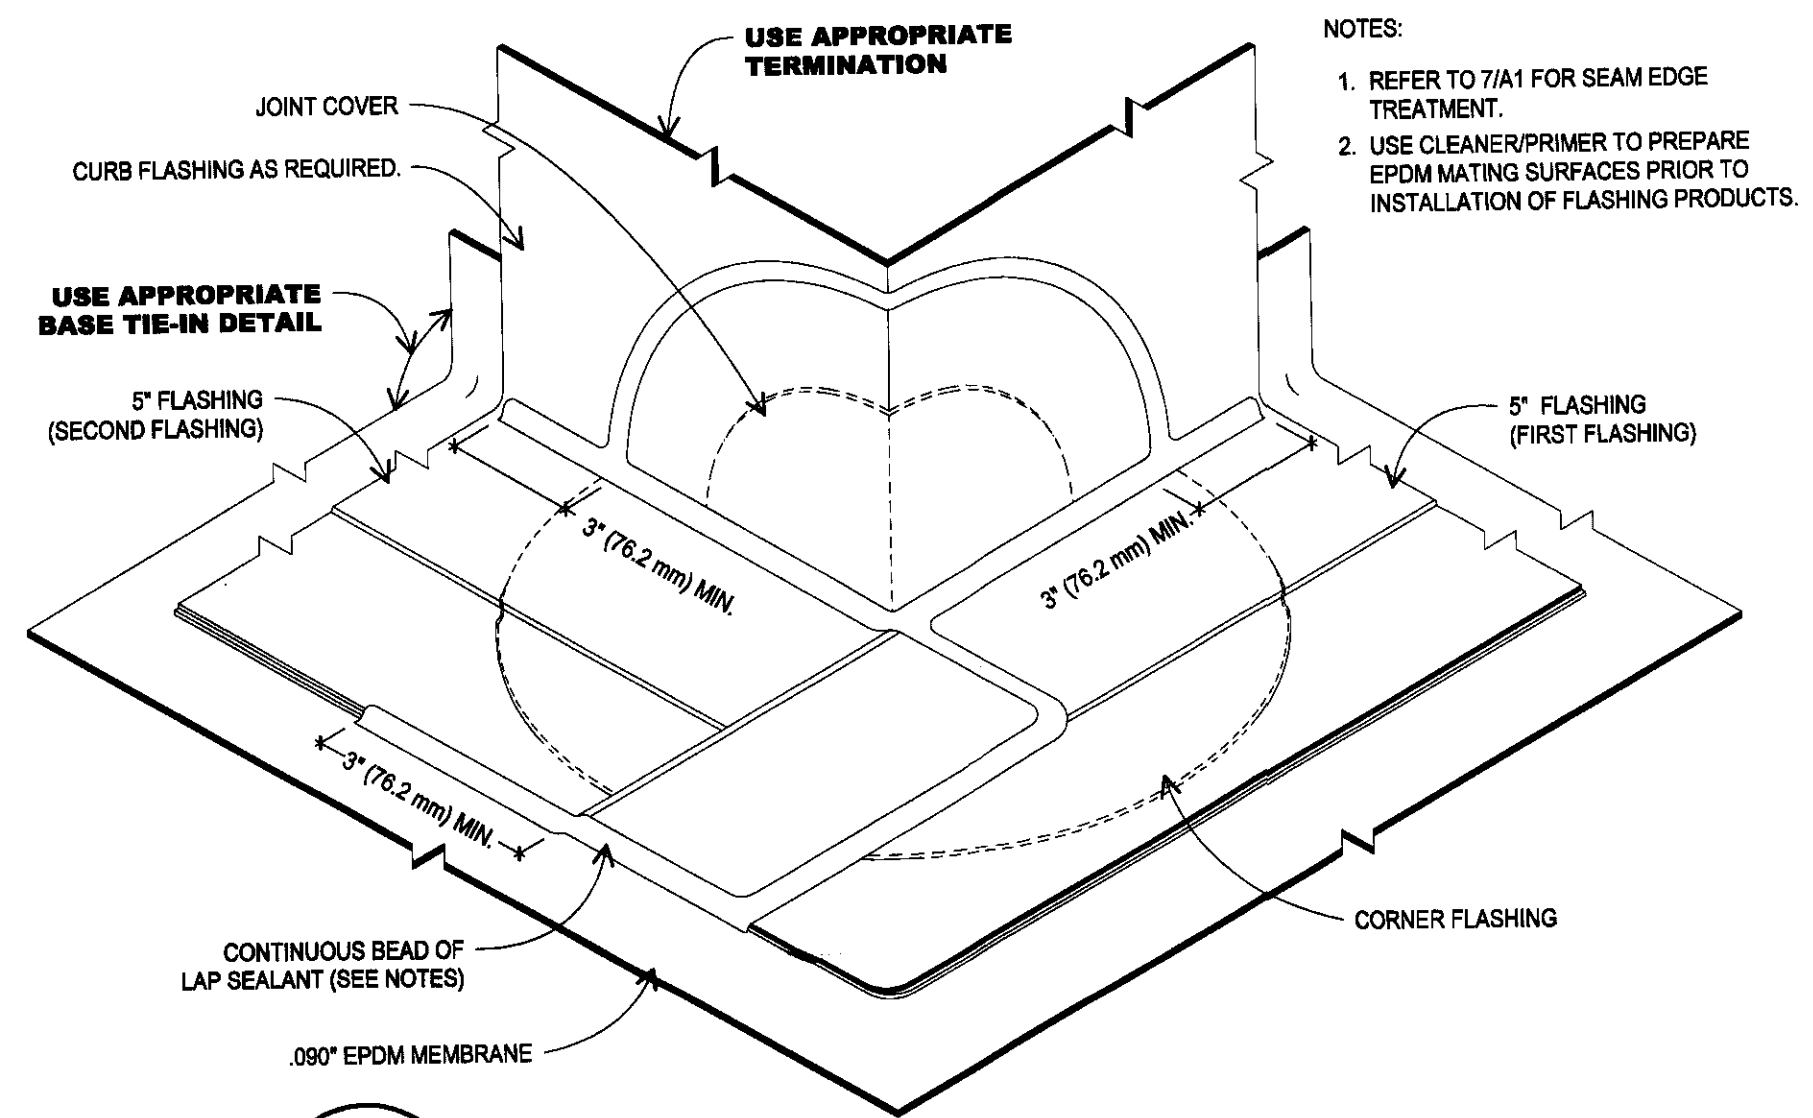


7 TYP OUTSIDE QUICK SEAM CORNER DETAIL
A2 SCALE: 6" = 1'-0"

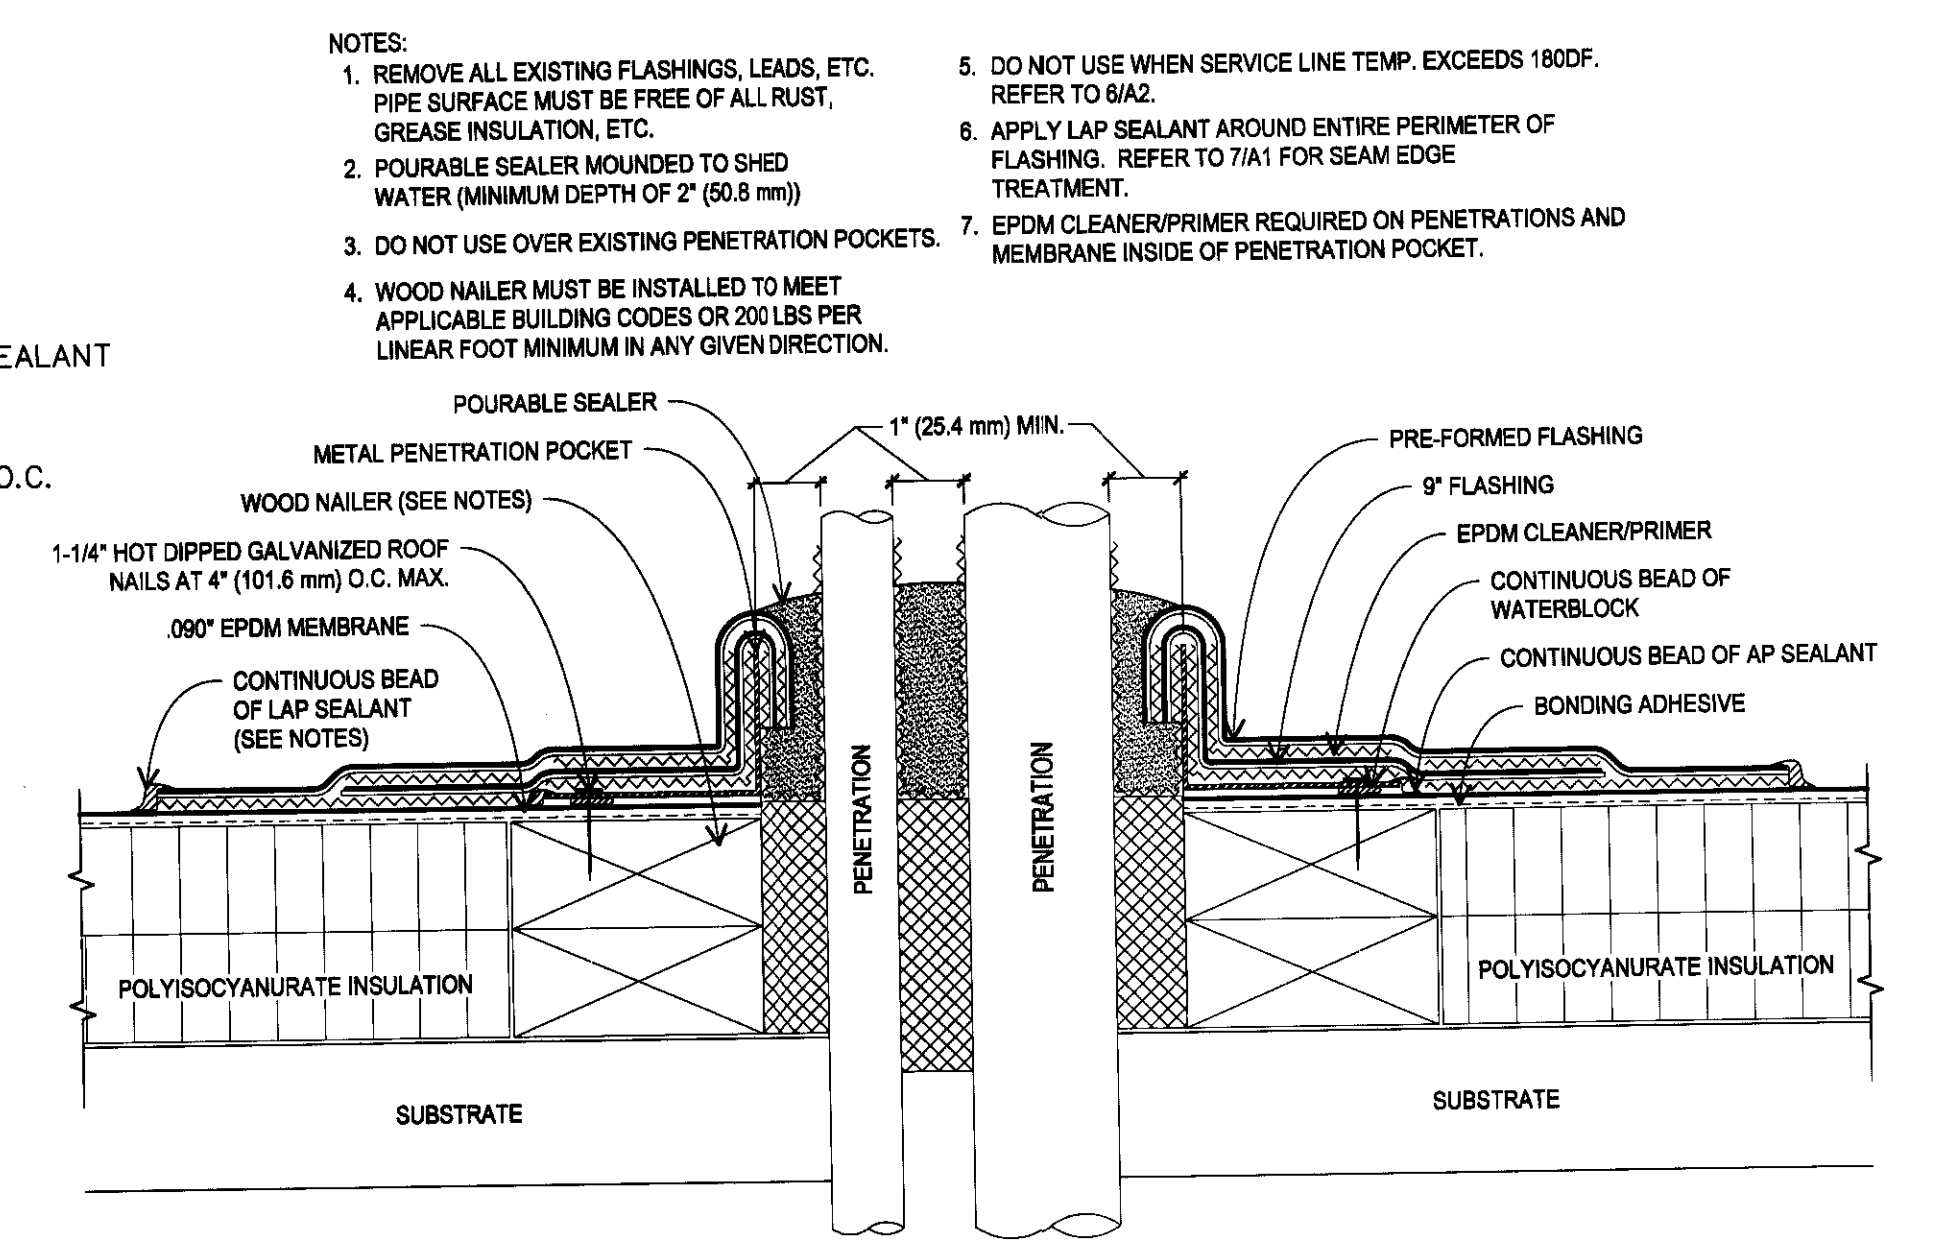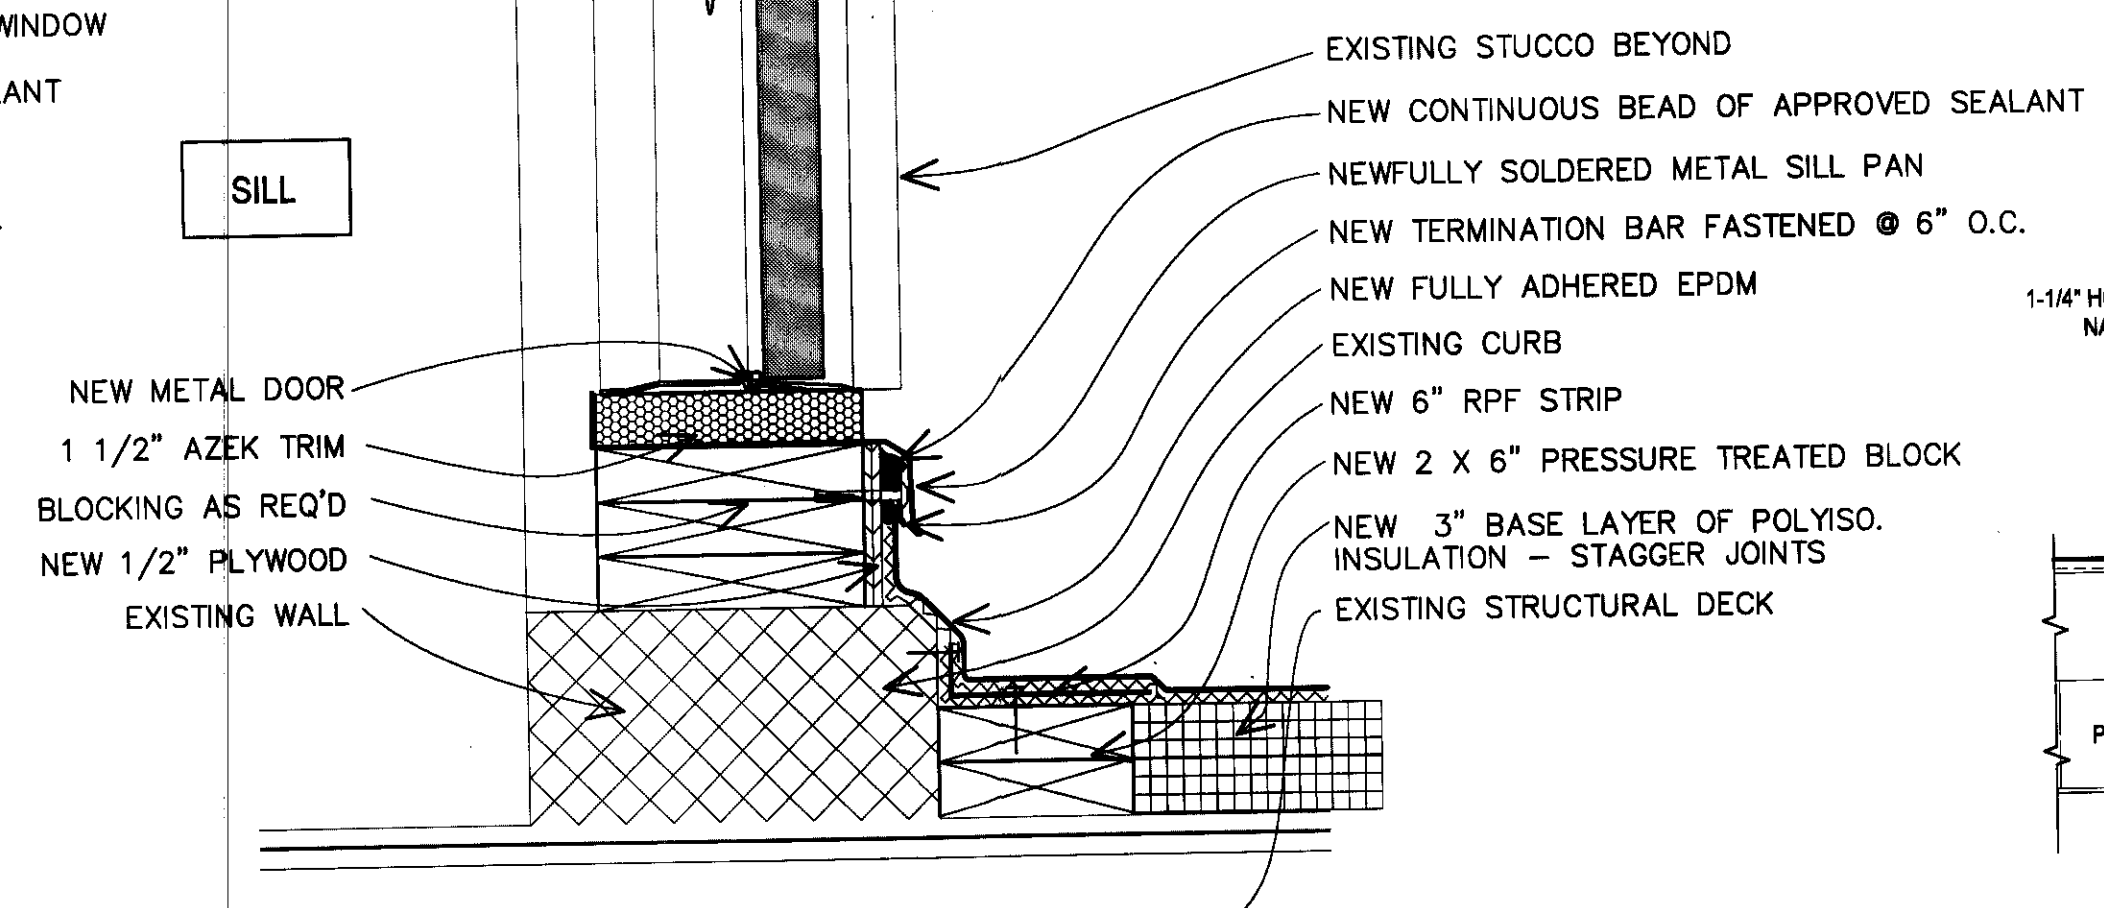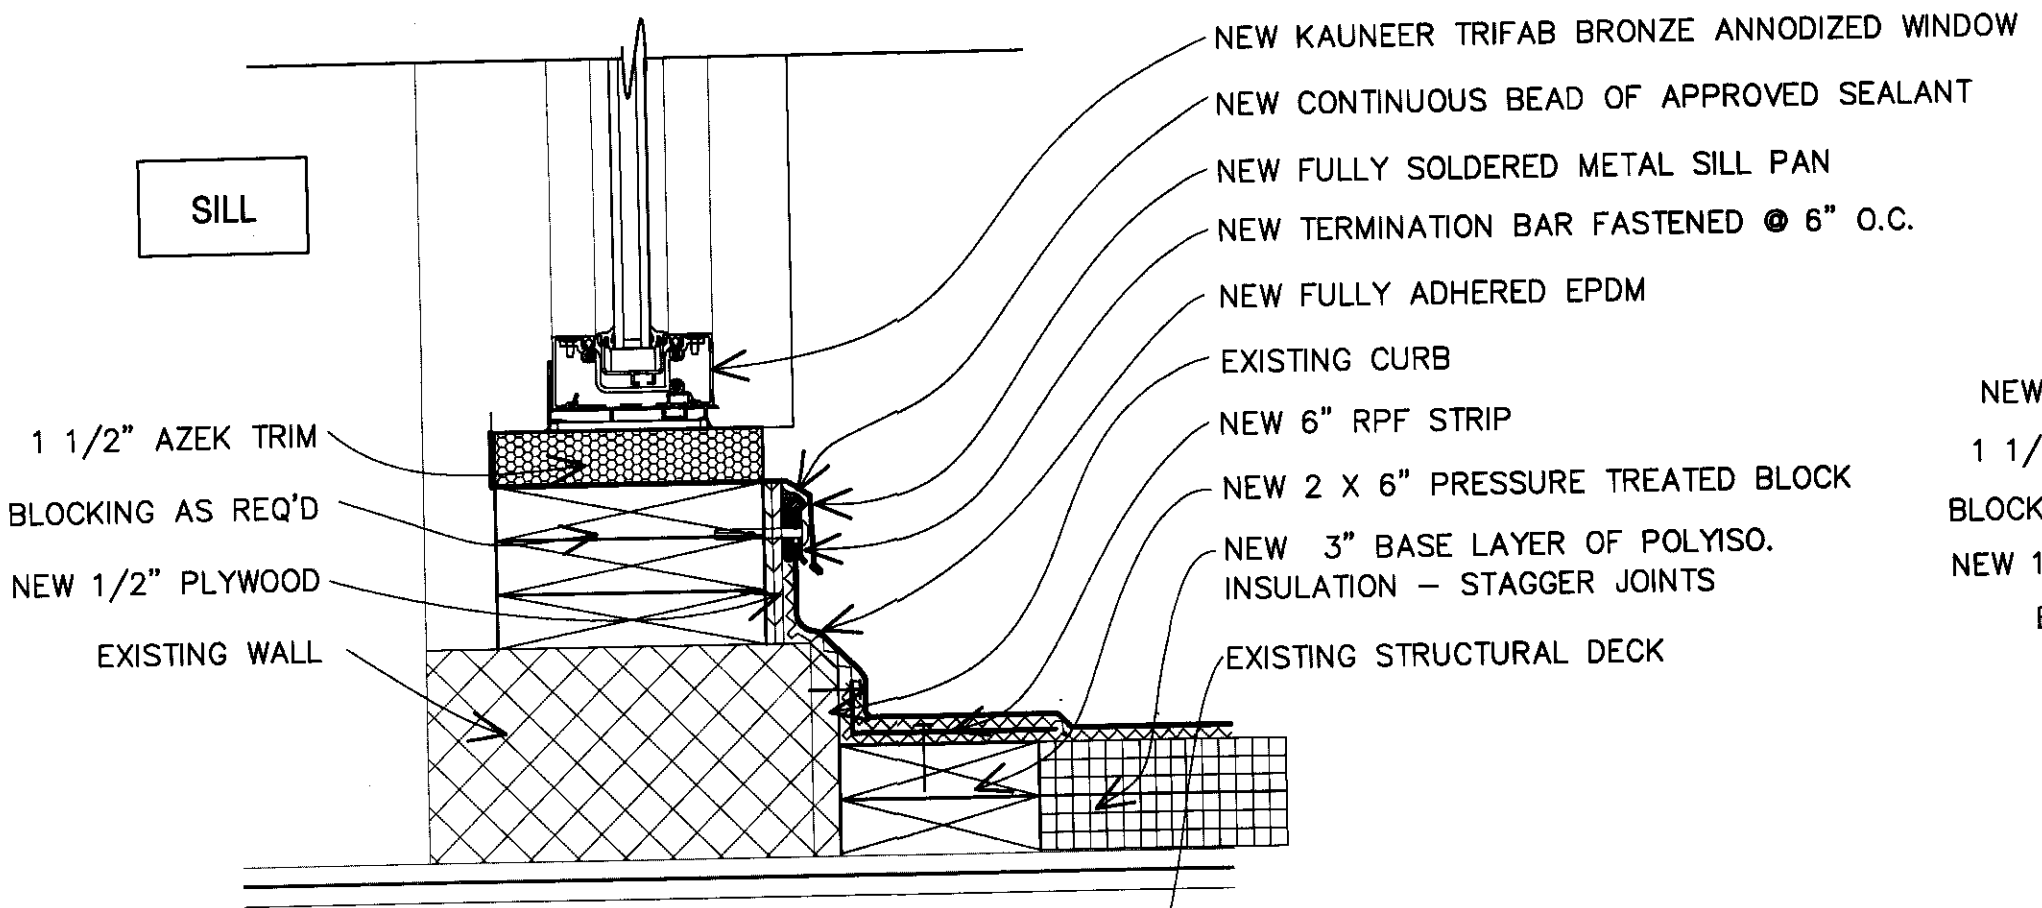


8 TYP PITCH POCKET DETAIL
A2 SCALE: 6" = 1'-0"


NOTES:
1. REMOVE ALL EXISTING FLASHINGS, LEADS, ETC. PIPE SURFACE MUST BE FREE OF ALL RUST, GREASE INSULATION, ETC.
2. POURABLE SEALER MOUNDED TO SHED WATER (MINIMUM DEPTH OF 2" (50.8 mm))
3. DO NOT USE OVER EXISTING PENETRATION POCKETS.
4. WOOD NAILER MUST BE INSTALLED TO MEET APPLICABLE BUILDING CODES OR 200 LBS PER LINEAR FOOT MINIMUM IN ANY GIVEN DIRECTION.
5. DO NOT USE WHEN SERVICE LINE TEMP. EXCEEDS 180DF. REFER TO 8/A2.
6. APPLY LAP SEALANT AROUND ENTIRE PERIMETER OF FLASHING. REFER TO 7/A1 FOR SEAM EDGE TREATMENT.
7. EPDM CLEANER/PRIMER REQUIRED ON PENETRATIONS AND MEMBRANE INSIDE OF PENETRATION POCKET.

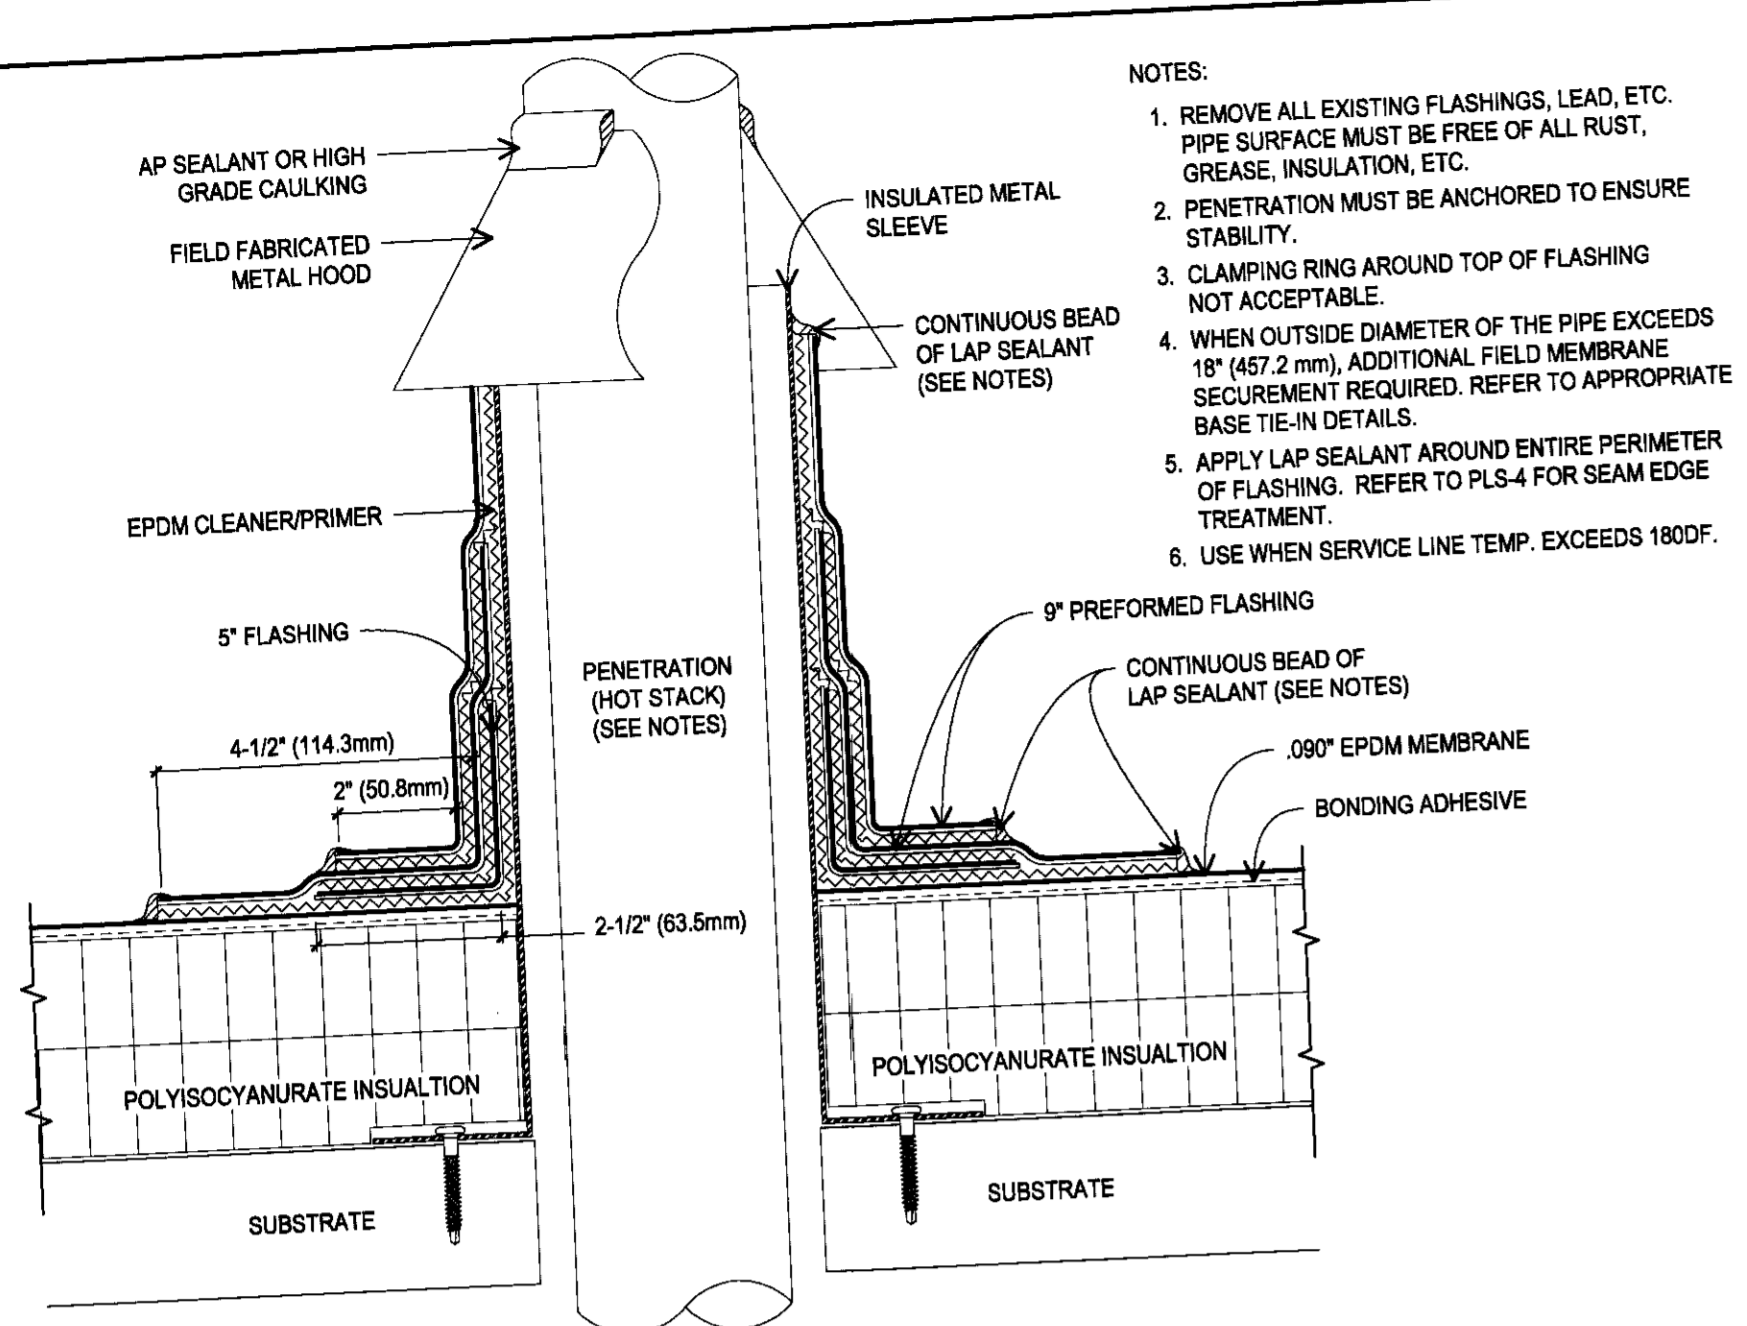

- NOTES:
1. REMOVE ALL EXISTING FLASHINGS, LEAD, ETC. PIPE SURFACE MUST BE FREE OF ALL RUST, GREASE, INSULATION, ETC.
 2. PENETRATION MUST BE ANCHORED TO ENSURE STABILITY.
 3. CLAMPING RING AROUND TOP OF FLASHING NOT ACCEPTABLE.
 4. WHEN OUTSIDE DIAMETER OF THE PIPE EXCEEDS 18" (457.2 mm), ADDITIONAL FIELD MEMBRANE SECUREMENT REQUIRED. REFER TO APPROPRIATE BASE TIE-IN DETAILS.
 5. APPLY LAP SEALANT AROUND ENTIRE PERIMETER OF FLASHING. REFER TO 7/A1 FOR SEAM EDGE TREATMENT.
 6. USE WHEN SERVICE LINE TEMP. EXCEEDS 180°F.

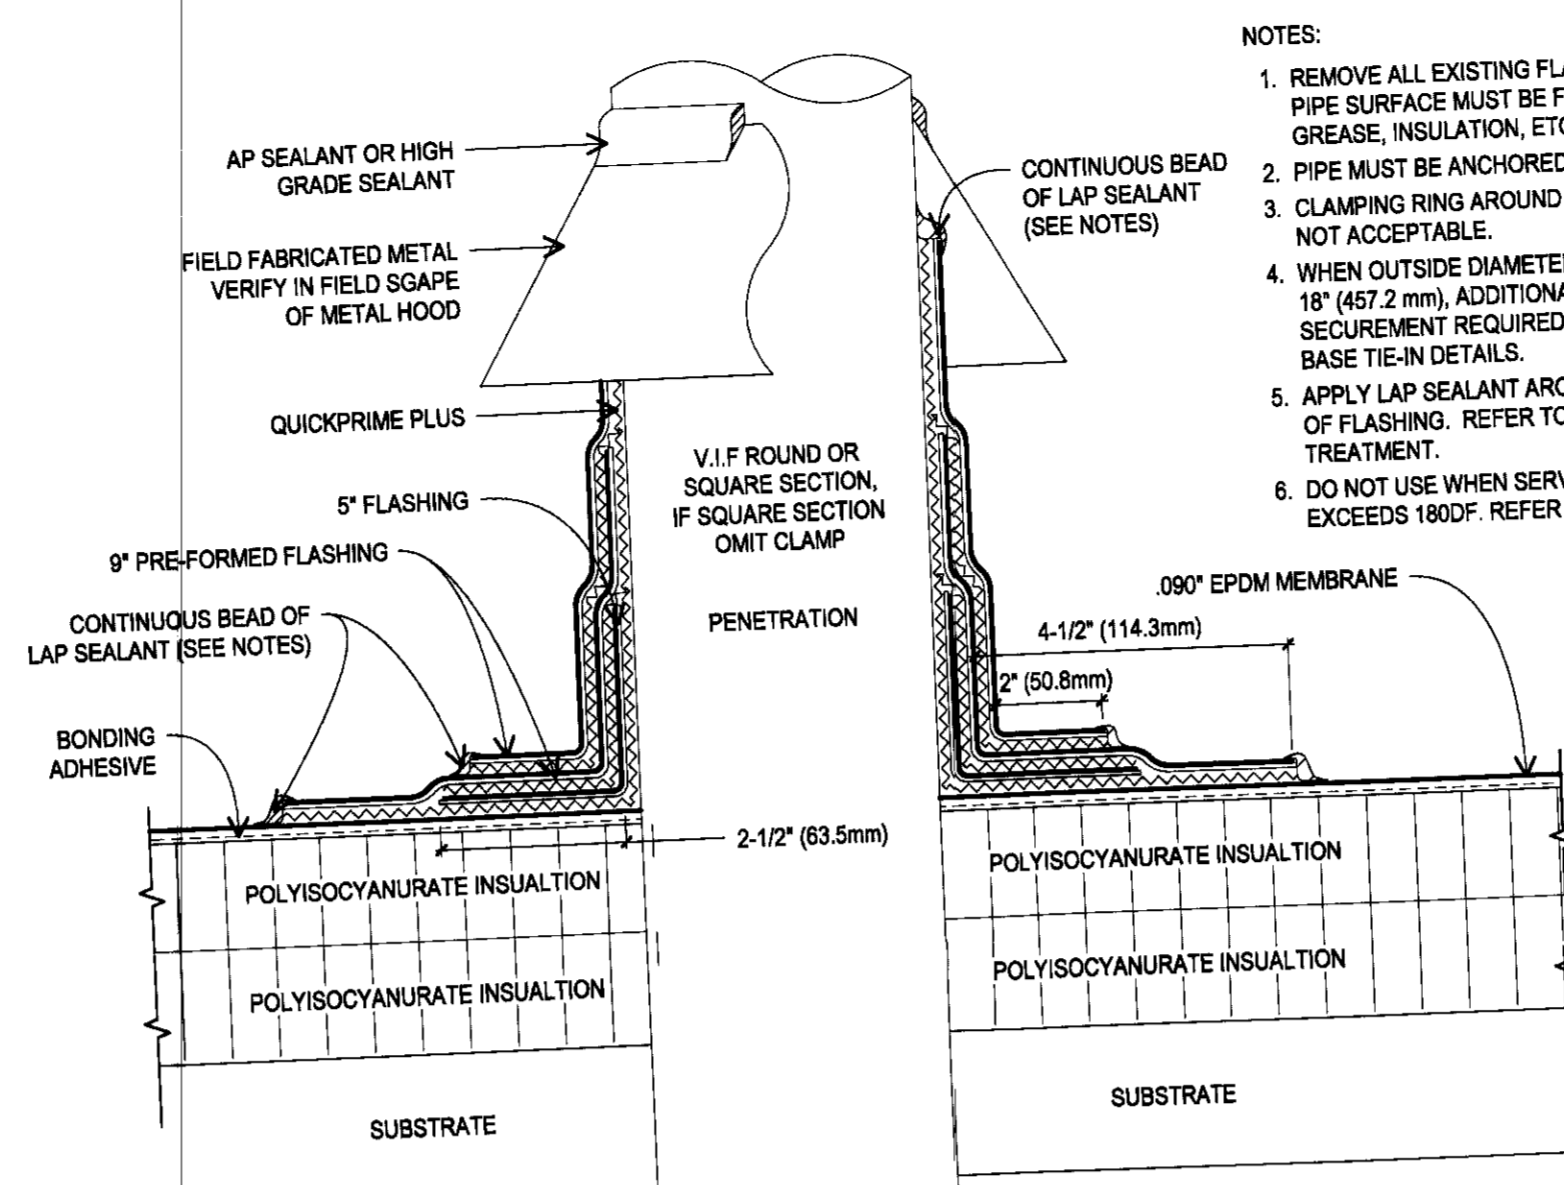

- NOTES:
1. REMOVE ALL EXISTING FLASHINGS, LEAD, ETC. PIPE SURFACE MUST BE FREE OF ALL RUST, GREASE, INSULATION, ETC.
 2. PIPE MUST BE ANCHORED TO ENSURE STABILITY.
 3. CLAMPING RING AROUND TOP OF FLASHING NOT ACCEPTABLE.
 4. WHEN OUTSIDE DIAMETER OF THE PIPE EXCEEDS 18" (457.2 mm), ADDITIONAL FIELD MEMBRANE SECUREMENT REQUIRED. REFER TO APPROPRIATE BASE TIE-IN DETAILS.
 5. APPLY LAP SEALANT AROUND ENTIRE PERIMETER OF FLASHING. REFER TO 7/A1 FOR SEAM EDGE TREATMENT.
 6. DO NOT USE WHEN SERVICE LINE TEMP. EXCEEDS 180°F. REFER TO 6/A2.

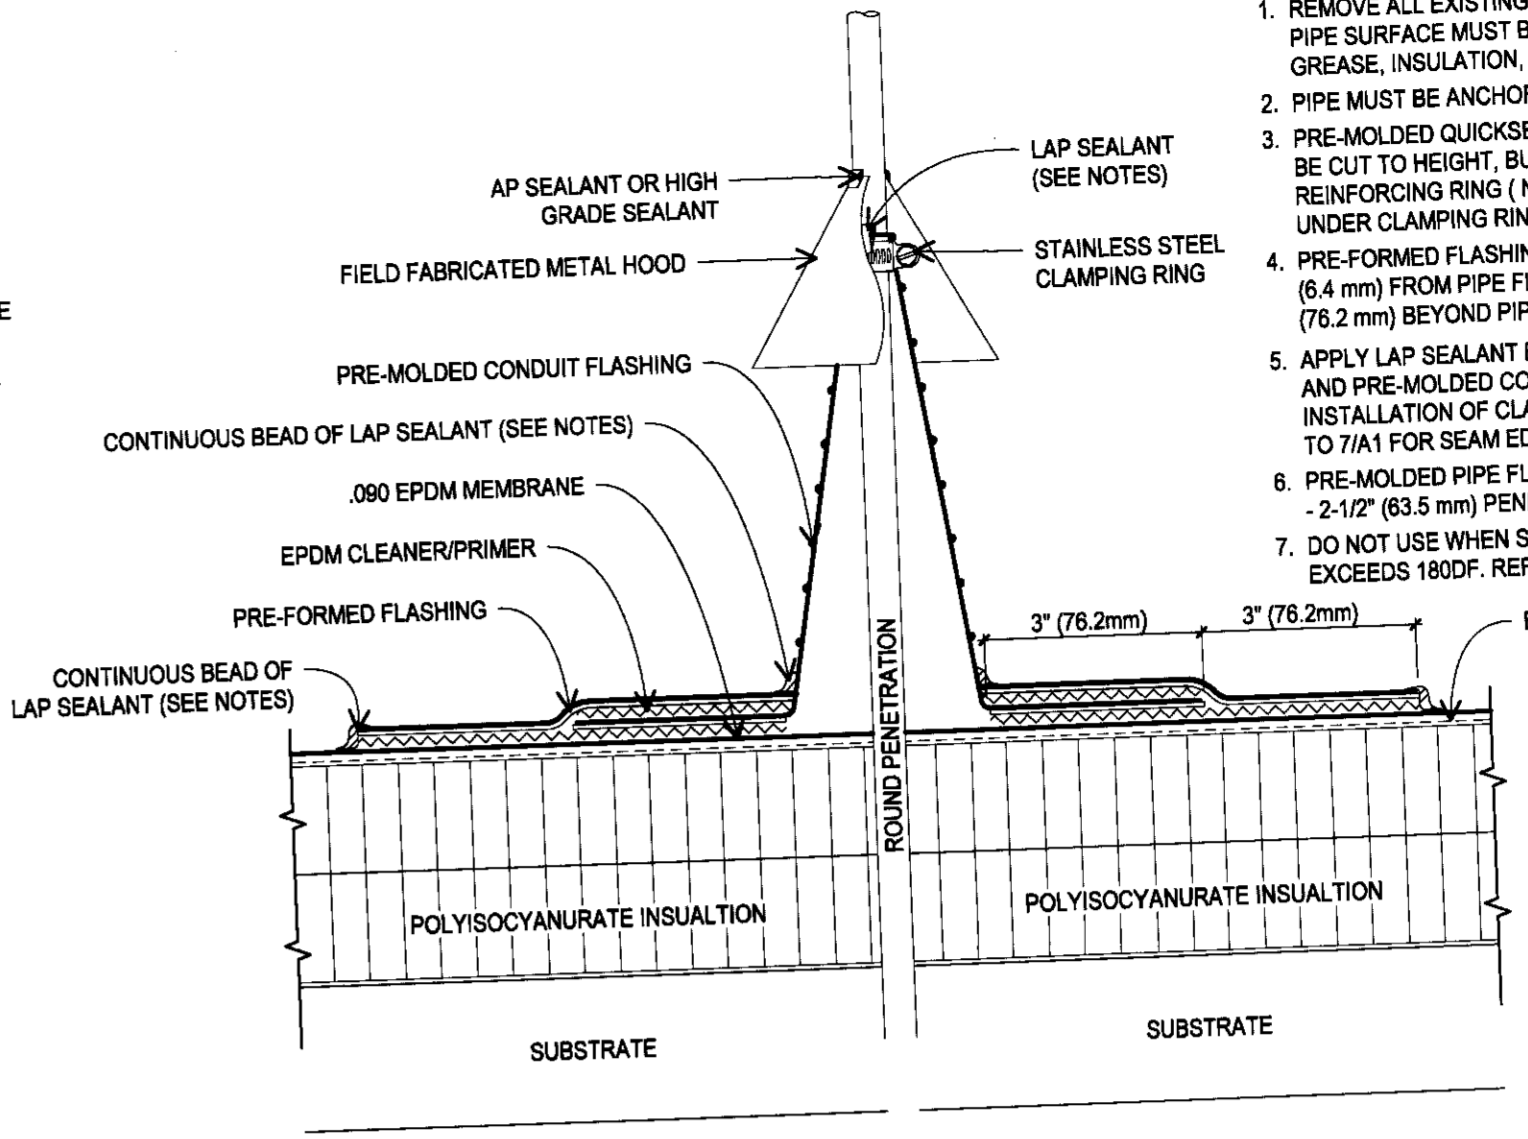


- NOTES:
1. REMOVE ALL EXISTING FLASHINGS, LEADS, ETC. PIPE SURFACE MUST BE FREE OF ALL RUST, GREASE, INSULATION, ETC.
 2. PIPE MUST BE ANCHORED TO ENSURE STABILITY.
 3. PRE-MOLDED QUICKSEAM PIPE FLASHING MAY BE CUT TO HEIGHT, BUT NO LOWER THAN REINFORCING RING (NO WRINKLES OR FOLDS UNDER CLAMPING RING).
 4. PRE-FORMED FLASHING EXTENDING 1/4" (6.4 mm) FROM PIPE FLASHING WALL TO 3" (76.2 mm) BEYOND PIPE FLASHING.
 5. APPLY LAP SEALANT BETWEEN PENETRATION AND PRE-MOLDED CONDUIT FLASHING PRIOR TO INSTALLATION OF CLAMPING RING. REFER TO 7/A1 FOR SEAM EDGE TREATMENT.
 6. PRE-MOLDED PIPE FLASHING FITS 1/2" (12.7 mm) - 2-1/2" (63.5 mm) PENETRATION SIZES.
 7. DO NOT USE WHEN SERVICE LINE TEMP. EXCEEDS 180°F. REFER TO 6/A2.


1 TYP FIELD WRAP HOT STACK DETAIL
A3 SCALE: 6" = 1'-0"

2 TYP FIELD WRAP DETAIL
A3 SCALE: 6" = 1'-0"


3 TYP MOLDED FLASHING PENETRATION DETAIL
A3 SCALE: 6" = 1'-0"

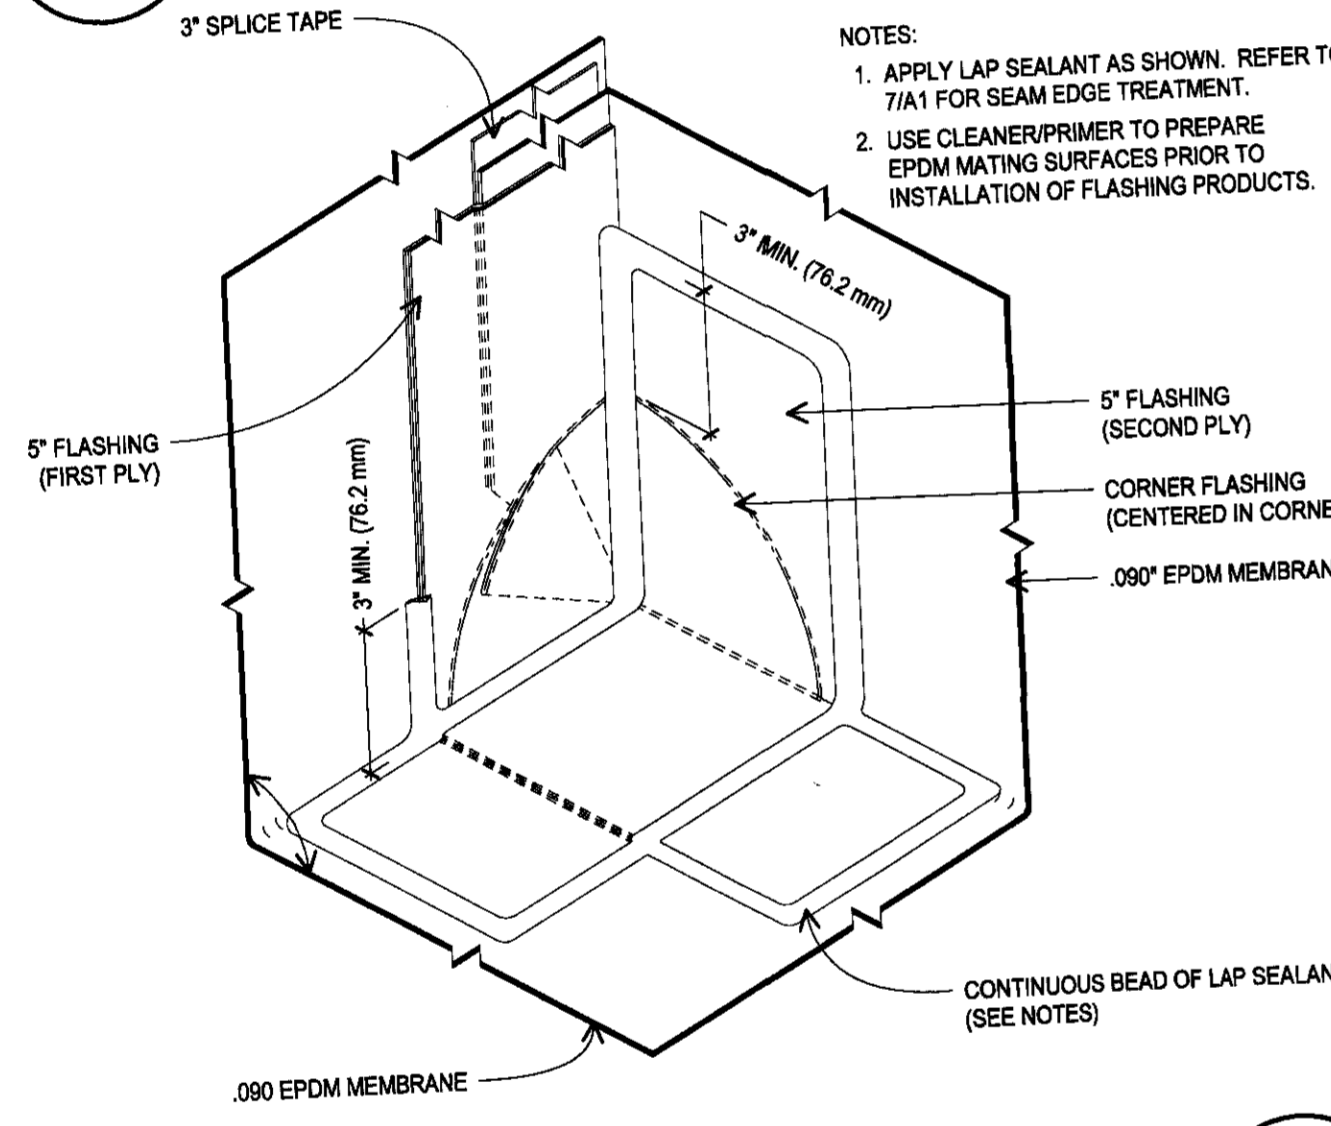


- NOTES:
1. APPLY LAP SEALANT AS SHOWN. REFER TO 7/A1 FOR SEAM EDGE TREATMENT.
 2. USE CLEANER/PRIMER TO PREPARE EPDM MATING SURFACES PRIOR TO INSTALLATION OF FLASHING PRODUCTS.

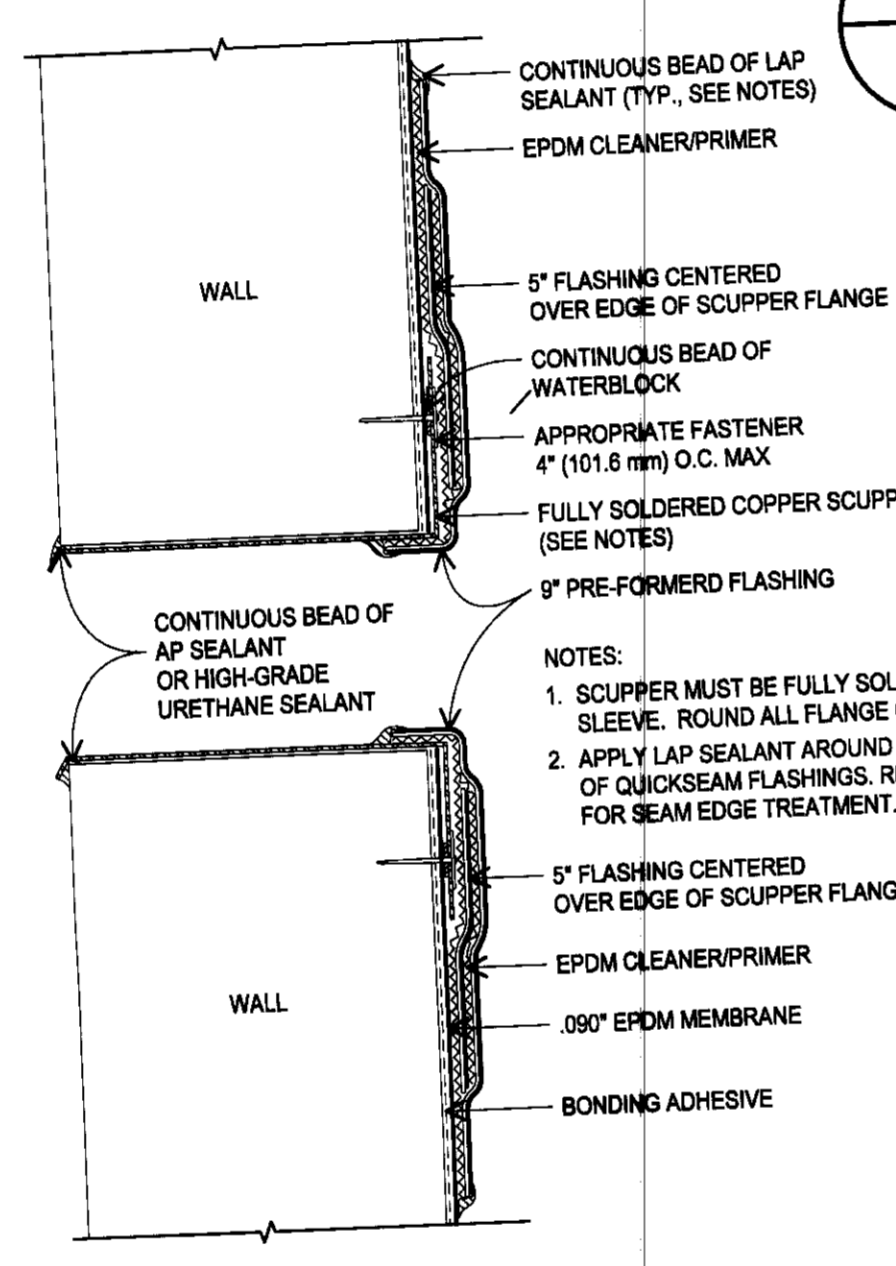

- NOTES:
1. SCUPPER MUST BE FULLY SOLDERED COPPER SLEEVE. ROUND ALL FLANGE CORNERS.
 2. APPLY LAP SEALANT AROUND ENTIRE PERIMETER OF QUICKSEAM FLASHINGS. REFER TO 7/A1 FOR SEAM EDGE TREATMENT.

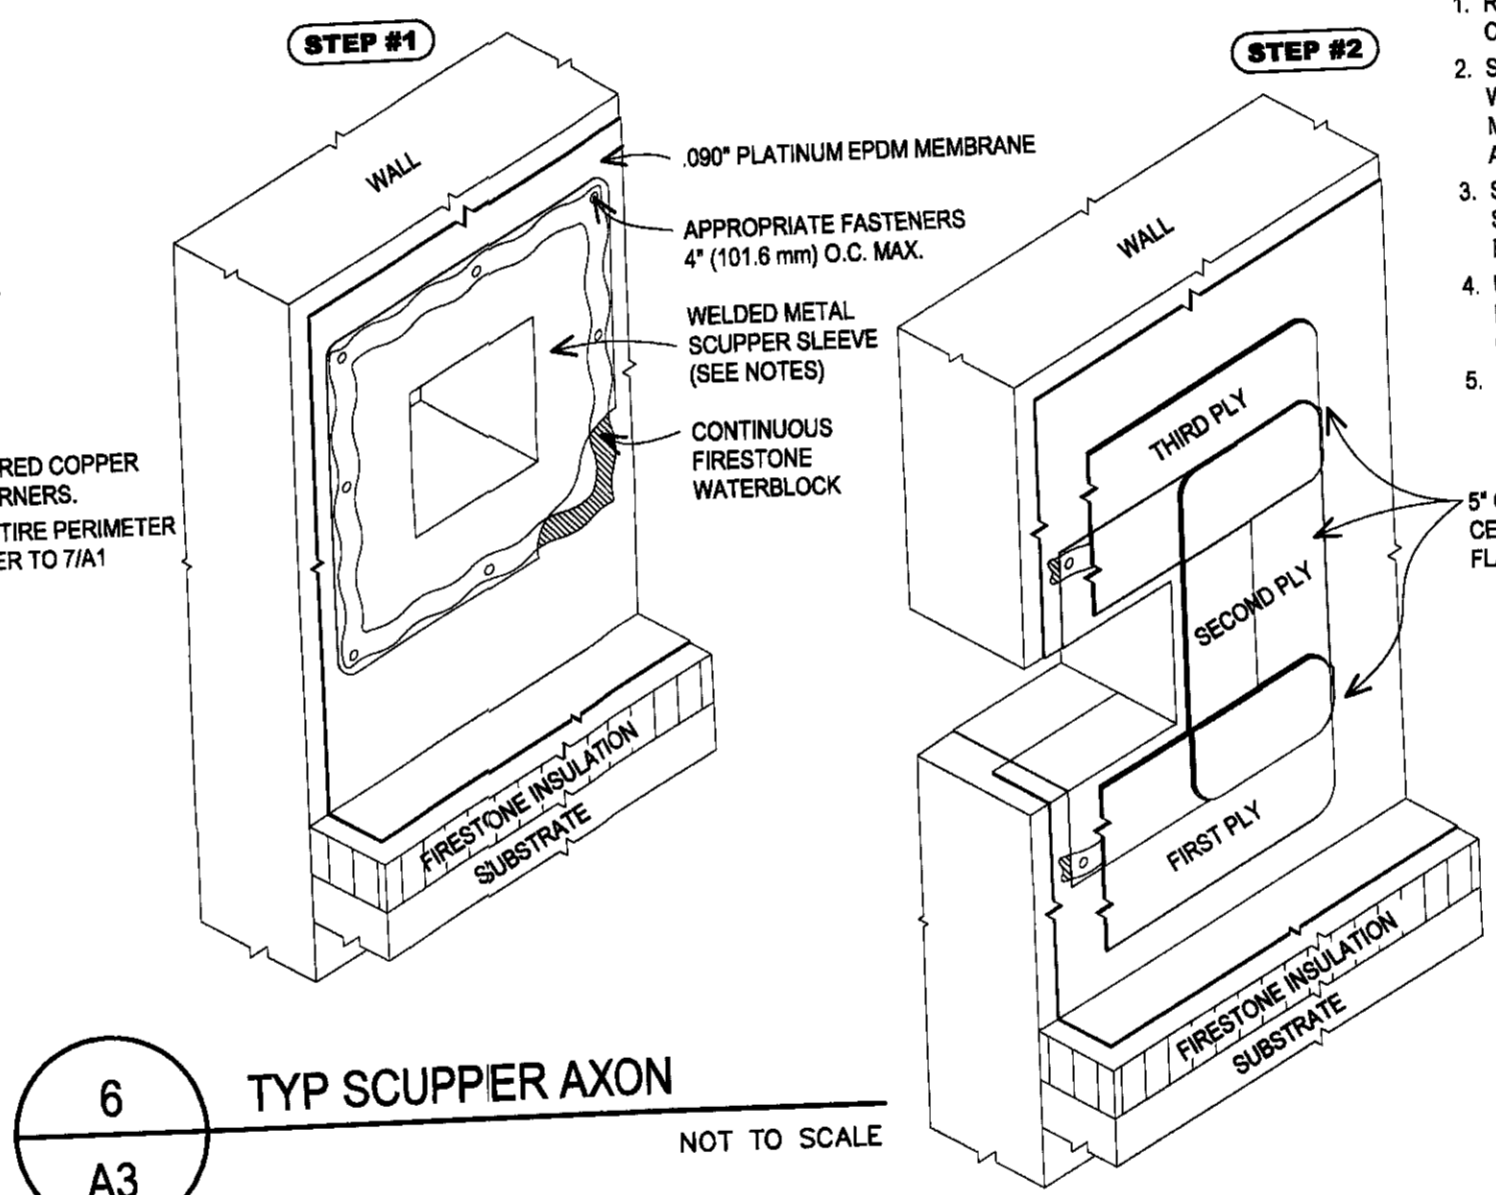

- NOTES:
1. REFER TO FIRESTONE WEBSITE FOR MOST CURRENT INFORMATION.
 - STEP #1 - APPLY CONTINUOUS BEAD OF FIRESTONE WATERBLOCK CENTERED UNDER NAILS. FASTEN METAL SCUPPER WITH APPROPRIATE FASTENERS AND ROUND ALL CORNERS OF SCUPPER.
 - STEP #2 - STRIP IN ALL EXPOSED EDGES OF SCUPPER AS INDICATED WITH 5\"/>

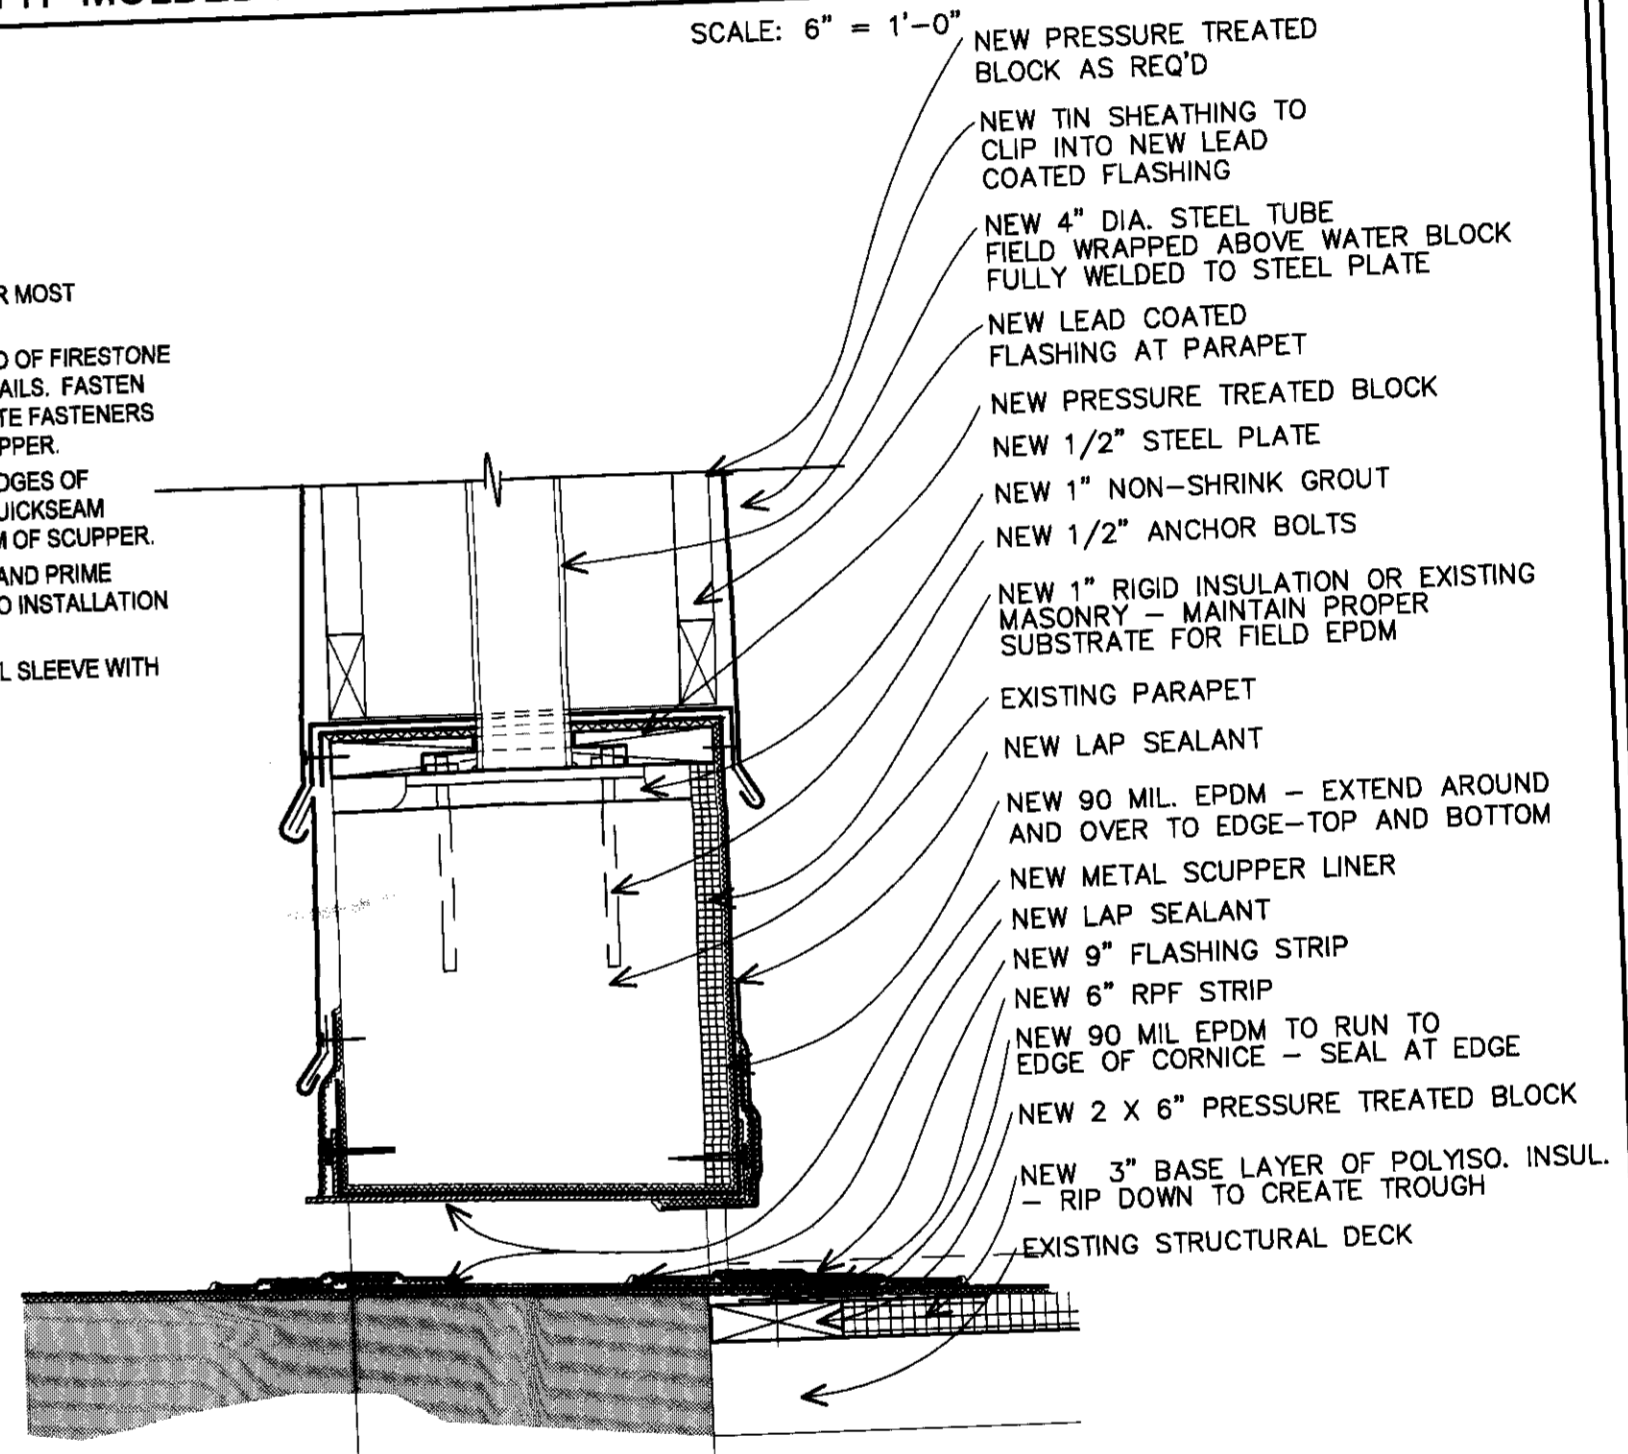


4 TYP INSIDE CORNER DETAIL
A3 SCALE: 6" = 1'-0"


5 TYP SCUPPER DETAIL
A3 SCALE: 6" = 1'-0"

6 TYP SCUPPER AXON
A3 NOT TO SCALE


7 TYP CORNICE SCUPPER REPLACEMENT DETAIL - TYPE 2
A3 SCALE: 1 1/2" = 1'-0"

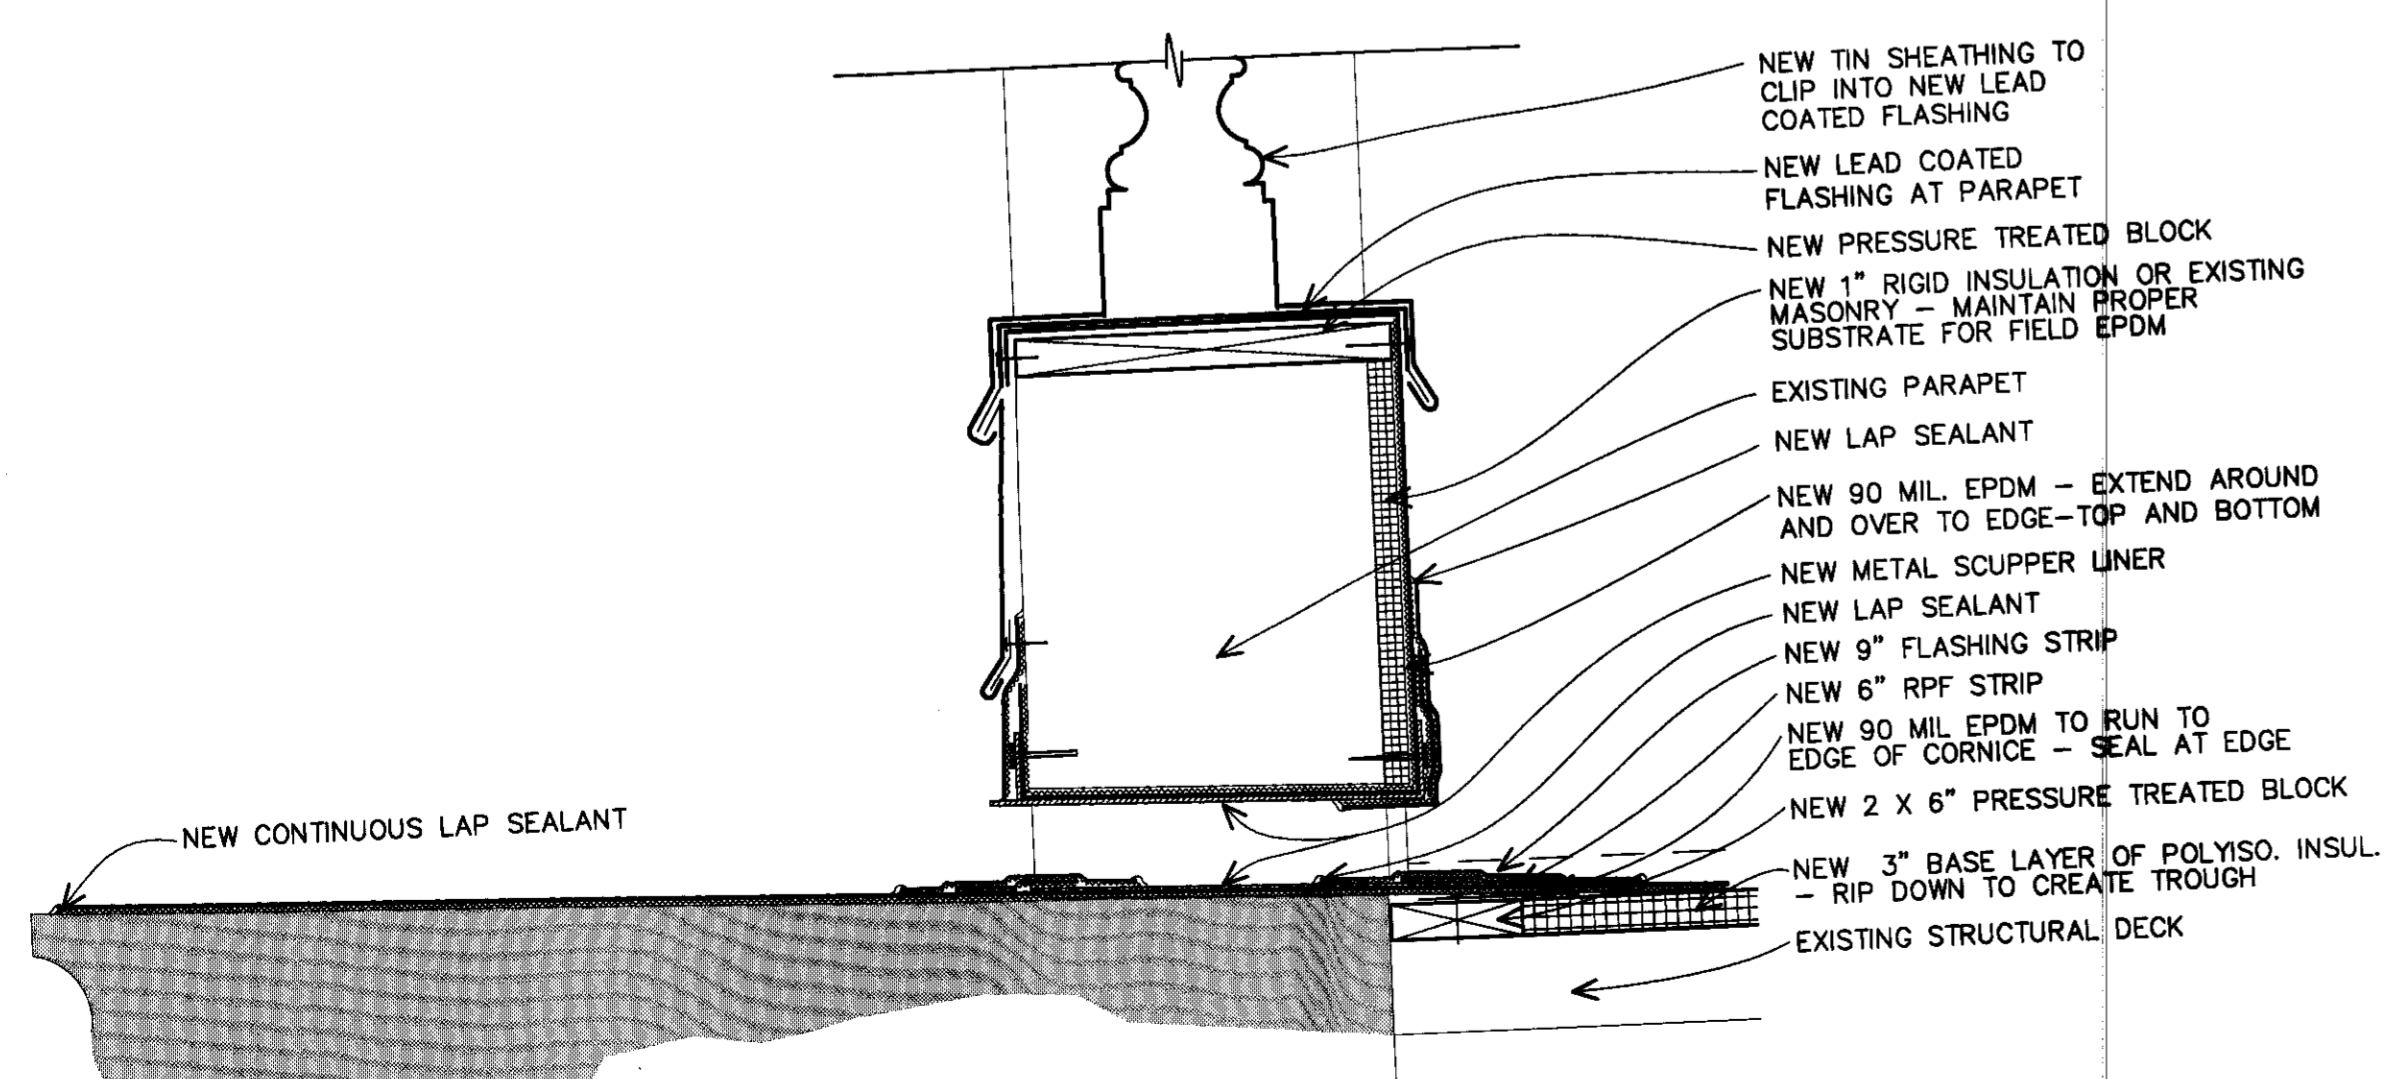

8 TYP CORNICE SCUPPER REPLACEMENT DETAIL - TYPE 1
A3 SCALE: 1 1/2" = 1'-0"

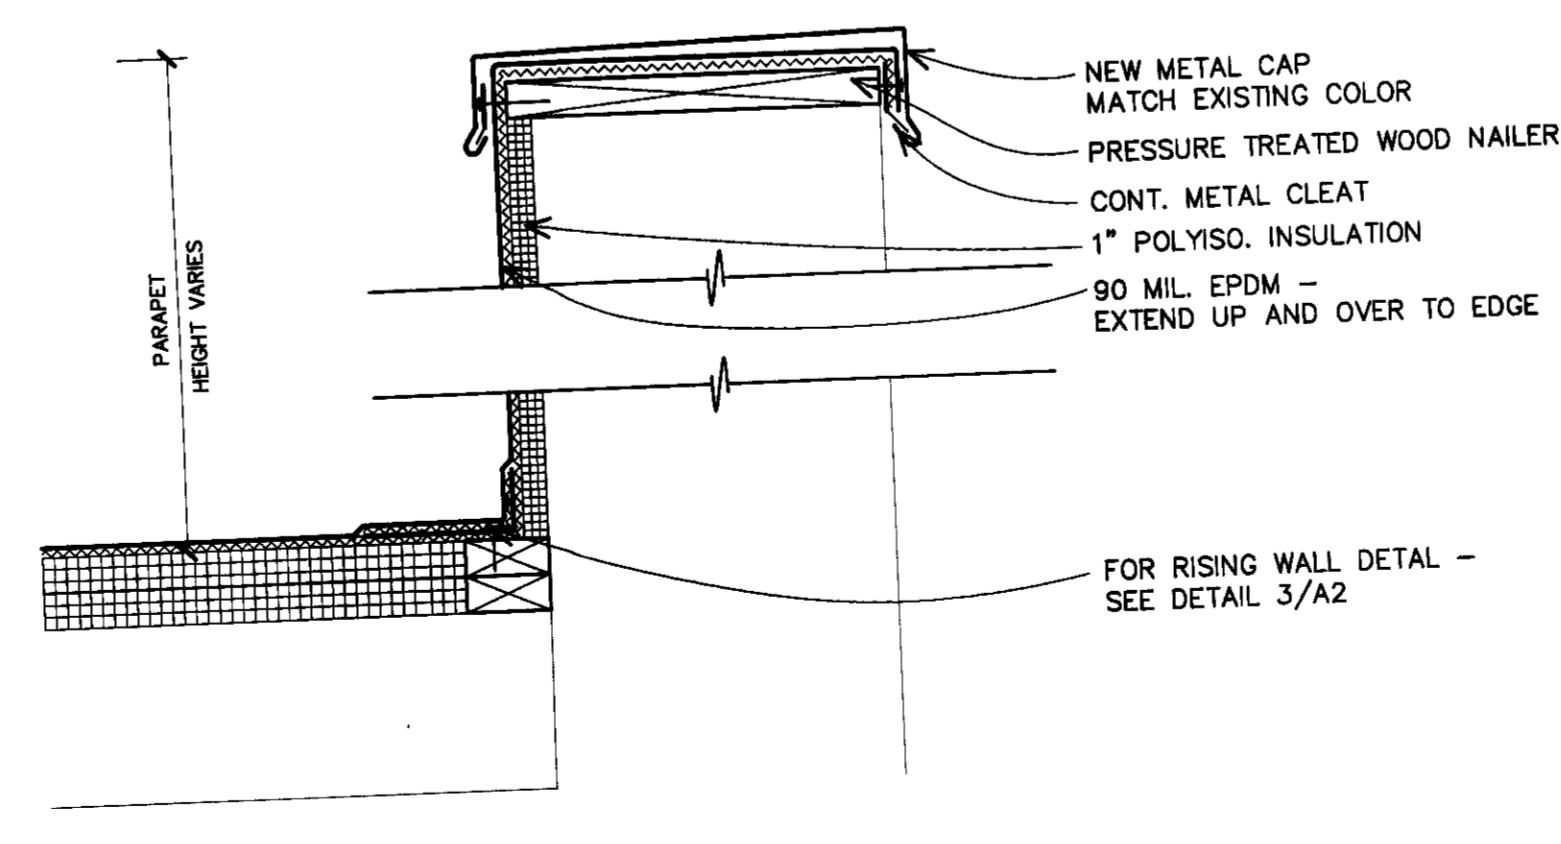


9 TYP HIGH WALL SCUPPER REPLACEMENT DETAIL
A3 SCALE: 1 1/2" = 1'-0"

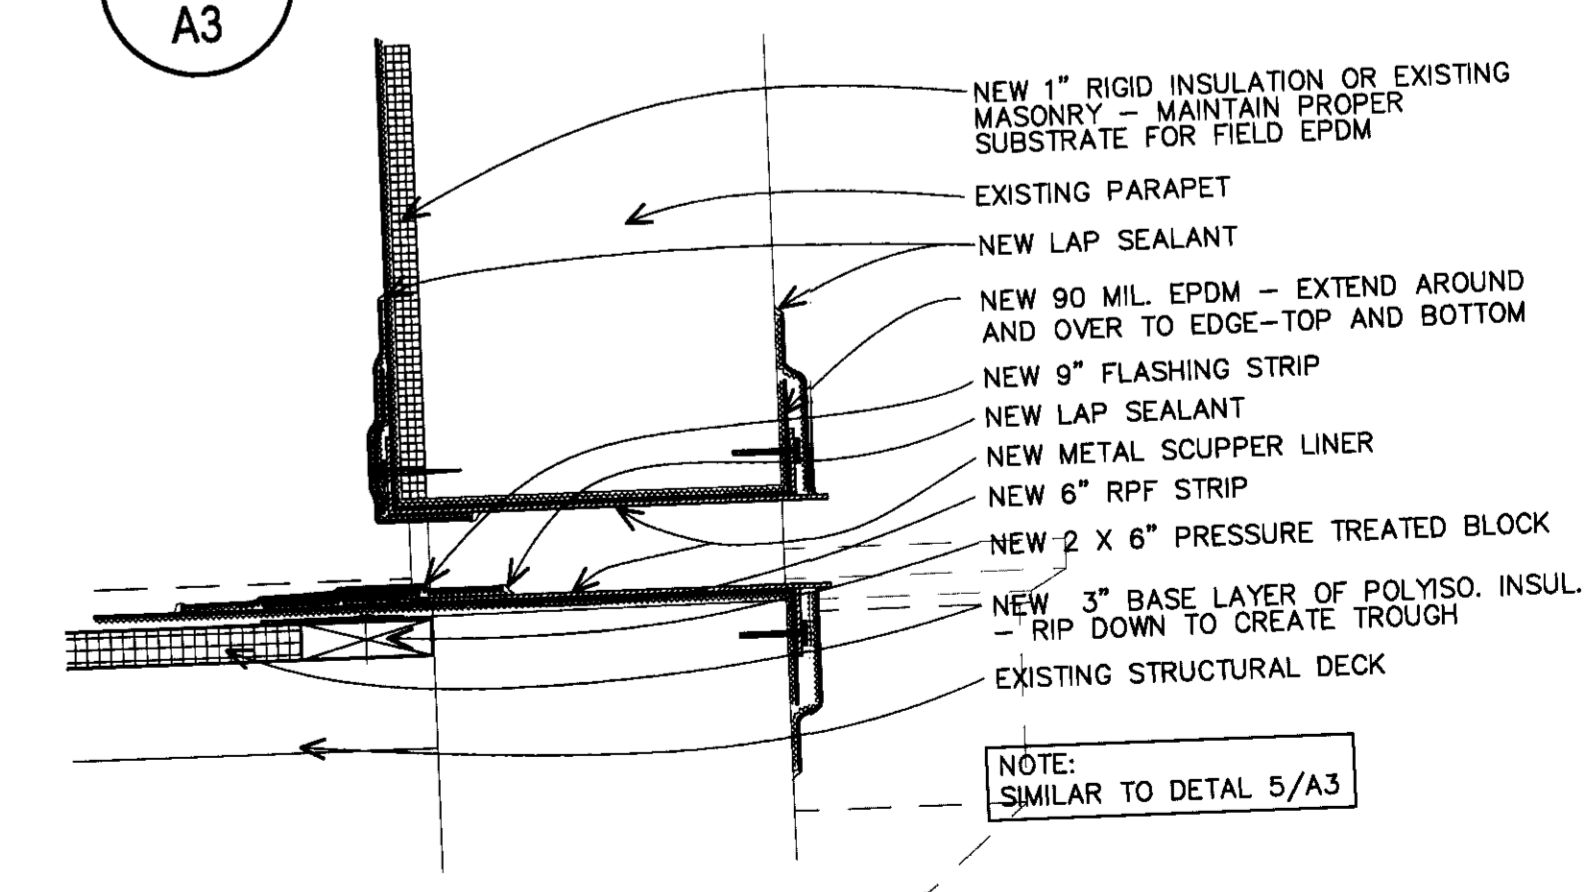

10 TYP HIGH WALL SCUPPER REPLACEMENT DETAIL
A3 SCALE: 1 1/2" = 1'-0"

REVISIONS	
NO.	DATE

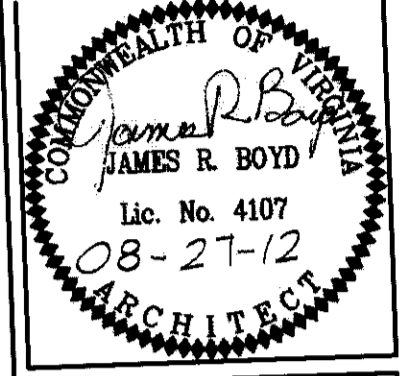


ISSUE: PRELIM. DOCUMENTS


HEYWARD BOYD ARCHITECTS, P.C.
111 West High Street
Charlottesville, Virginia 22902
434-971-6634 F
434-296-5353
CHECKED BY: JRB
DRAWN BY: JRB
FILE NAME:

NEW ROOF DETAILS
500 COURT SQUARE
ROOF REPLACEMENT
500 COURT SQUARE


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PROJECT NUMBER:
1206.06
SHEET NUMBER:
A3
DATE:
8.27.12

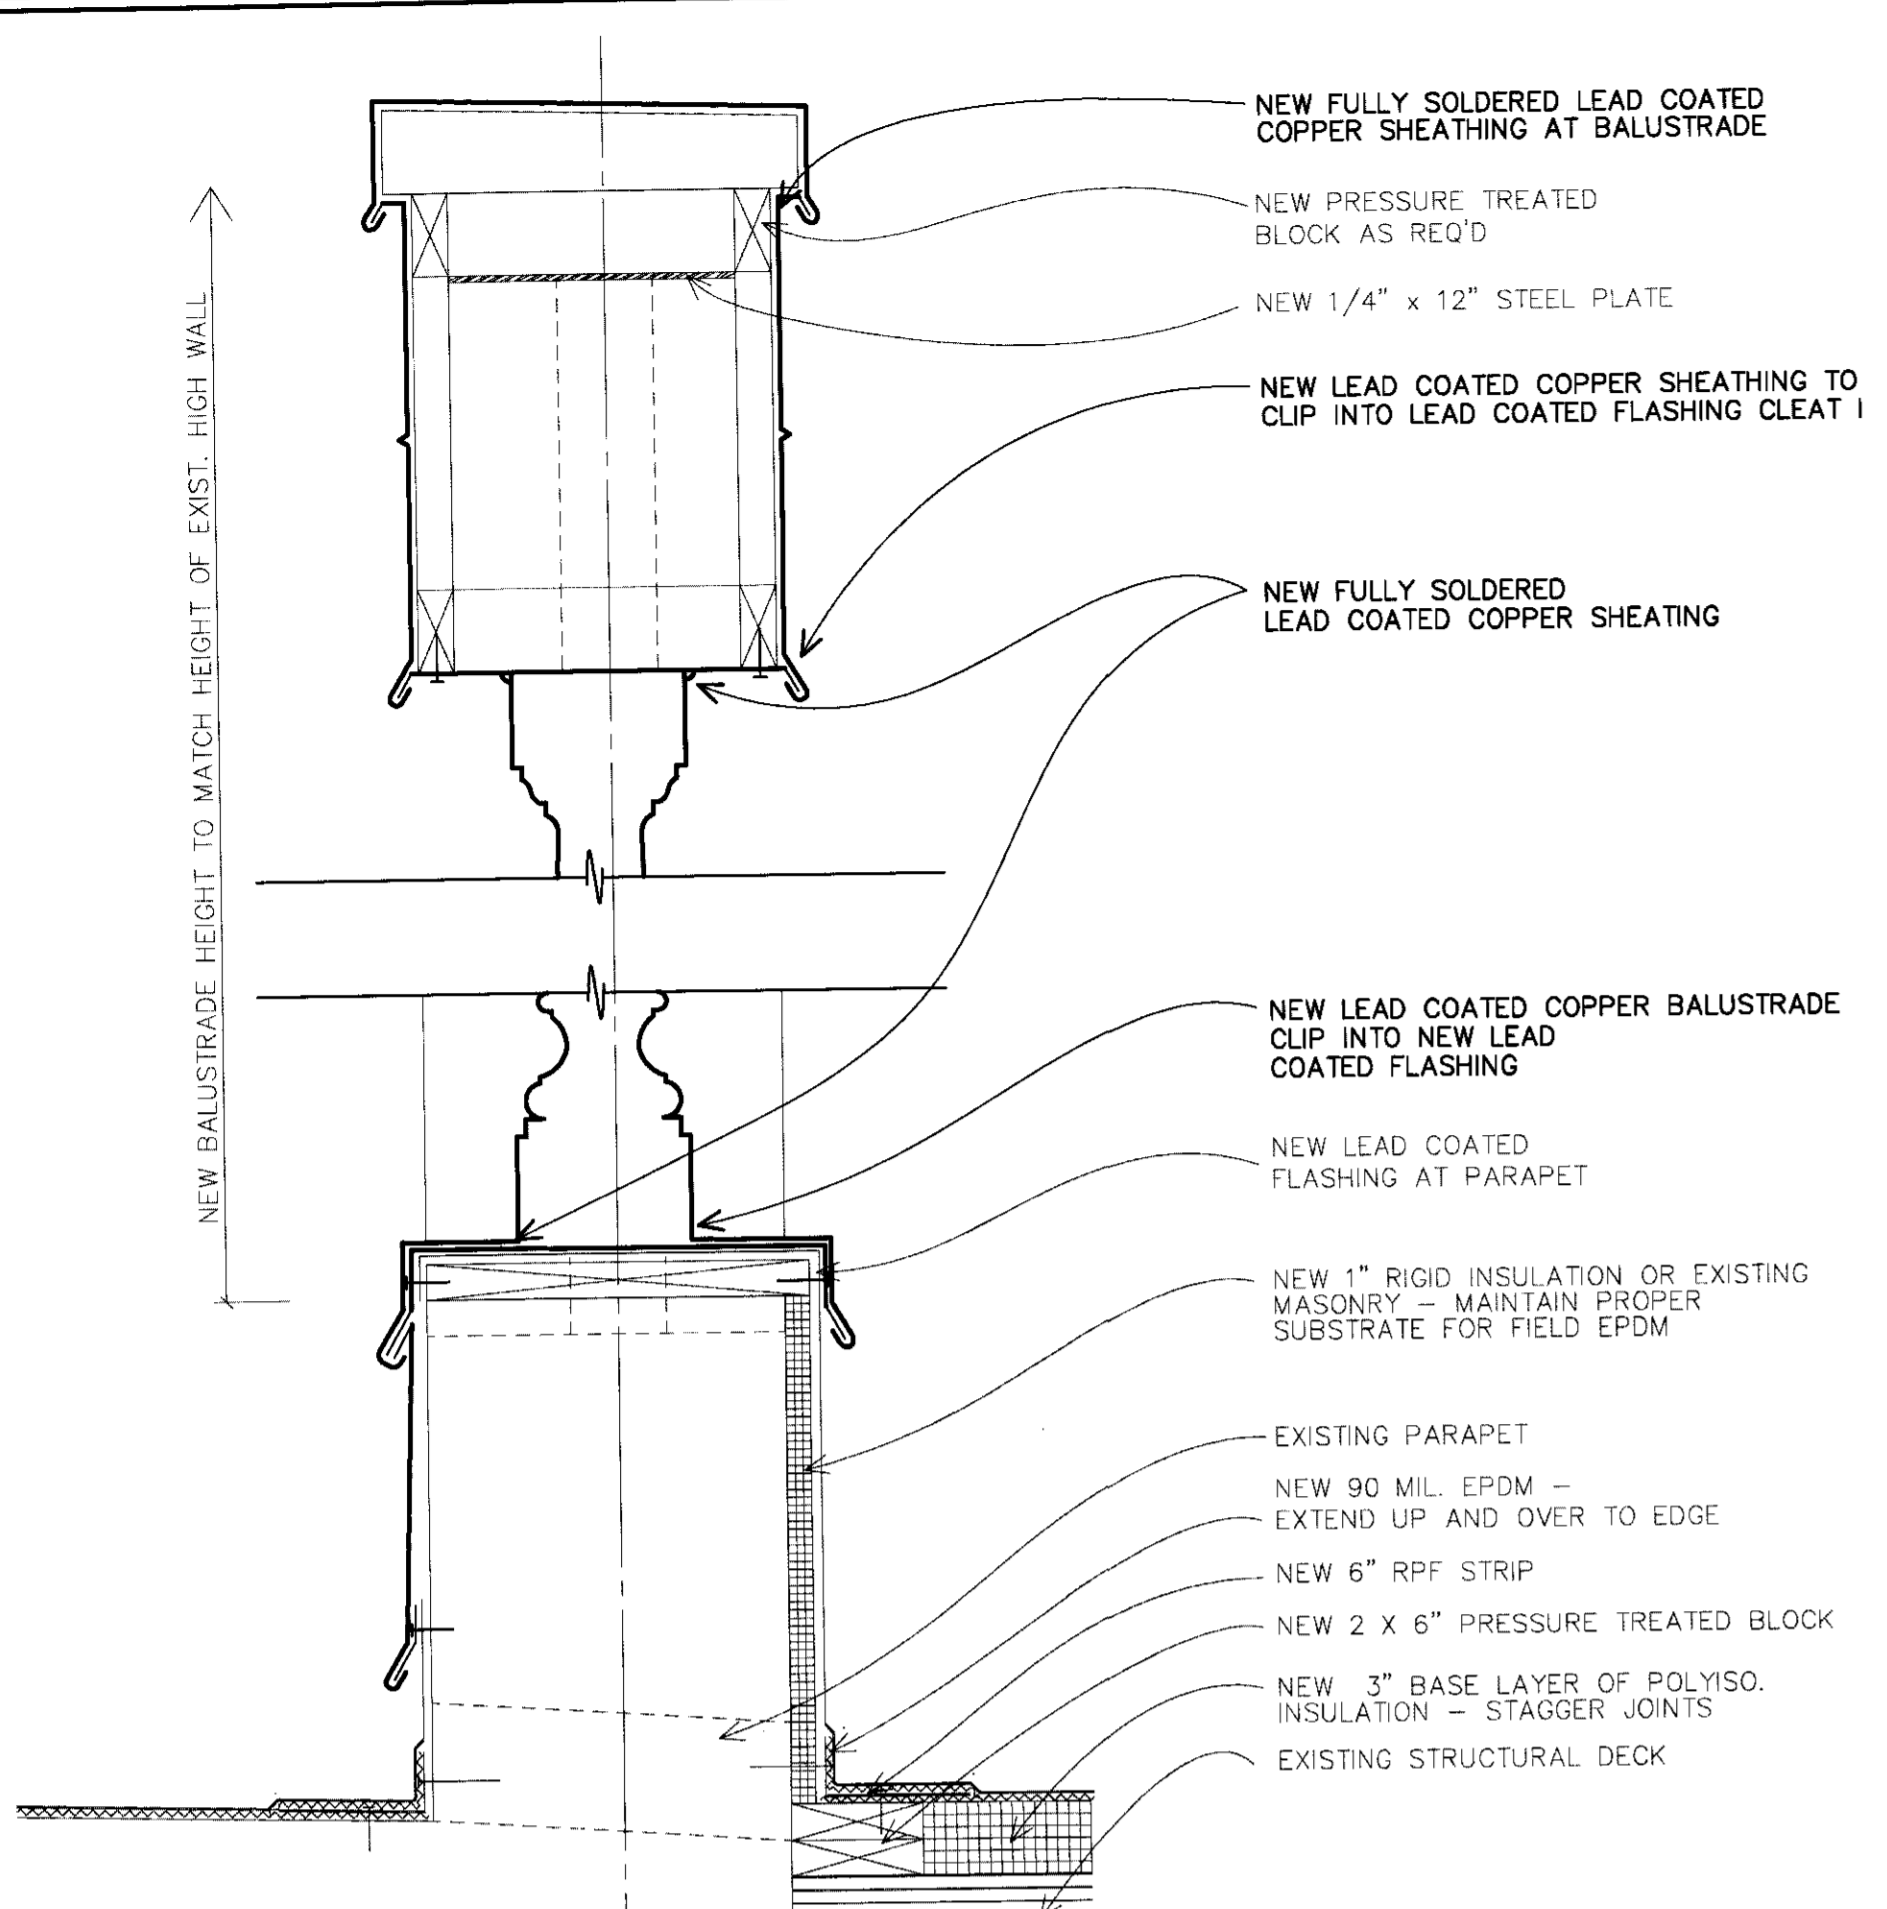


1 TYP BALUSTRADE REPLACEMENT DETAIL - TYPE 1
 SCALE: 1 1/2" = 1'-0"
 A4

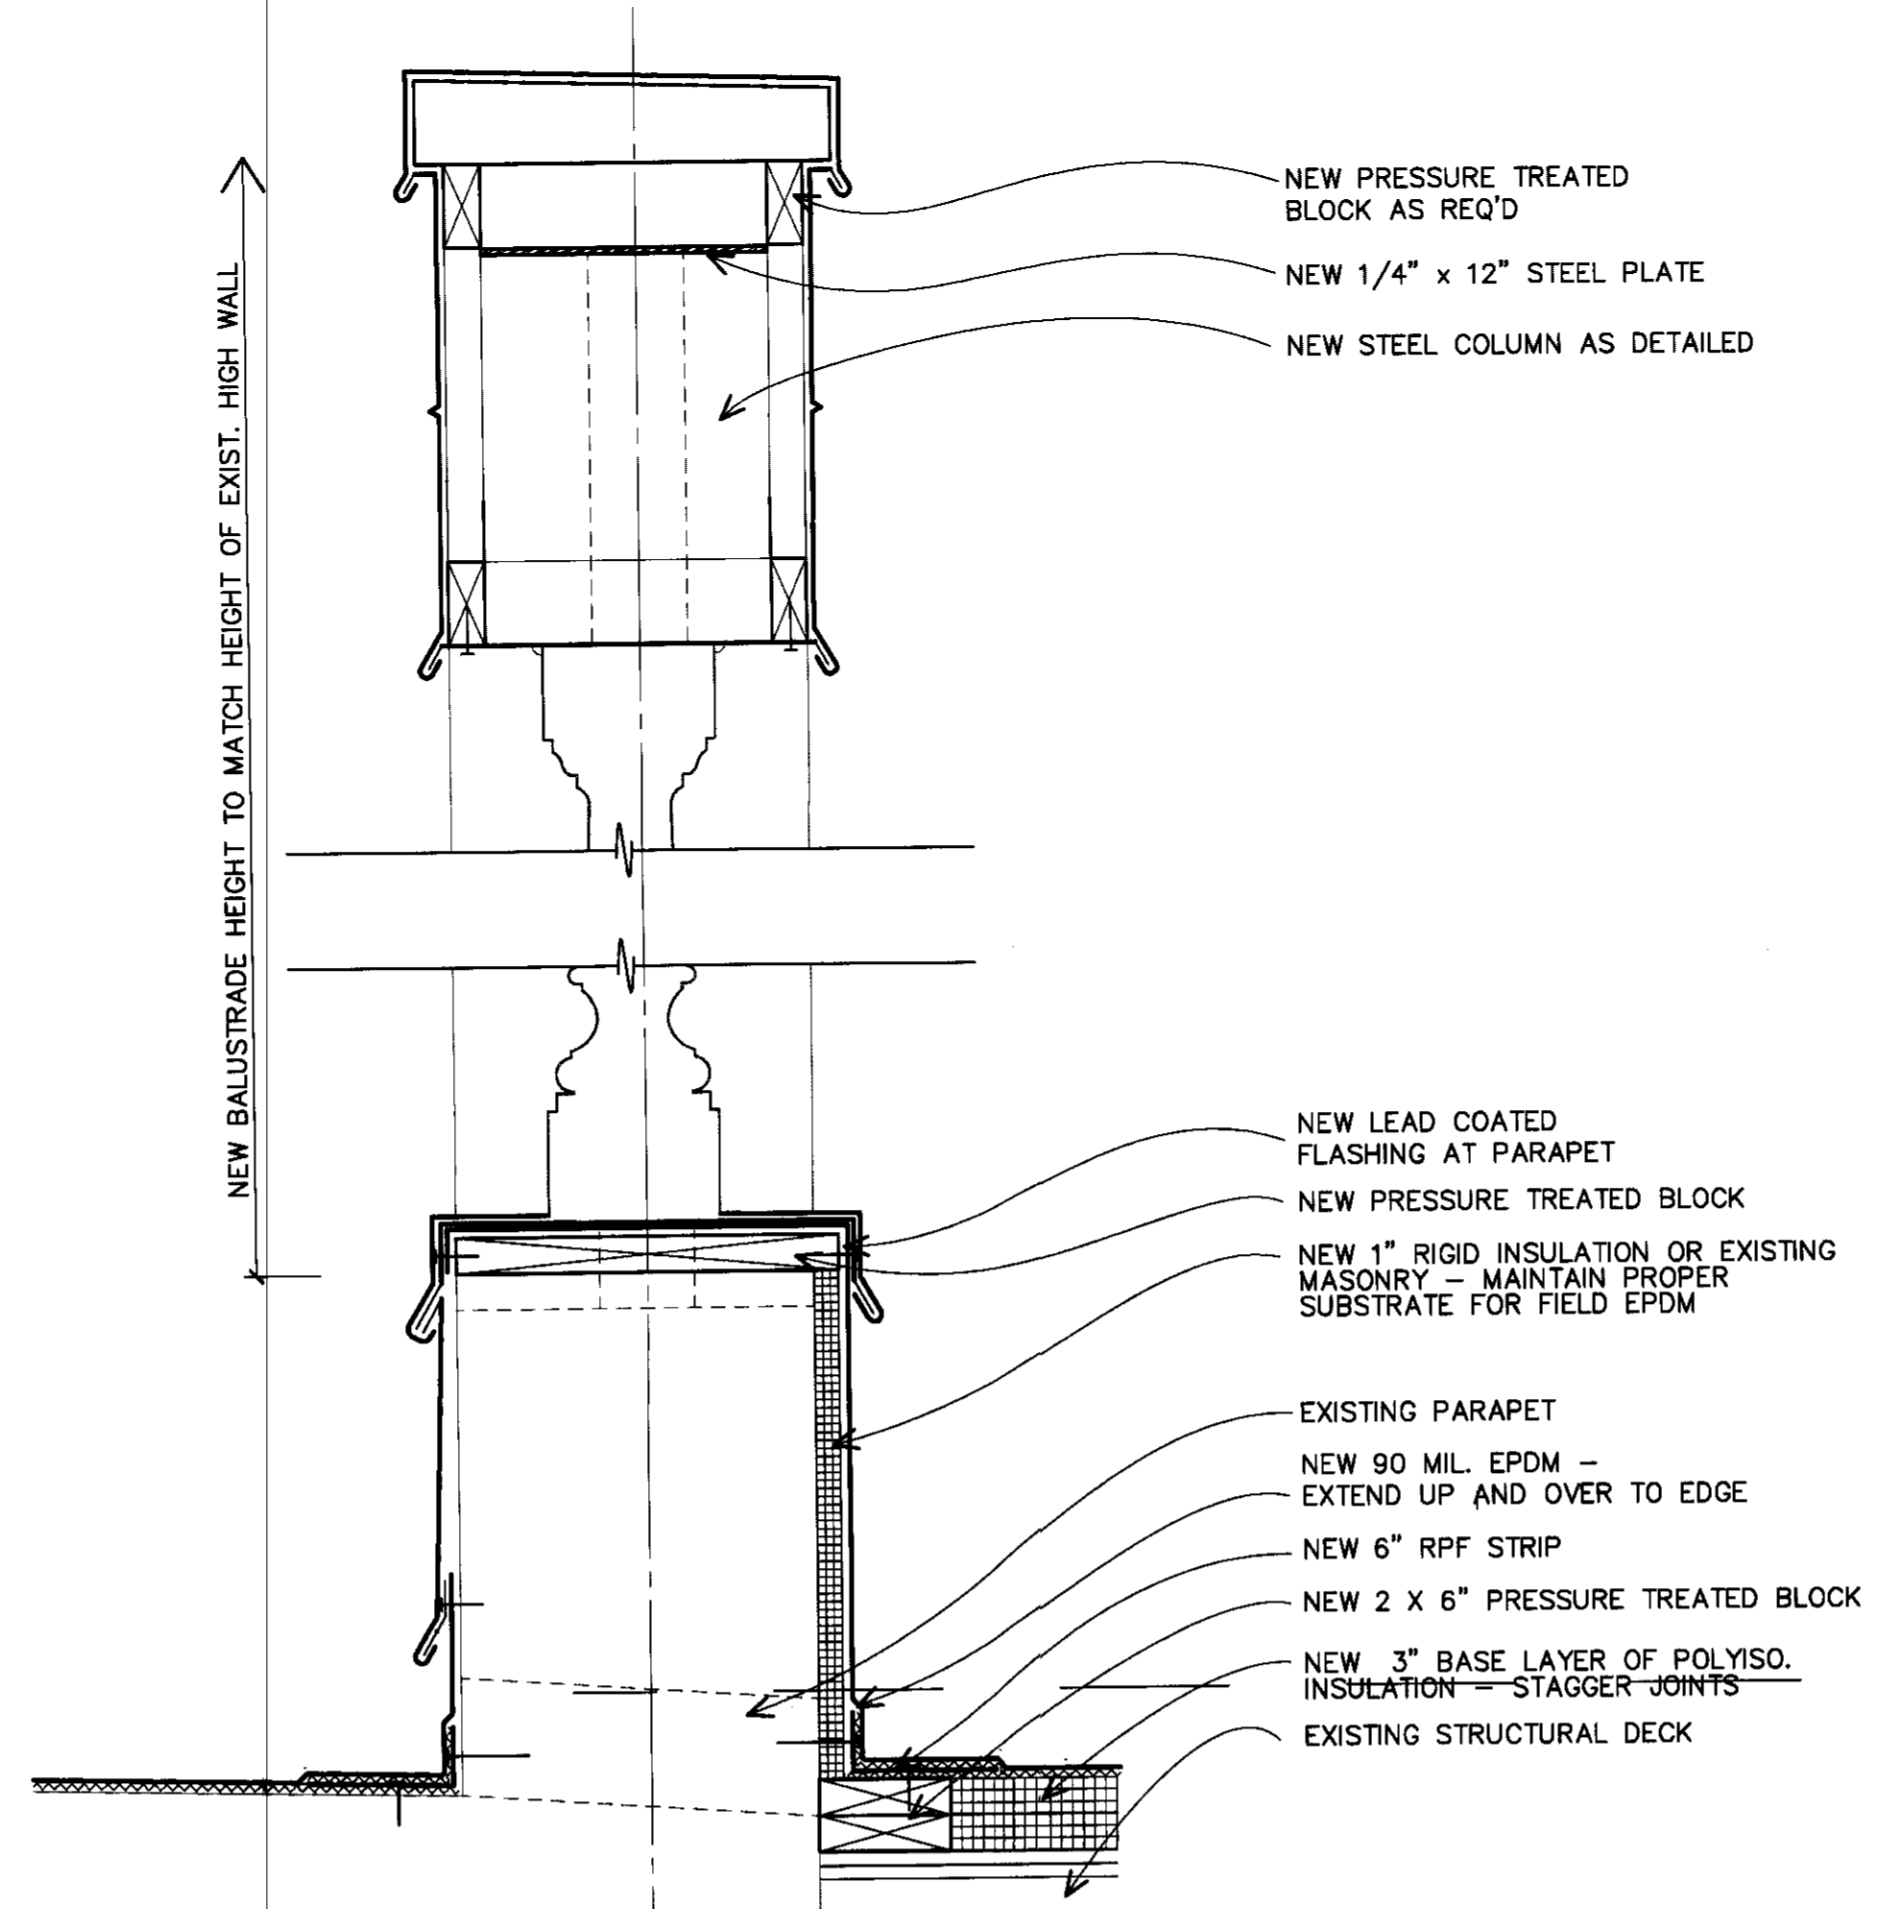


2 TYP THROUGH WALL FLASHING DETAIL - TYPE 1
 SCALE: 1 1/2" = 1'-0"
 A4

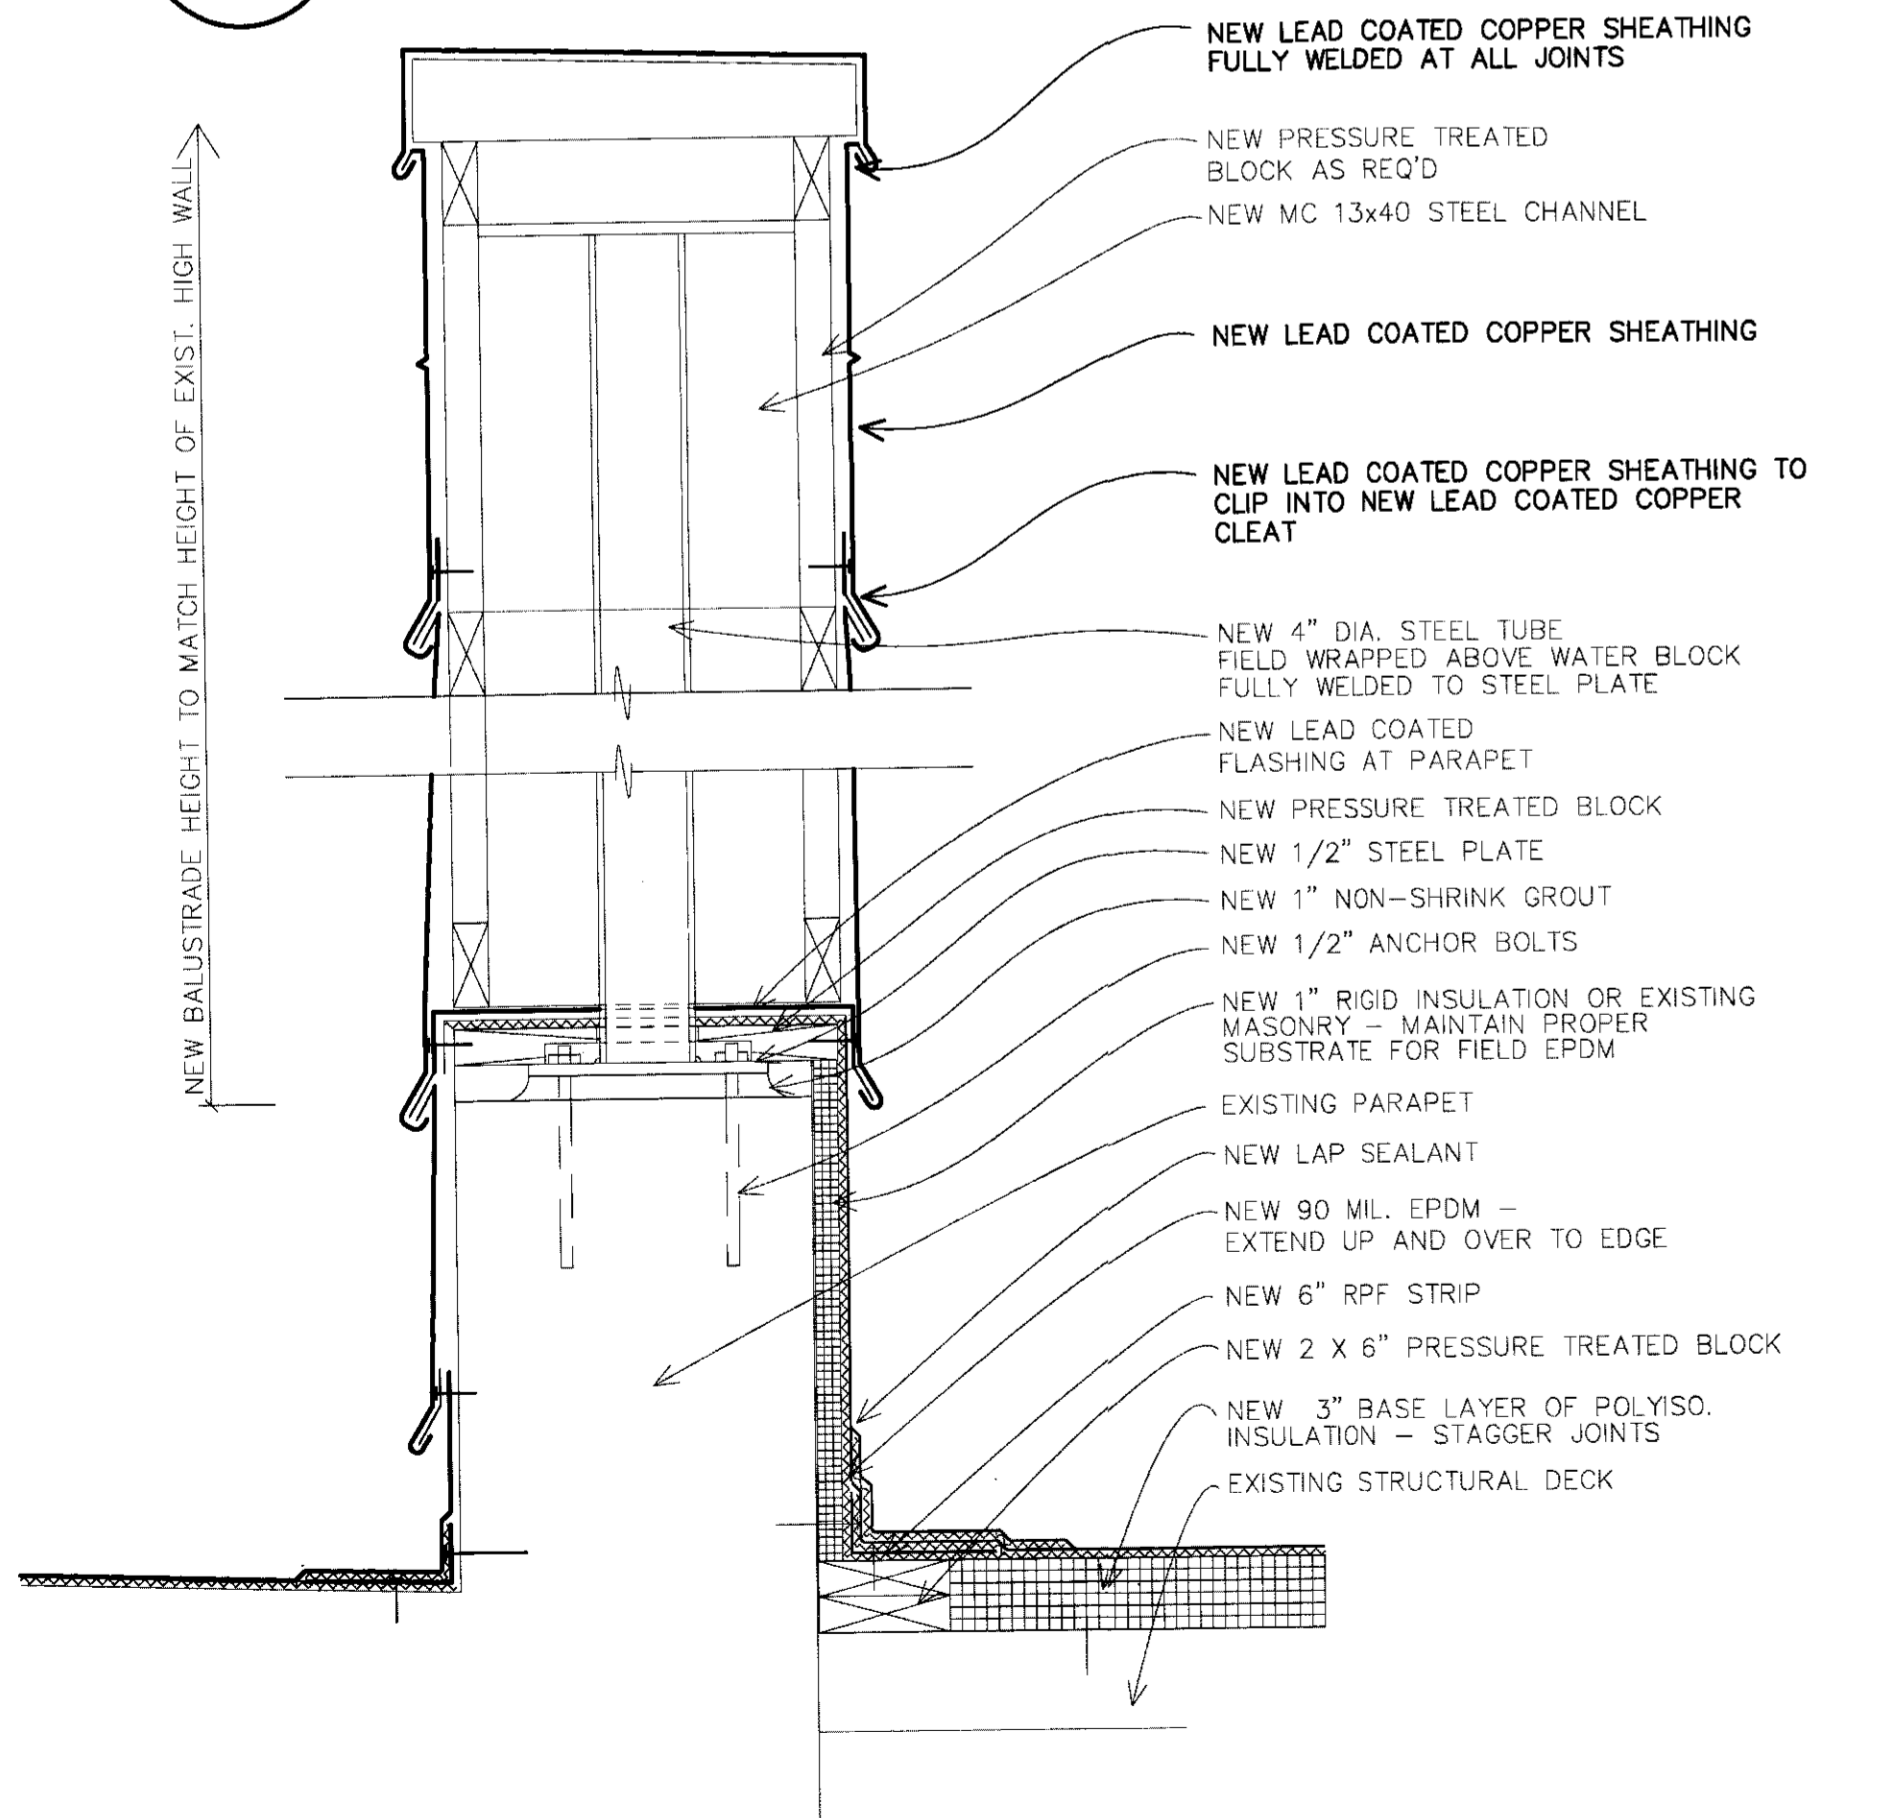


3 TYP BALUSTRADE REPLACEMENT DETAIL - TYPE 2
 SCALE: 1 1/2" = 1'-0"
 A4

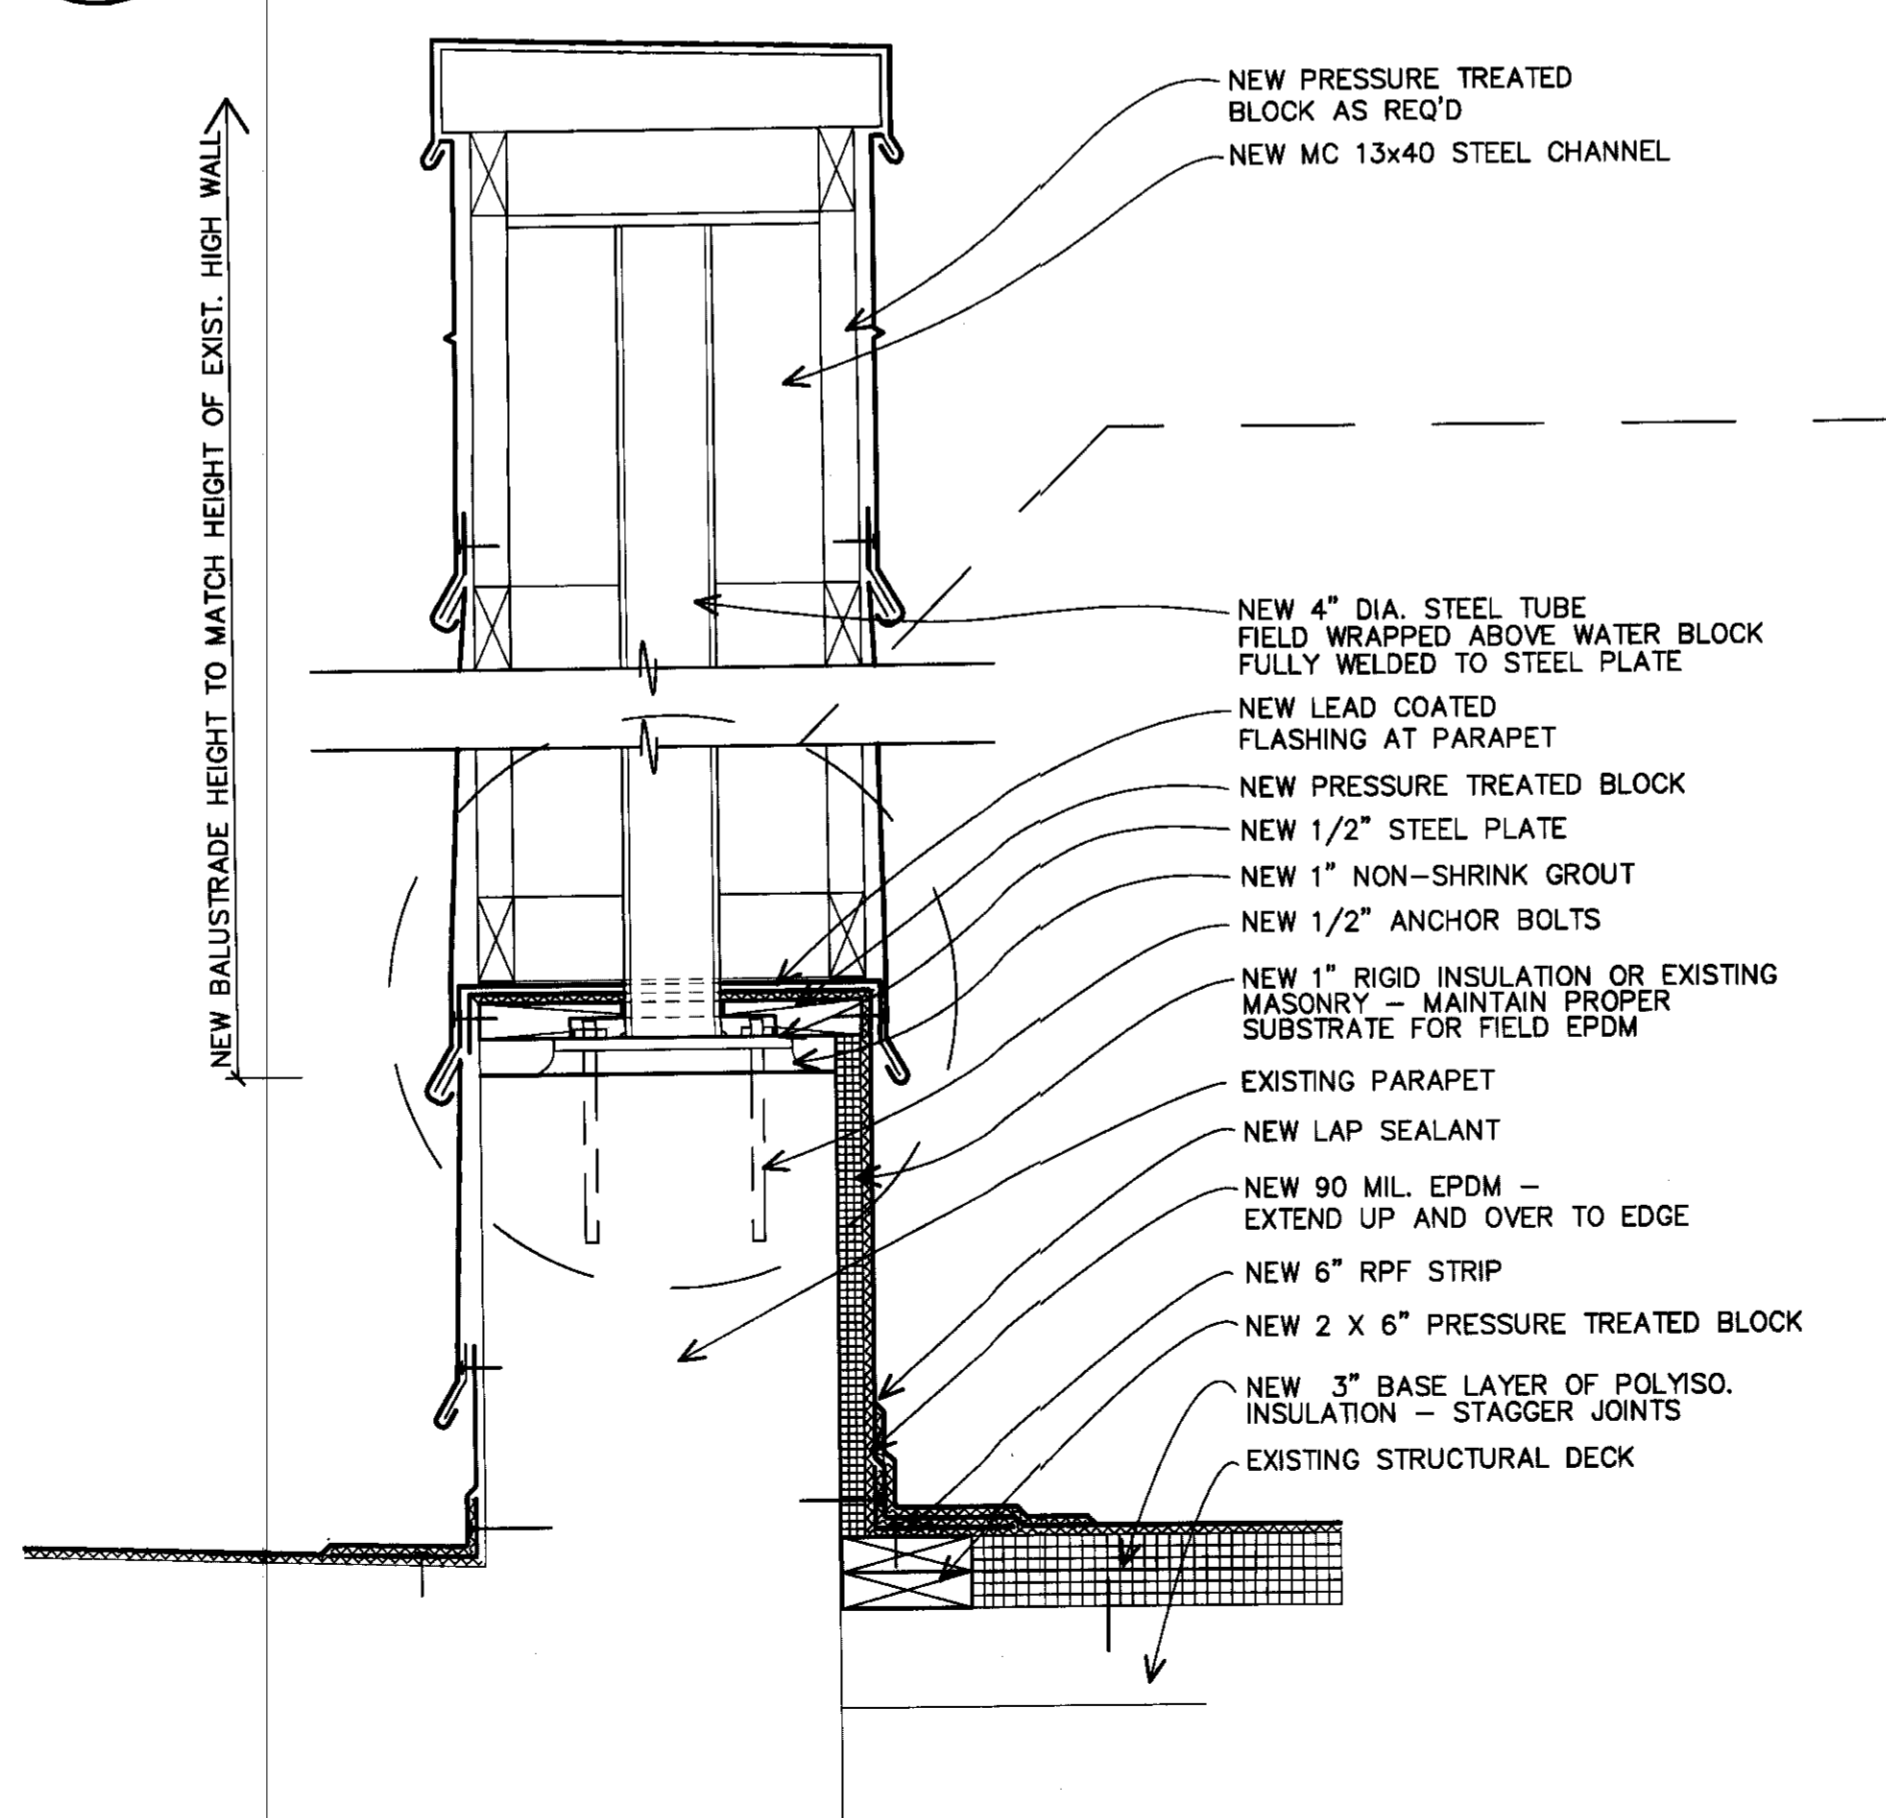

4 TYP THROUGH WALL FLASHING DETAIL - TYPE 2
 SCALE: 1 1/2" = 1'-0"
 A4

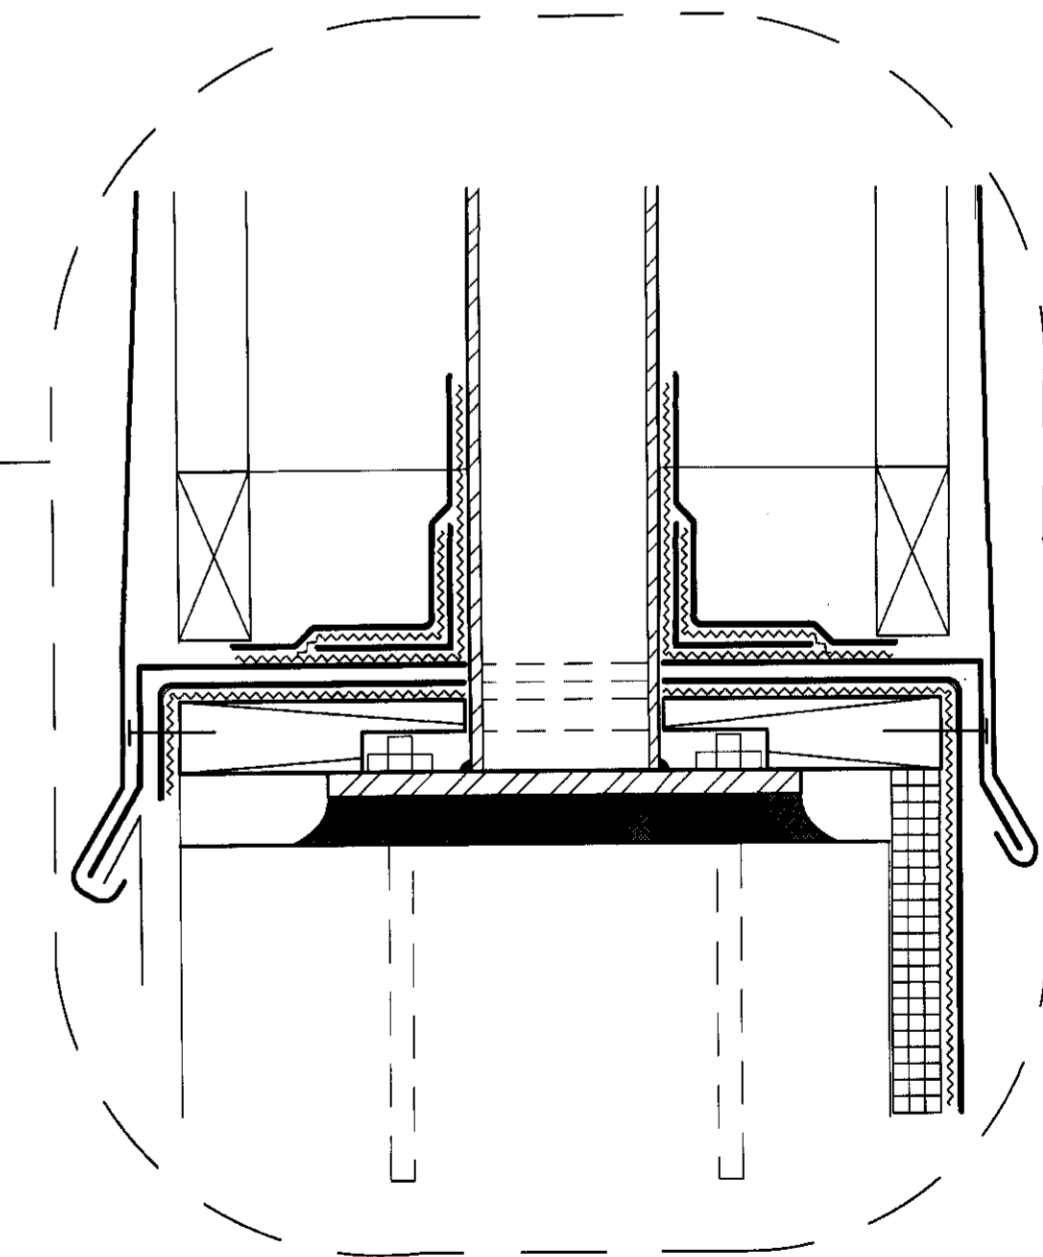

REVISIONS	
NO.	DATE

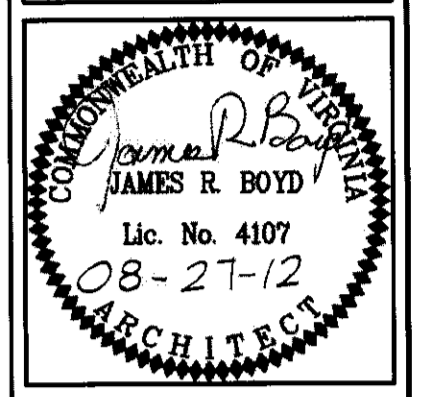

ISSUE:
CONSTR. DOC.S

HEYWARD BOYD ARCHITECTS, P.C.
 111 West High Street
 Charlottesville, Virginia 22902
 434-296-5353 434-971-6634 F
 FILE NAME: _____
 DRAWN BY: CAC, SH
 CHECKED BY: JRB


NEW ROOF DETAILS
 500 COURT SQUARE
 ROOF REPLACEMENT
 500 COURT SQUARE
 CHARLOTTESVILLE, VIRGINIA

DRAWING TITLE:
 PROJECT NAME:
 PROJECT NUMBER:
 1217
 SHEET NUMBER:
A4
 DATE:
 08.27.12



REVISIONS

Table with 2 columns: NO., DATE

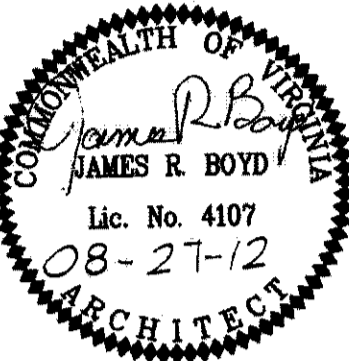

ISSUE: CONSTR. DOC.S

HEYWARD BOYD ARCHITECTS, P.C.
111 West High Street
Charlottesville, Virginia 22902
434-971-6634 F

HEB
500 COURT SQUARE
ROOF REPLACEMENT
CHARLOTTESVILLE, VIRGINIA

FILE NAME:
DRAWN BY: CAC, SH
CHECKED BY: JRB

DRAWING TITLE:
PROJECT NAME:
PROJECT NUMBER: 1217
SHEET NUMBER:

A6

DATE: 08.27.12

PAINTING PRIMERS:

EXTERIOR FERROUS-METAL PRIMER: FACTORY-FORMULATED RUST INHIBITIVE METAL PRIMER FOR EXTERIOR APPLICATION. BENJAMIN MOORE; INDUSTRIAL LATEX METAL PRIMER M04; APPLIED AT A DRY FILM THICKNESS OF NOT LESS THAN 1.1 MILS.

FINISH COATS (TWO COATS) EXTERIOR SEMI-GLOSS FOR METAL: FACTORY-FORMULATED SEMI-GLOSS WATERBORNE FOR EXTERIOR APPLICATION. BENJAMIN MOORE; ACRYLIC DTM SEMI-GLASS NO. M29; APPLIED AT A DRY FILM THICKNESS OF NOT LESS THAN 1.3 MILS.

CONCRETE SHALL MEET THE FOLLOWING STANDARDS: MINIMUM COMPRESSIVE STRENGTH: 3500 PSI AT 28 DAYS MINIMUM CEMENTITIOUS MATERIALS CONTENT: 520 LB/CU. YD.

CONCRETE FOR PATCHING WALKS AND STEPS SHALL BE RAPIDSET WONDERFIXX, MANUFACTURED BY CTS CEMENT MANUFACTURING CORPORATION; 1065 KNOTT AVENUE, SUITE A, CYPRESS, CA 90630.

PATCHING MATERIAL FOR THE PRECAST CONCRETE COPING SHALL BE JAN 90, MANUFACTURED BY CATHEDRAL STONE. INSTALLER SHALL BE AN APPLICATOR APPROVED AND TRAINED BY THE MANUFACTURER IN THE INSTALLATION OF PATCHING MATERIAL.

ALL BRICK SHALL BE CLAY MASONRY UNITS TO MATCH EXISTING. PROVIDE A SAMPLE PANEL WITH THE SELECTED MORTAR FOR THE OWNERS REVIEW. PROVIDE UNITS THAT MATCH EXISTING IN COLOR, SURFACE TEXTURE, AND SIZE.

WATERPROOFING SHALL BE THORSEAL T5010 SUPER THORSEAL. APPLY TWO COATS TO SURFACES REQUIRING WATERPROOFING. DO NOT APPLY WHEN AMBIENT TEMPERATURE IS BELOW 40 DEGREES F.

DELIVERY, STORAGE, AND HANDLING

DELIVER HOLLOW METAL WORK PALLETIZED, WRAPPED, OR CRATED TO PROVIDE PROTECTION DURING TRANSIT AND PROJECT-SITE STORAGE. DO NOT USE NONVENTED PLASTIC. DELIVER WELDED FRAMES WITH TWO REMOVABLE SPREADER BARS ACROSS BOTTOM OF FRAMES.

MATERIALS

COLD-ROLLED STEEL SHEET: ASTM A 1008/A 1008M, COMMERCIAL STEEL (CS), TYPE B; SUITABLE FOR EXPOSED APPLICATIONS. HOT-ROLLED STEEL SHEET: ASTM A 1011/A 1011M, COMMERCIAL STEEL (CS), TYPE B; FREE OF SCALE, PITCHING OR SURFACE DEFECTS; PICKLED AND OILED.

INSERTS, BOLTS, AND FASTENERS: HOT-DIP GALVANIZED ACCORDING TO ASTM A 153/A 153M. POWDER-ACTUATED FASTENERS IN CONCRETE: FASTENER SYSTEM OF TYPE SUITABLE FOR APPLICATION INDICATED, FABRICATED FROM CORROSION-RESISTANT MATERIALS.

STANDARD HOLLOW METAL DOORS

GENERAL: PROVIDE DOORS OF DESIGN INDICATED, NOT LESS THAN THICKNESS INDICATED; FABRICATED WITH SMOOTH SURFACES, WITHOUT VISIBLE JOINTS OR SEAMS ON EXPOSED FACES UNLESS OTHERWISE INDICATED. COMPLY WITH ANSI/SDI A250.8.

FRAME ANCHORS

JAMB ANCHORS: RETRO MASONRY TYPE: ADJUSTABLE STRAP-AND-STIRRUP OR T-SHAPED ANCHORS TO SUIT FRAME SIZE. NOT LESS THAN 0.042 INCH (1.0 MM) THICK, WITH CORRUGATED OR PERFORATED STRAPS NOT LESS THAN 2 INCHES (50 MM) WIDE BY 10 INCHES (250 MM) LONG; OR WIRE ANCHORS NOT LESS THAN 0.177 INCH (4.5 MM) THICK.

ALUMINUM STOREFRONTS WIND

SUBMITTALS: PROVIDE THE FOLLOWING: PRODUCT DATA: FOR EACH TYPE OF PRODUCT INDICATED. INCLUDE CONSTRUCTION DETAILS, MATERIAL DESCRIPTIONS, DIMENSIONS OF INDIVIDUAL COMPONENTS AND PROFILES, AND FINISHES FOR ALUMINUM-FRAMED SYSTEMS.

GUTTERS AND DOWNSPOUTS WILL REMAIN AND NOT BE REPLACED WITH THIS PROJECT.

METALS SUBMITTALS: PROVIDE THE FOLLOWING:

- 1.PRODUCT DATA, FLASHING, SHEET METAL, FASTENERS, AND ACCESSORIES; MANUFACTURER'S TECHNICAL PRODUCT DATA, COLOR SELECTION FOR PRE-FINISHED METALS, AND GENERAL RECOMMENDATIONS FOR EACH SPECIFIED SHEET MATERIAL AND FABRICATED PRODUCT.

GENERAL: INSTALL SHEET METAL FLASHING AND TRIM TO WITHSTAND WIND LOADS, STRUCTURAL MOVEMENT, THERMALLY INDUCED MOVEMENT, AND EXPOSURE TO WEATHER WITHOUT FAILING.

PROJECT CONDITIONS

COORDINATE WORK OF THIS SECTION WITH INTERFACING AND ADJOINING WORK FOR PROPER SEQUENCING OF EACH INSTALLATION. ENSURE BEST POSSIBLE WEATHER RESISTANCE AND DURABILITY OF WORK AND PROTECTION OF MATERIALS AND FINISHES.

SHEET METAL FLASHING AND TRIM MATERIALS

A.ZINC-TIN ALLOY-COATED STAINLESS-STEEL SHEET: ASTM A 240/A 240M, TYPE 304, DEAD-SOFT, FULLY ANNEALED STAINLESS-STEEL SHEET OF MINIMUM UNCOATED THICKNESS INDICATED; COATED ON BOTH SIDES WITH A ZINC-TIN ALLOY (50 PERCENT ZINC, 50 PERCENT TIN), WITH FACTORY-APPLIED GRAY PREWEATHERING, 28 GAUGE (0.015) EXCEPT AS OTHERWISE INDICATED.

1.ORNAMENTAL TRIM AND EXPOSED CORNICE CAPS.

C. COPPER ASTM B 370, COLD-ROLLED COPPER SHEET, H00 TEMPER, UNLESS OTHERWISE INDICATED. WEIGHT (THICKNESS): .16 OZ./SQ. FT., - PROVIDE AT THE FOLLOWING LOCATIONS:

1.COUNTER FLASHING.

FABRICATED UNITS

A.GENERAL METAL FABRICATION: SHOP-FABRICATE WORK TO GREATEST EXTENT POSSIBLE. COMPLY WITH DETAILS SHOWN AND WITH APPLICABLE REQUIREMENTS OF SMACNA ARCHITECTURAL SHEET METAL MANUAL AND OTHER RECOGNIZED INDUSTRY PRACTICES.

1.DAMAGED, SCRATCHED, OR DIMPLED SECTIONS OF PREFINISHED METAL SHALL BE REPLACED PRIOR TO INSTALLATION OF SLATE SHINGLES. FIELD TOUCH UP PAINTING WILL NOT BE ACCEPTED.

EXPANSION PROVISIONS: WHERE LAPPED OR BAYONET-TYPE EXPANSION PROVISIONS IN WORK CANNOT BE USED OR WOULD NOT BE SUFFICIENTLY WATER/WEATHERPROOF, FORM EXPANSION JOINTS OF INTERMESHING HOOKED FLANGES, NOT LESS THAN 1 INCH DEEP, FILLED WITH MASTIC SEALANT (CONCEALED WITHIN JOINTS).

SEALANT JOINTS: WHERE MOVABLE, NONEXPANSION TYPE JOINTS ARE INDICATED OR REQUIRED FOR PROPER PERFORMANCE OF WORK, FORM METAL TO PROVIDE FOR PROPER INSTALLATION OF ELASTOMERIC SEALANT, IN COMPLIANCE WITH SMACNA STANDARDS.

SEPARATIONS: PROVIDE FOR SEPARATION OF METAL FROM NONCOMPATIBLE METAL OR CORROSIVE SUBSTRATES BY COATING CONCEALED SURFACES AT LOCATIONS OF CONTACT, WITH BITUMINOUS COATING OR OTHER PERMANENT SEPARATION AS RECOMMENDED BY MANUFACTURER/FABRICATOR.

SHOP FINISH FOR FASTENERS: PROVIDE SCREWS, NAILS, AND RIVETS WITH SAME FINISH AS SHEET METAL.

ALL SHEET METAL SHALL BE SHOP FABRICATED WITH ALL BENDS BRAKE FORMED.

CORNERS AND OTHER TRANSITION PIECES SHALL BE SHOP-MANUFACTURED; JOINTS AND SEAMS SHALL BE LAPPED, RIVETED TO FORM COMPLETE, WATERTIGHT UNITS.

INSTALLATION REQUIREMENTS

GENERAL: EXCEPT AS OTHERWISE INDICATED, COMPLY WITH MANUFACTURER'S INSTALLATION INSTRUCTIONS AND RECOMMENDATIONS AND WITH SMACNA ARCHITECTURAL SHEET METAL MANUAL. ANCHOR UNITS OF WORK SECURELY IN PLACE BY METHODS INDICATED, PROVIDING FOR THERMAL EXPANSION OF METAL UNITS; CONCEAL FASTENERS WHERE POSSIBLE, AND SET UNITS TRUE TO LINE AND LEVEL AS INDICATED.

CLEANING AND PROTECTION

CLEAN EXPOSED METAL SURFACES, REMOVING SUBSTANCES THAT MIGHT CAUSE CORROSION OF METAL OR DETERIORATION OF FINISHES.

PROTECTION: ADVISE CONTRACTOR OF REQUIRED PROCEDURES FOR SURVEILLANCE AND PROTECTION OF FLASHINGS AND SHEET METAL WORK DURING CONSTRUCTION TO ENSURE THAT WORK WILL BE WITHOUT DAMAGE OR DETERIORATION OTHER THAN NATURAL WEATHERING AT TIME OF SUBSTANTIAL COMPLETION.

HOLLOW METAL DOORS AND FRAMES

- PERFORM ALL STANDARD HOLLOW METAL WORK: HOLLOW METAL WORK FABRICATED ACCORDING TO ANSI/SDI A250.8.
- 1.SUBMITTALS: SUBMIT THE FOLLOWING: PRODUCT DATA: FOR EACH TYPE OF PRODUCT INDICATED. INCLUDE CONSTRUCTION DETAILS, MATERIAL DESCRIPTIONS, CORE DESCRIPTIONS, FIRE-RESISTANCE RATING, AND FINISHES.
- 2.SHOP DRAWINGS: INCLUDE THE FOLLOWING: 2.ELEVATIONS OF EACH DOOR DESIGN.
- 3.DETAILS OF DOORS, INCLUDING VERTICAL AND HORIZONTAL EDGE DETAILS AND METAL THICKNESSES.
- 4.FRAME DETAILS FOR EACH FRAME TYPE, INCLUDING DIMENSIONED PROFILES AND METAL THICKNESSES.
- 5.LOCATIONS OF REINFORCEMENT AND PREPARATIONS FOR HARDWARE.
- 6.DETAILS OF EACH DIFFERENT WALL OPENING CONDITION.
- 7.DETAILS OF ANCHORAGES, JOINTS, FIELD SPLICES, AND CONNECTIONS.
- 8.PRODUCT TEST REPORTS: BASED ON EVALUATION OF COMPREHENSIVE TESTS PERFORMED BY A QUALIFIED TESTING AGENCY, FOR EACH TYPE OF HOLLOW METAL DOOR AND FRAME ASSEMBLY.
- 9.QUALITY ASSURANCE: ASSEMBLIES COMPLYING WITH NFPA 80 THAT ARE LISTED AND FIRE-RATED DOOR ASSEMBLIES: ASSEMBLIES COMPLYING WITH NFPA 80 THAT ARE LISTED AND LABELED BY A QUALIFIED TESTING AGENCY. PROVIDE 45 MINUTE RATED DOORS AND FRAMES.

CITY OF CHARLOTTESVILLE
"A World Class City"

Department of Neighborhood Development Services

City Hall Post Office Box 911
Charlottesville, Virginia 22902
Telephone 434-970-3182
Fax 434-970-3359
www.charlottesville.org



AFFIDAVIT OF MAILING

To File: 500 Court Square (BAR 13-03-03)

I, Kristin Rourke, being first duly sworn, hereby certify that I mailed the attached letter, by first class United States Mail, to the addresses shown on this affidavit on March 5, 2013.

Signed:

Kristin Rourke

ADDRESSES


See Attachments

STATE OF VIRGINIA

CITY OF CHARLOTTESVILLE, to-wit:

The foregoing instrument was acknowledged before me this 13th day of MARCH 2013, by Kristin Rourke.

My Commission Expires: AUGUST 31 2015

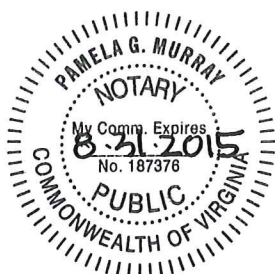

pamelagmurray
Notary Public

CITY OF CHARLOTTESVILLE

"A World Class City"

Department of Neighborhood Development Services

City Hall Post Office Box 911
Charlottesville, Virginia 22902
Telephone 434-970-3182
Fax 434-970-3359
www.charlottesville.org



March 1, 2013

Dear Sir or Madam:

This letter is to notify you that the following application has been submitted for review by the City of Charlottesville Board of Architectural Review on property that is either abutting or immediately across a street from your property, or that has frontage on the same city street block.

Certificate of Appropriateness Application

BAR 13-03-03
500 Court Square
Tax Map 53 Parcel 96
James C. Weatherford, Applicant
500 Court Square Association, Owner
Reroof and replace balustrade

The Board of Architectural Review (BAR) will consider these applications at a meeting to be held on **Tuesday, March 19, 2013, starting at 5:30 pm in City Council Chambers, City Hall.** Enter City Hall from the Main Street pedestrian mall entrance and go up to 2nd floor.

An agenda with approximate times and additional application information will be available on the BAR's home page accessible through <http://www.charlottesville.org>. If you need more information, please do not hesitate to contact me at 434-970-3130 or scala@charlottesville.org.

Sincerely yours,

A handwritten signature in black ink that reads "Mary Joy Scala".

Mary Joy Scala, AICP
Preservation and Design Planner

1780 INN AT COURT SQUARE, LLC
410 E JEFFERSON ST
CHARLOTTESVILLE, VA 22902

418 EAST JEFFERSON STREET, LLC
2362 GLEN ECHO FARM
CHARLOTTESVILLE, VA 22911

ABELL, THAD SAMUELS, II & DENISE M
3221 MILLINGTON ROAD
CROZET, VA 22932

ARGAND HOLDINGS III LLC
2001 KIRBY DRIVE STE 1210
HOUSTON, TX 77019

BISHOP, DANNY M & KELLIE M,
1930 BARRON CT
CHARLOTTESVILLE, VA 22911

BOSWORTH, PRISCILLA F, TRUSTEE
REAL PROPERTY, INC1500 AMHERST ST
CHARLOTTESVILLE, VA 22903

BRYANT, MILFORD
2391 LAUREL ROAD
SHIPMAN, VA 22971

CURTIS, WILLIAM CRAIG
500 COURT SQUARE #305
CHARLOTTESVILLE,VA 22902

DELANY, PATRICIA B
102 BLUEBERRY ROAD
CHARLOTTESVILLE, VA 22911

DONOVAN, JAMES P & EILEEN
312 13TH STREET NW #35
CHARLOTTESVILLE, VA 22903

FEIGERT, FRANK B & FRANCES G,
500 COURT SQUARE 404
CHARLOTTESVILLE, VA 22902

HOBART, ROBERT HBWS JR
500 COURT SQUARE 702
CHARLOTTESVILLE, VA 22902

JAHN, HANS U
500 COURT SQ 503
CHARLOTTESVILLE, VA 22902

JOHNSON, W REED & VIVIEN R
1681 OTTOMAN FERRY ROAD
LANCASTER, VA 22503

MANN, WILDA LARA DICKERSON
1613 OXFORD ROAD
CHARLOTTESVILLE, VA 22903

MCFALLS, ARNOLD
824 BONNIE GLEN DRIVE
MARIETTA, GA 30067

MICHIE, THOMAS J JR TR
P O BOX 298
CHARLOTTESVILLE, VA 22902

MILGRAUM, LEONARD, TRUSTEE
1800 COURT SQUARE ROOM 8
CHARLOTTESVILLE, VA 22902

MULLER, WILLIAM F TRUSTEES
1455 GRAY STONE COURT
CHARLOTTESVILLE, VA 22902

O'BRIEN, AMELIA C
599 DICE ST UNIT A
CHARLOTTESVILLE, VA 22903

O'BRIEN, AMELIA C, TRUSTEE
500 COURT SQ UNIT 806
CHARLOTTESVILLE, VA 22902

ROBERTSON, JEAN & JAMES LINDSAY
P O BOX 52889
ATLANTA, GA 30355

SHAW, RONALD T & KATHERINE D
411 CHIMNEY ROCK RD
EARLYSVILLE, VA 22936

SIBLEY, WILLIAM L
500 COURT SQUARE 802
CHARLOTTESVILLE, VA 22902

SIMS, A WARD, TRUSTEE
710 E HIGH ST
CHARLOTTESVILLE, VA 22902

SNL SECURITIES
P O BOX 2124
CHARLOTTESVILLE, VA 22902

STICK, CHARLES J
500 COURT SQUARE 502
CHARLOTTESVILLE, VA 22902

SYBICKI, MARIANA, TRUSTEE
2029 LOCKWOOD DR APT 226
CHARLOTTESVILLE, VA 22911

VIRGINIA BROADCASTING CORP
P O BOX 769
CHARLOTTESVILLE, VA 22902

WILCOX, MINER W M
2256 CABELL ROAD
WINGINA, VA 24459

TAYLOR, MARTHA G
500 COURT SQ #607
CHARLOTTESVILLE, VA 22902

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