# Antenna System Upgrade Project

**APPROVED** 

DIRECTIONS:

By Keith Edwards at 2:10 pm, Feb 09, 2015



By Steve McCormick at 1:37 pm, Feb 02, 2015



- LTE AC/3C
- CONSOLIDATE GSM/UMTS ANTENNAS
- INSTALL LTE 1900 ANTENNAS
- INSTALL LTE 1900 RRHs
- IMPROVE QUALITY OF SERVICE

AT&T MOBILITY
SITE NUMBER: CV305

SITE NAME: COURT SQUARE - FA# 10068631

**BUILDING OWNER: 500 COURT SQUARE ASSOCIATION** 

SCOPE OF

SHEET	DRAWING INDEX	REV	DATE
T1	TITLE SHEET	0	2/2/15
C1	GENERAL NOTES	0	2/2/15
C2.1	SITE PLAN	0	2/2/15
C2.2	ENLARGED PLATFORM LAYOUT	0	2/2/15
С3	ELEVATION VIEW & RF DETAILS	0	2/2/15
C4	ANTENNAS/COAX CABLE SCHEMATIC	0	2/2/15
E1	GROUNDING & RF NOTES	0	2/2/15
E2	GROUNDING DETAILS & COLOR CODE CHART	0	2/2/15

AT&T


VELOCITEL

OWNER

MUNICIPAL

FROM AT&T OFFICE, START OUT GOING SOUTHWEST ON COX RD TOWARD N PARK DR. TAKE THE 1ST RIGHT ONTO NUCKOLS RD. MERGE ONTO I-295 S TOWARD I-64 W/CHARLOTTESVILLE. MERGE ONTO I-64 W VIA EXIT 53A TOWARD CHARLOTTESVILLE. TAKE THE US-250 EXIT, EXIT 124, TOWARD CHARLOTTESVILLE/SHADWELL. TURN RIGHT ONTO RICHMOND RD/US-250 W. TURN LEFT ONTO E HIGH ST/US-250 BUS W/VA-2. TURN RIGHT ONTO E HIGH ST. TAKE THE 3RD LEFT ONTO PARK ST. TURN RIGHT ONTO E JEFFERSON ST. BUILDING WILL BE ON THE LEFT.

# VICINITY MAP

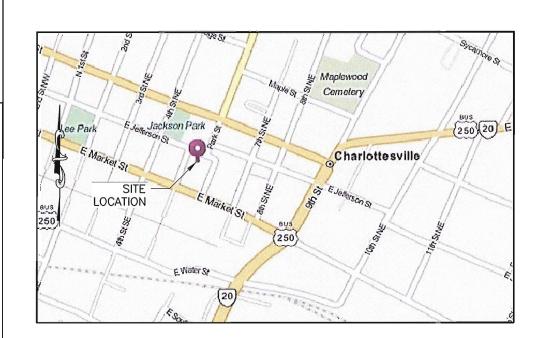

NOT TO SCALE

REMOVE (3) EXISTING GSM ANTENNAS AND (3) EXISTING UMTS ANTENNAS. INSTALL (3) NEW LTE 1900 ANTENNAS AND (3) NEW GSM/UMTS ANTENNAS. INSTALL (3) NEW RRUS TO EXISTING SLED MOUNTS. INSTALL (1) FC12 FIBER/POWER DIST. BOX. (3) DC2 SURGE SUPPRESSORS. (1) FIBER

DIST. BOX, (3) DC2 SURGE SUPPRESSORS, (1) FIBER TRUNK AND (2) DC TRUNKS. INSTALL (1) RBS 6601 IN EXISTING EQUIPMENT RACK.

SITE 500 COURT SQUARE

ADDRESS: CHARLOTTESVILLE, VA 22902

OWNER: 500 COURT SQUARE ASSOCIATION

CONTACT PERSON: PETER MILLER/SIDNEY SUTTON, BROADCAST SERVICES

SITE INFORMATION

(317) 895-9050

APPLICANT: AT&T MOBILITY
4801 COX ROAD. SUITE 300

GLEN ALLEN, VA 23060

LATITUDE (NAD 83): 38° 01′ 54.98″ (38.031939) LONGITUDE (NAD 83): -78° 28′ 41.02″ (-78.478061)

CURRENT USE: PROPOSED USE:

TELECOMMUNICATIONS FACILITY
TELECOMMUNICATIONS FACILITY

JURISDICTION: CITY OF CHARLOTTESVILLE

# SITE QUALIFICATION PARTICIPANTS

	<u>NAME</u>	<u>COMPANY</u>	<u>NUMBER</u>
A/E	DAN COSTELLO	VELOCITEL	(315) 717-6547
SAC	JOAN STEWART	VELOCITEL	(503) 539-4449
СМ	STEVEN MCCORMICK	VELOCITEL	(757) 508-2154

WILLIAM PANEK
Lic. No. 034732

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APPROVED BY:

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4164 INNSLAKE DRIVE, SUITE B GLEN ALLEN, VA 23060 (804) 217-7088 (MAIN) (757) 401-6453 (FAX)

DATE

DATE

DATE

DATE



LIBERTY PLAZA 1 4801 COX ROAD, SUITE 300 GLEN ALLEN, VA 23060 LTE AC/3C SITE NO. CV305 COURT SQUARE FA# 10068631

FA# 10068631 500 COURT SQUARE CHARLOTTESVILLE, VA 22902

0	2/2/15	ISSUED FOR CONSTRUCTION	SRN	SRN	1	
Α	1/16/15	ISSUED FOR REVIEW	SRN	LAM	-	
NO.	DATE	REVISIONS	BY	снк	APP'D	J

TITLE SHEET

 1/16/15
 ISSUED FOR REVIEW
 SRN LAM 

 DATE
 REVISIONS
 BY CHK APP'D JOB # DRAWING NUMBER
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#### **GENERAL NOTES:**

- THE PROPOSED FACILITY WILL BE UNMANNED AND DOES NOT REQUIRE POTABLE WATER OR SEWER SERVICE AND IS NOT FOR HUMAN HABITAT, (NO HANDICAP ACCESS IS REQUIRED),
- OCCUPANCY IS LIMITED TO PERIODIC MAINTENANCE AND INSPECTION. APPROXIMATELY 2 TIMES PER MONTH, BY AT&T TECHNICIANS.
- NO NOISE, SMOKE, DUST, ODOR OR VIBRATIONS WILL RESULT FROM THIS PROPOSAL.
- OUTDOOR STORAGE AND SOLID WASTE CONTAINERS ARE NOT PROPOSED.
- ALL MATERIAL SHALL BE FURNISHED AND WORK SHALL BE PERFORMED IN ACCORDANCE WITH THE AT&T SYSTEM GROUNDING STANDARD DATED JUNE 2011, "TECHNICAL SPECIFICATION FOR CONSTRUCTION OF GSM/GPRS WIRELESS SITES, "TECHNICAL SPECIFICATION FOR FACILITY GROUNDING". IN CASE OF A CONFLICT BETWEEN THE CONSTRUCTION SPECIFICATION AND THE DRAWINGS, THE DRAWINGS SHALL GOVERN.
- SUBCONTRACTOR SHALL BE RESPONSIBLE FOR REPAIRING ANY DAMAGE CAUSED BY THE CONSTRUCTION OPERATION.
- SUBCONTRACTOR SHALL BE RESPONSIBLE FOR OBTAINING ALL PERMITS AND INSPECTIONS REQUIRED FOR CONSTRUCTION.
- SUBCONTRACTOR SHALL REMOVE ALL TRASH AND DEBRIS FROM THE SITE ON A DAILY BASIS.
- 9. INFORMATION SHOWN ON THESE DRAWINGS WAS OBTAINED FROM SITE VISITS AND DRAWINGS PROVIDED BY THE SITE OWNER. SUBCONTRACTOR SHALL NOTIFY AT&T OF ANY DISCREPANCIES PRIOR TO ORDERING MATERIAL OR PROCEEDING WITH CONSTRUCTION.
- NO WHITE STROBIC LIGHTS ARE PERMITTED. LIGHTING, IF REQUIRED, WILL MEET FAA STANDARDS AND REQUIREMENTS.
- ALL SIGNS SHALL BE FURNISHED AND INSTALLED AT ALL AT&T WIRELESS SERVICES SITES IN ACCORDANCE WITH SPECIFICATION AT&T SYSTEM GROUNDING DATED JUNE 2011.
- 12. NO ADDITIONAL PARKING TO BE PROPOSED, EXISTING ACCESS AND PARKING TO BE USED.
- NO LANDSCAPING IS PROPOSED AT THIS SITE.

14

TYPICAL MI	NIMUM BEND	RADII
COAX DIAMETER	ANDREW	COMMSCOPE
1/2" SUPERFLEX	1.25"	1.25"
1/2"	5"	2"
7/8"	10"	5"
1 1/4"	15"	8"
1 5/8"	20"	15"


ALL COAXIAL CABLE INSTALLATIONS TO FOLLOW MANUFACTURER'S INSTRUCTIONS.

#### **GENERAL NOTES:**


- 1. FOR THE PURPOSE OF CONSTRUCTION DRAWINGS, THE FOLLOWING DEFINITIONS SHALL APPLY: CONTRACTOR - CONTRACTOR SUBCONTRACTOR - GENERAL CONTRACTOR (CONSTRUCTION) OWNER - AT&T WIRELESS
- 2. ALL SITE WORK SHALL BE COMPLETED AS INDICATED ON THE DRAWINGS AND PROJECT
- 3. DRAWINGS PROVIDED HERE ARE NOT TO BE SCALED AND ARE INTENDED TO SHOW OUTLINE ONLY.
- 4, ALL MATERIALS FURNISHED AND INSTALLED SHALL BE IN STRICT ACCORDANCE WITH ALL APPLICABLE CODES, REGULATIONS, AND ORDINANCES. SUBCONTRACTOR SHALL ISSUE ALL APPROPRIATE NOTICES AND COMPLY WITH ALL LAWS, ORDINANCES, RULES, REGULATIONS, AND LAWFUL ORDERS OF ANY PUBLIC AUTHORITY REGARDING THE PERFORMANCE OF THE WORK.
- 5. ALL WORK CARRIED OUT SHALL COMPLY WITH ALL APPLICABLE MUNICIPAL AND UTILITY COMPANY SPECIFICATIONS AND LOCAL JURISDICTIONAL CODES, ORDINANCES AND APPLICABLE REGULATIONS.
- 6. UNLESS NOTED OTHERWISE, THE WORK SHALL INCLUDE FURNISHING MATERIALS, EQUIPMENT, APPURTENANCES, AND LABOR NECESSARY TO COMPLETE ALL INSTALLATIONS AS INDICATED ON
- 7. THE SUBCONTRACTOR SHALL INSTALL ALL EQUIPMENT AND MATERIALS IN ACCORDANCE WITH MANUFACTURER'S RECOMMENDATIONS UNLESS SPECIFICALLY STATED OTHERWISE.
- 8. IF THE SPECIFIED EQUIPMENT CANNOT BE INSTALLED AS SHOWN ON THESE DRAWINGS, THE SUBCONTRACTOR SHALL PROPOSE AN ALTERNATIVE INSTALLATION SPACE FOR APPROVAL BY THE CONTRACTOR AND SITE OWNER.
- 9. THE SUBCONTRACTOR SHALL PROTECT EXISTING IMPROVEMENTS, PAVEMENTS, CURBS, LANDSCAPING AND STRUCTURES, ANY DAMAGED PART SHALL BE REPAIRED AT SUBCONTRACTOR'S EXPENSE TO THE SATISFACTION OF OWNER.
- 10. THE SUBCONTRACTOR SHALL CONTACT UTILITY LOCATING SERVICES PRIOR TO THE START OF
- 11. ALL EXISTING ACTIVE SEWER, WATER, GAS, ELECTRIC, AND OTHER UTILITIES WHERE ENCOUNTERED IN THE WORK, SHALL BE PROTECTED AT ALL TIMES, AND WHERE REQUIRED FOR THE PROPER EXECUTION OF THE WORK, SHALL BE RELOCATED AS DIRECTED BY ENGINEERS. EXTREME CAUTION SHOULD BE USED BY THE SUBCONTRACTOR WHEN EXCAVATING OR DRILLING PIERS AROUND OR NEAR UTILITIES, SUBCONTRACTOR SHALL PROVIDE SAFETY TRAINING FOR THE WORKING CREW. THIS WILL INCLUDE BUT NOT BE LIMITED TO A) FALL PROTECTION, B) CONFINED SPACE, C) ELECTRICAL SAFETY & D) TRENCHING & EXCAVATION.
- 12. ALL EXISTING INACTIVE SEWER, WATER, GAS, ELECTRIC AND OTHER UTILITIES, WHICH INTERFERE WITH THE EXECUTION OF THE WORK, SHALL BE REMOVED AND/OR CAPPED, PLUGGED OR OTHERWISE DISCONTINUED AT POINTS WHICH WILL NOT INTERFERE WITH THE EXECUTION OF THE WORK, AS DIRECTED BY THE RESPONSIBLE ENGINEER, AND SUBJECT TO THE APPROVAL OF THE OWNER AND/OR LOCAL UTILITIES
- 13. THE AREAS OF THE OWNER'S PROPERTY DISTURBED BY THE WORK AND NOT COVERED BY THE TOWER, EQUIPMENT OR DRIVEWAY, SHALL BE GRADED TO A UNIFORM SLOPE, AND STABILIZED TO
- 14. SUBCONTRACTOR SHALL MINIMIZE DISTURBANCE TO EXISTING SITE DURING CONSTRUCTION. EROSION CONTROL MEASURES, IF REQUIRED DURING CONSTRUCTION, SHALL BE IN CONFORMANCE WITH THE LOCAL GUIDFLINES FOR FROSION AND SEDIMENT CONTROL
- 15. NO FILL OR EMBANKMENT MATERIAL SHALL BE PLACED ON FROZEN GROUND. FROZEN MATERIALS, SNOW OR ICE SHALL NOT BE PLACED IN ANY FILL OR EMBANKMENT.
- 16. THE SUB GRADE SHALL BE COMPACTED AND BROUGHT TO A SMOOTH UNIFORM GRADE PRIOR TO FINISHED SURFACE APPLICATION.
- 17. THE SITE SHALL BE GRADED TO CAUSE SURFACE WATER TO FLOW AWAY FROM THE BTS EQUIPMENT.
- 18. IF NECESSARY, RUBBISH, STUMPS, DEBRIS, STICKS, STONES AND OTHER REFUSE SHALL BE REMOVED FROM THE SITE AND DISPOSED OF LEGALLY.
- 19. THE SUBCONTRACTOR SHALL PROVIDE SITE SIGNAGE IN ACCORDANCE WITH OSHA REGULATIONS.
- 20. SUBCONTRACTOR SHALL LEAVE PREMISES IN A CLEAN CONDITION.

### STRUCTURAL STEEL NOTES:

- 1. ALL STEEL WORK SHALL BE PAINTED IN ACCORDANCE WITH THE PROJECT SPECIFICATIONS AND IN ACCORDANCE WITH ASTM A36 UNLESS OTHERWISE NOTED.
- 2. ALL WELDING SHALL BE PERFORMED USING E70XX ELECTRODES AND WELDING SHALL CONFORM TO AISC AND AWS D1.1. WHERE FILLET WELD SIZES ARE NOT SHOWN, PROVIDE THE MINIMUM SIZE PER TABLE J2.4 IN THE AISC "MANUAL OF STEEL CONSTRUCTION". PAINTED SURFACES SHALL BE TOUCHED UP.
- 3. BOLTED CONNECTIONS SHALL BE ASTM A325 BEARING TYPE (3/4"ø) CONNECTIONS AND SHALL HAVE MINIMUM OF TWO BOLTS UNLESS NOTED OTHERWISE.
- 4. NON-STRUCTURAL CONNECTIONS FOR STEEL GRATING MAY USE 5/8" DIA. ASTM A 307 BOLTS UNLESS NOTED OTHERWISE.
- 5. INSTALLATION OF CONCRETE EXPANSION/WEDGE ANCHOR, SHALL BE PER MANUFACTURER'S WRITTEN RECOMMENDED PROCEDURE. THE ANCHOR BOLT, DOWEL OR ROD SHALL CONFORM TO MANUFACTURER'S RECOMMENDATION FOR EMBEDMENT DEPTH OR AS SHOWN ON THE DRAWINGS, NO REBAR SHALL BE CUT WITHOUT PRIOR ENGINEERING APPROVAL WHEN DRILLING HOLES IN CONCRETE. SPECIAL INSPECTIONS, REQUIRED BY GOVERNING CODES, SHALL BE PERFORMED IN ORDER TO MAINTAIN MANUFACTURER'S MAXIMUM ALLOWABLE LOADS.
- 6. ALL METAL WORK SHALL BE GALVANIZED IN ACCORDANCE WITH SPECIFICATION ASTM A123. ALL SHOP WELDED MEMBERS SHALL BE GALVANIZED AFTER WELDING.

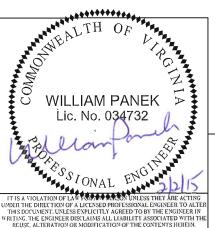



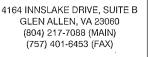



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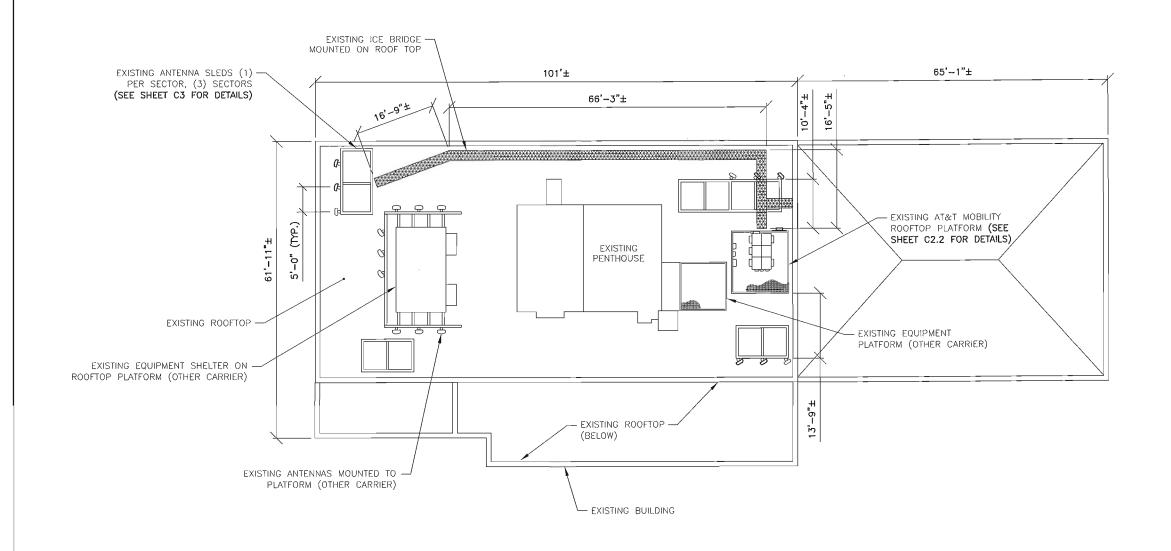
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Α	1/16/15	ISSUED FOR REVIEW	SRN	LAM	-	
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DESIGNED: SRN

CHECKED: LAM

**GENERAL NOTES** 

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# SYMBOLS AND MATERIALS



DETAIL REFERENCE



SECTIONS AND DETAILS

—— PDU ALARM CABLE

CONCRETE

EARTH

GRAVEL/STONE

# SITE LEGEND

	PROPERTY LINE
xxx	FENCE LINE
РР	PDU POWER CABLE
———ВТ———	BIAS "T" CABLE



CALLED NORTH



WILL.

SITE PLAN
SCALE: 1"=20'







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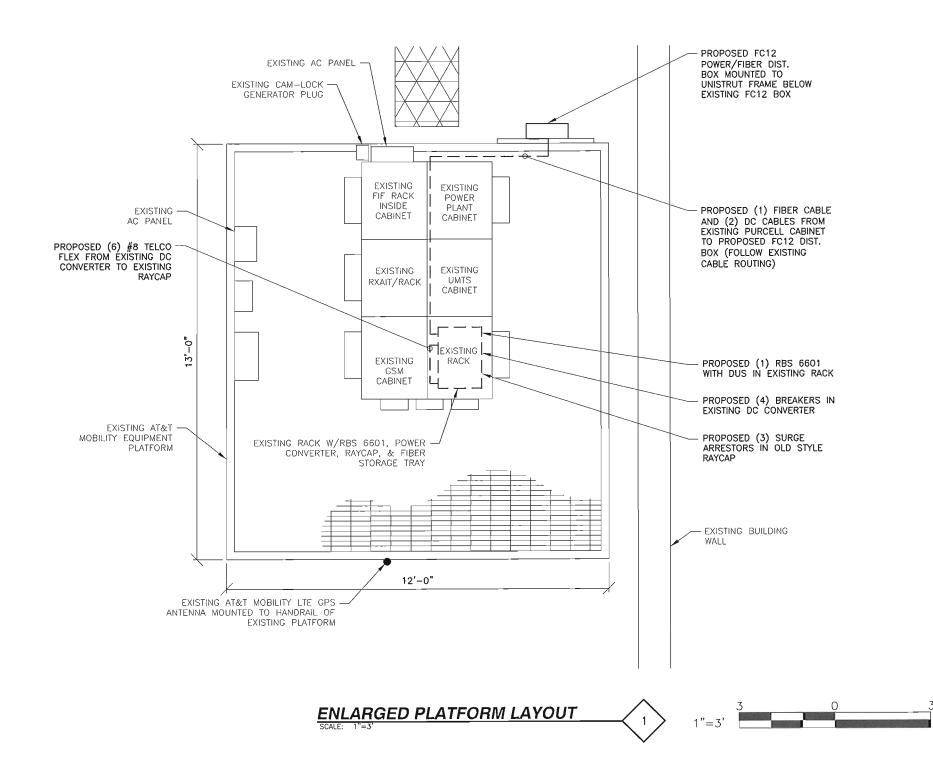
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CHARLOTTESVILLE, VA 22902

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# SITE PLAN

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DETAIL REFERENCE



SECTIONS AND DETAILS

CONCRETE


EARTH

GRAVEL/STONE

# SITE LEGEND

	PROPERTY LINE
_x x x x	FENCE LINE
PP	PDU POWER CABLE
———8т———	BIAS "T" CABLE
PA	PDU ALARM CABLE



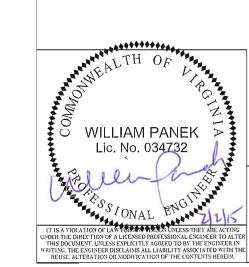



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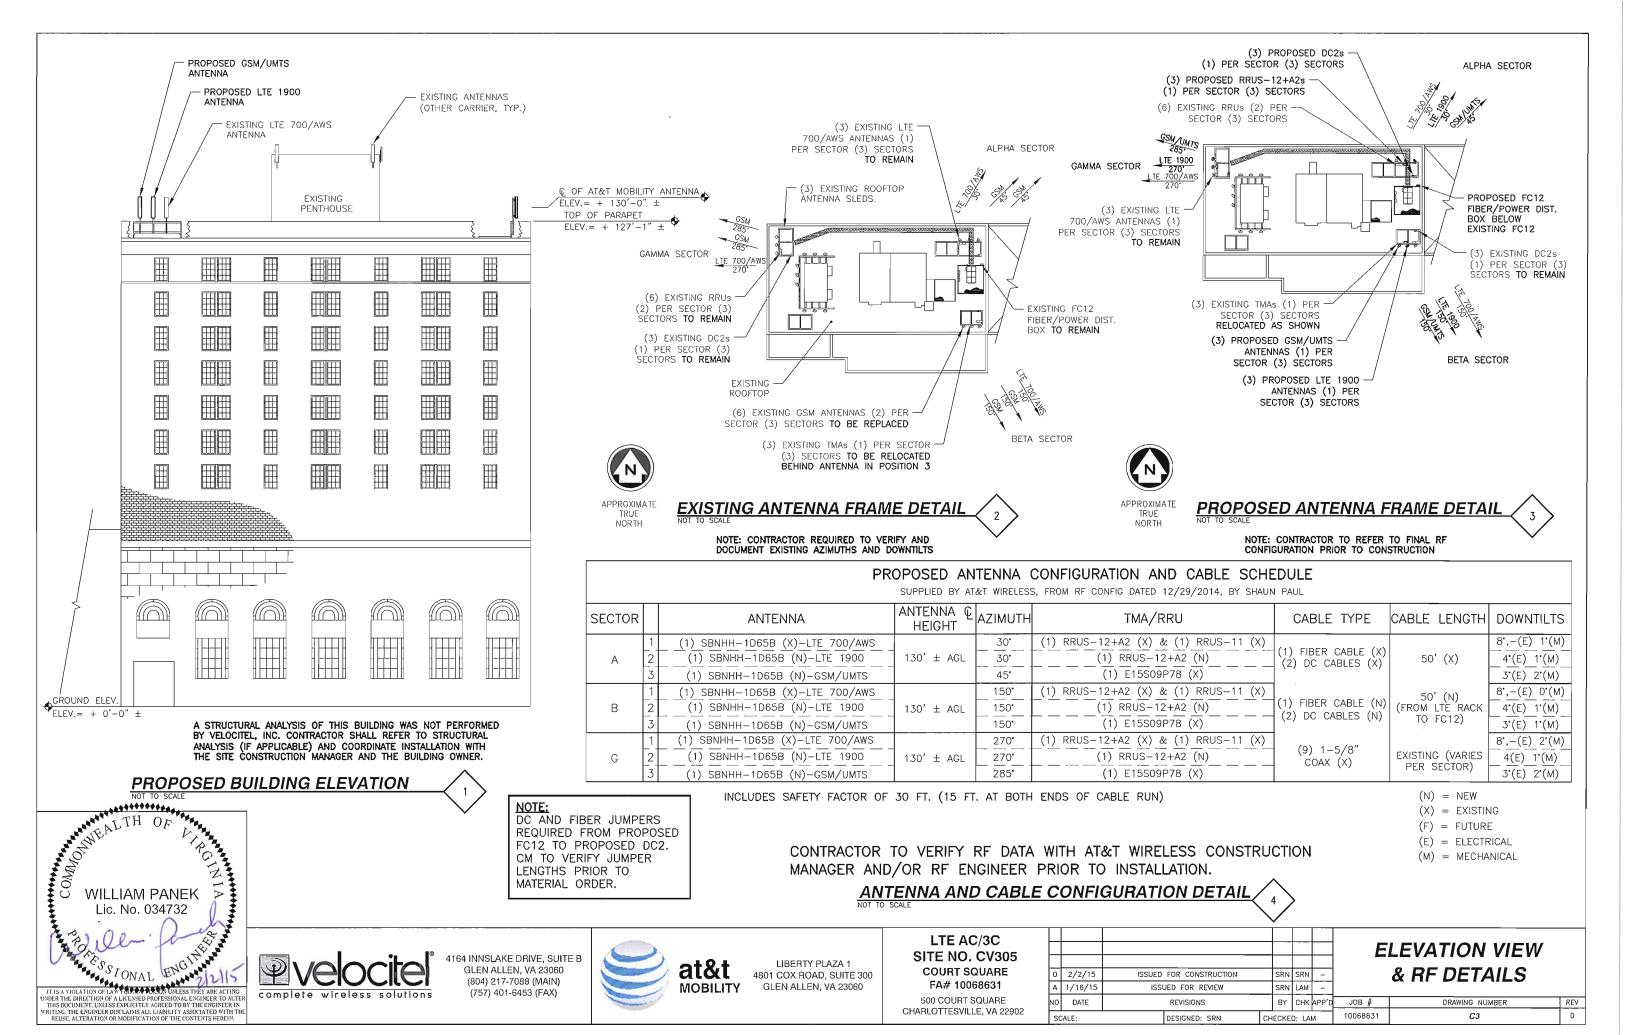
CHARLOTTESVILLE, VA 22902

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<b>ENLARGED</b>
PLATFORM LAYOUT


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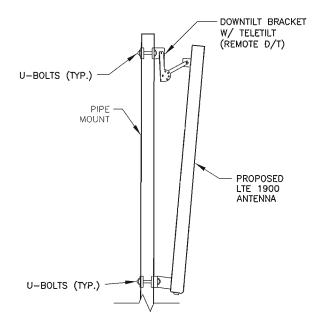
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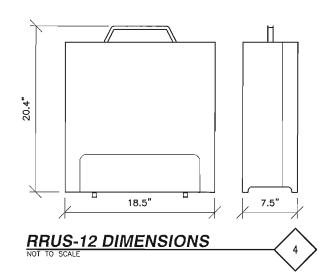
CAP UNUSED PORTS WITH 50 ohm LOADS







# LTE 1900 ANTENNA PIPE MOUNT

NOTE: CONTRACTOR TO VERIFY FINAL MOUNTING LOCATION AND METHODS W/ SITE CM PRIOR TO INSTALLATION.

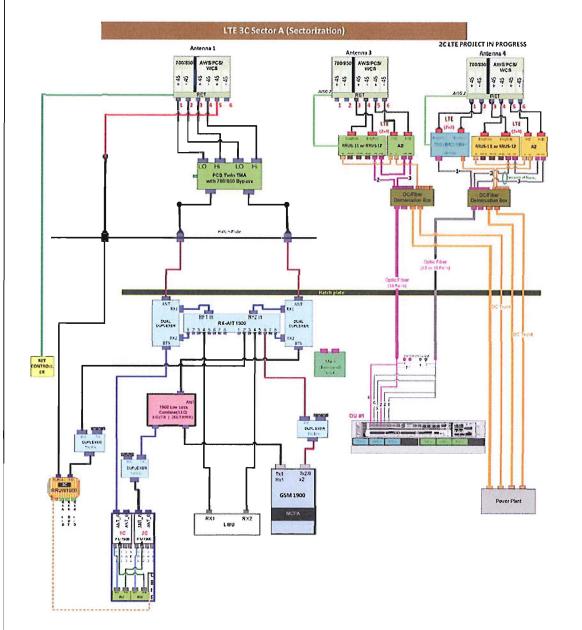

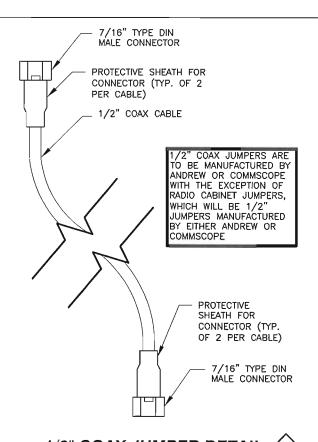



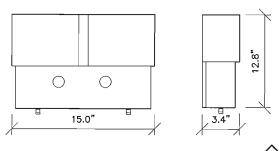


A2 MODULE DIMENSIONS

 $\left( 5\right)$ 

INSTALLATION SCHEMATIC

NOT TO SCALE

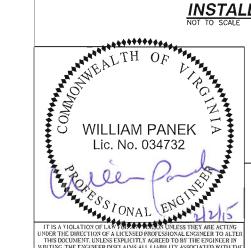

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SCALE:

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DESIGNED: SRN

ANTENNA/COAX
CABLE SCHEMATIC

#### **GENERAL NOTES**

#### 1. INSPECTIONS

- A. GENERAL: DURING AND UPON COMPLETION OF THE WORK, ARRANGE AND PAY ALL ASSOCIATED INSPECTIONS OF ALL ELECTRICAL WORK INSTALLED UNDER THIS CONTRACT IN ACCORDANCE WITH THE CONDITIONS OF THE CONTRACT. INSTALLATION SHALL COMPLY WITH APPLICABLE LAWS AND ORDINANCES, UTILITY COMPANY REQUIREMENTS, AND THE LATEST EDITION OF NEC, NFC, NEMA, OSHA, SBC, AND UL.
- B. INSPECTIONS REQUIRED: AS PER THE LAWS AND REGULATIONS OF THE LOCAL AND/OR STATE AGENCIES HAVING JURISDICTION AT THE PROJECT SITE.
- C. INSPECTION AGENCY: APPROVED BY THE LOCAL AND/OR STATE AGENCIES HAVING JURISDICTION AT THE PROJECT SITE.
- D. CERTIFICATES: SUBMIT ALL REQUIRED INSPECTION CERTIFICATES.

#### 2. HANGERS AND SUPPORTS

- A. MATERIALS: ALL HANGERS, SUPPORTS, FASTENERS AND HARDWARE SHALL BE STAINLESS STEEL OR OF EQUIVALENT CORROSION RESISTANCE BY TREATMENT OR INHERENT PROPERTY, AND SHALL BE MANUFACTURED PRODUCTS DESIGNED FOR THE APPLICATION. PRODUCTS FOR OUTDOOR USE
- B. TYPES: HANGERS, STRAPS, RISER SUPPORTS, CLAMPS, U-CHANNEL, THREADED RODS, ETC. AS
- INSTALLATION: RIGIDLY SUPPORT AND SECURE ALL MATERIALS, RACEWAY AND EQUIPMENT TO BUILDING STRUCTURE USING HANGERS, SUPPORTS AND FASTENERS SUITABLE FOR THE USE MATERIALS AND LOADS ENCOUNTERED. PROVIDE ALL NECESSARY HARDWARE. PROVIDE CONDUIT SUPPORTS AT MAXIMUM 5 FT. O.C.
- D: STRUCTURAL MEMBERS: DO NOT CUT, DRILL, OR WELD ANY STRUCTURAL MEMBER EXCEPT AS SPECIFICALLY APPROVED BY THE ENGINEER.
- E. MISCELLANEOUS SUPPORTS: PROVIDE ANY ADDITIONAL STRUCTURAL SUPPORT STEEL BRACKETS, ANGLES, FASTENERS AND HARDWARE AS REQUIRED TO ADEQUATELY SUPPORT ALL ELECTRICAL MATERIALS AND FOUIPMENT
- F. ONE HOLE STRAPS SHALL NOT BE USED FOR CONDUITS LARGER THAN 3/4 INCH.

#### 3. ENCLOSURES

A. NEMA 3R

4. HOLES, SLEEVES AND OPENINGS

GENERAL: PROVIDE ALL HOLES, SLEEVES, AND OPENINGS REQUIRED FOR THE COMPLETION OF WORK AND RESTORE ALL SURFACES DAMAGED TO MATCH SURROUNDING SURFACES.

#### CUTTING AND PATCHING

- A. GENERAL: PROVIDE ALL CUTTING, DRILLING, FITTING AND PATCHING NECESSARY FOR ACCOMPLISHING THE WORK. THIS INCLUDES ANY AND ALL WORK NECESSARY TO: UNCOVER WORK TO PROVIDE FOR THE INSTALLATION OF ILL TIMED WORK, REMOVE AND REPLACE DEFECTIVE WORK AND WORK NOT CONFORMING TO THE REQUIREMENTS OF THE CONTRACT DOCUMENTS.
- B. REPAIRS: REPAIR ANY AND ALL DAMAGE TO WORK OF OTHER TRADES CAUSED BY CUTTING AND PATCHING OPERATIONS, USING SKILLED MECHANICS OF THE TRADES INVOLVED.

#### RACEWAY SYSTEMS

A. ALL ABOVE GRADE CONDUIT AND ALL CONDUIT ELBOWS SHALL BE RIGID GALVANIZED STEEL UNLESS

#### CONDUCTORS

USE 98% CONDUCTIVITY COPPER WITH TYPE XHHW-2 INSULATION, 600 VOLT, COLOR CODED. USE SOLID CONDUCTORS FOR WIRE UP TO AND INCLUDING NO. 8 AWG, STRANDED CONDUCTORS FOR WIRE LARGER THAN NO. 8. USE PRESSURE-TYPE INSULATED TWIST-ON CONNECTORS FOR NO. 10 AWG AND SMALLER, SOLDERLESS MECHANICAL TERMINAL LUGS FOR NO. 8 AWG AND LARGER.

#### 8. GROUNDING SYSTEM

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WEALTH OF D.

WILLIAM PANEK Lic. No. 034732

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INSTALLATION: INSTALL AS REQUIRED SPECIFICATION. CONTRACTORS REPRESENTATIVE WILL INSPECT EXOTHERMIC WELDS AND CONDUCT MEGGER TEST PRIOR TO BURIAL. MAXIMUM 5 OHMS RESISTANCE IS REQUIRED, WHEN MORE THAT (4) ADDITIONAL GROUNDS ARE REQUIRED, VERIFY OHM LEVEL PRIOR TO CONSTRUCTION. USE CLEAN SAND AND CLAYBACKFILL FOR BURIED GROUND CONDUCTORS



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LTE AC/3C SITE NO. CV305 **COURT SQUARE** FA# 10068631

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#### 2/2/15 ISSUED FOR CONSTRUCTION SRN SRN -A 1/16/15 ISSUED FOR REVIEW SRN LAM -DATE REVISIONS BY CHK APP'D SCALE: DESIGNED: SRN CHECKED: LAM

# **GROUNDING & RF** NOTES

DRAWING NUMBER JOB # REV 10068631 E1 0


9. CHECKOUT, TESTING AND ADJUSTING


CORRECTION/REPLACEMENT: AFTER TESTING BY CONTRACTOR, OWNER OR ENGINEER, CORRECT ANY DEFICIENCIES AND REPLACE MATERIALS AND EQUIPMENT SHOWN TO BE DEFECTIVE OR UNABLE TO PERFORM AT DESIGN OR RATED CAPACITY


- POWER CONDUCTORS: CONTRACTOR SHALL CONDUCT A CONTINUITY & INSULATION TEST ON CONDUCTORS BETWEEN SERVICE DISCONNECT SWITCH & POWER CABINET.
- WHEN SITE POWER IS DERIVED FROM 3 PHASE SOURCE, LOAD READINGS WILL BE TAKEN AND RECORDED TO MAINTAIN A BALANCED LOAD AT THE PRIMARY SOURCE. RECORDS SHALL BE TURNED IN TO THE OWNER'S REPRESENTATIVE.

#### RF NOTES:


- 1. ACTUAL LENGTHS SHALL BE DETERMINED PER SITE CONDITION BY SUBCONTRACTOR,
- 2. THE DESIGN IS BASED ON RF DATA SHEETS, SIGNED AND APPROVED.
- 3. RADIO SIGNAL CABLE AND RACEWAY SHALL COMPLY WITH THE REQUIREMENTS OF THE NATIONAL ELECTRICAL CODE (NEC, NFPA 70), CHAPTER 8.
- 4. ALL SPECIFIED MATERIAL FOR EACH LOCATION (E.G. OUTDOORS-OCCUPIED, INDOORS-UNOCCUPIED, PLENUMS, RISER SHAFTS, ETC.) SHALL BE APPROVED, LISTED, OR LABELED AS REQUIRED BY THE NEC.
- 5. RADIO SIGNAL CABLE SHALL BE SUPPORTED AT MINIMUM OF EVERY THREE (3) FEET EXCEPT INSIDE MONOPOLES OR LATTICE TOWERS WHERE CABLE AND CONNECTOR MANUFACTURER'S SUPPORT RECOMMENDATIONS SHALL BE FOLLOWED. RF JUMPERS SHALL BE SUPPORTED AT A MAXIMUM OF TWO (2) FEET INTERVALS AND WITHIN 18" OF CONNECTORS. MANUFACTURER RECOMMENDED CABLE SUPPORT ACCESSORIES SHALL BE USED.
- 6. THE OUTDOOR CABLE SUPPORT SYSTEM SHALL BE PROVIDED WITH AN ICE SHIELD TO SUPPORT AND PROTECT ANTENNA CABLE RUNS.
- 7. DRIP LOOPS SHALL BE REQUIRED ON ALL OUTSIDE CABLES. CABLES SHALL BE SLOPED AWAY FROM BUILDING OR OUTDOOR BTS CABINETS TO PREVENT WATER FROM ENTERING THROUGH THE COAXIAL
- 8. ALL FEEDER LINE AND JUMPER CONNECTORS SHALL BE 7/16 DIN CABLE CONNECTORS THAT MEET
- 9. 7/16 DIN CONNECTORS REQUIRE NO ADDITIONAL WEATHER PROOFING IN INDOOR APPLICATIONS IF INSTALLED AND TORQUED PROPERLY. IN OUTDOOR APPLICATIONS, WEATHER PROOFING IS REQUIRED AND THE FOLLOWING PROCEDURE SHOULD BE FOLLOWED.
- 10. USING WEATHERPROOFING KIT APPROVED BY CABLE MANUFACTURER AND CONTRACTOR, START TAPE APPROXIMATELY 5 INCHES FROM THE CONNECTOR AND WRAP 2 INCHES TOWARD THE CONNECTOR, THEN REVERSE THE TAPE SO THAT THE STICKY SIDE IS UP. TAPE OVER THE CONNECTOR OR SURGE ARRESTOR UNTIL THREE (3) TO FOUR (4) INCHES BEYOND THE CONNECTOR AND REVERSE AGAIN WITH THE STICKY SIDE DOWN FOR ANOTHER INCH OR TWO. ADD THE BUTYL RUBBER AND FINISH WITH A FINAL LAYER OF TAPE.
- 11. ANTENNAS AND COAX SHALL BE PAINTED, WHEN REQUIRED, BY THE LANDLORD OR AUTHORITY HAVING JURISDICTION IN ACCORDANCE WITH ANTENNA MANUFACTURERS' SURFACES' PREPARATION AND PAINTING
- 12. CABLE SHIELDS, AND TOWER CONDUITS SHALL BE GROUNDED AT THE TOP OF THE TOWER, WITHIN 10 FEET OF THEIR CONNECTORS, AND AT THE BOTTOM OF THE TOWER ABOUT 6 INCHES BEFORE THEY TURN TOWARD THE FACILITY. THEY SHALL BE GROUNDED AT THE MIDPOINT OF THE TOWERS THAT ARE BETWEEN 100 FEET AND 200 FEET HIGH, AND AT INTERVALS OF 100 FEET OR LESS ON TOWERS THAT ARE HIGHER THAN 200 FEET.
- 13. APPROVED GROUNDING KITS, WHICH INCLUDE GROUNDING STRAPS, SHALL BE USED TO GROUND THE COAXIAL CABLE SHIELDS, AND CONDUITS. THE GROUND CONDUCTORS FOR THE KITS AT THE TOP OF THE TOWER, AND IN THE MIDDLE SECTION OF THE TOWER, ARE BONDED DIRECTLY TO GROUND BAR USING EXOTHERMIC OR COMPRESSION CONNECTIONS.
- 14. ALL RADIO SIGNAL CABLE SHALL BE LABELED PER MARKET REQUIREMENTS.
- 15. ANTENNA FEED LINE SYSTEM SWEEP TESTING SHALL BE PERFORMED AND REPORTED IN ACCORDANCE WITH CARRIER REQUIREMENTS. CONTRACTOR WILL NOT ACCEPT A RADIO SIGNAL CABLE INSTALLATION WITH UNSATISFACTORY SWEEP TEST RESULTS. THERE SHALL ALSO BE A HARD COPY OF SWEEPS LEFT AT SITE UPON COMPLETION OF SWEEP TEST.

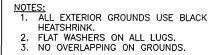

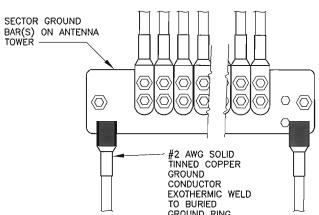

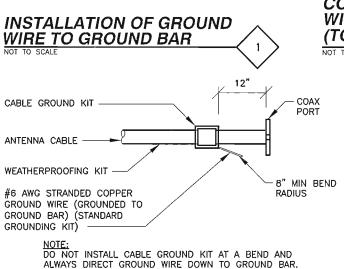

CONNECTION TO ANTENNA CABLE

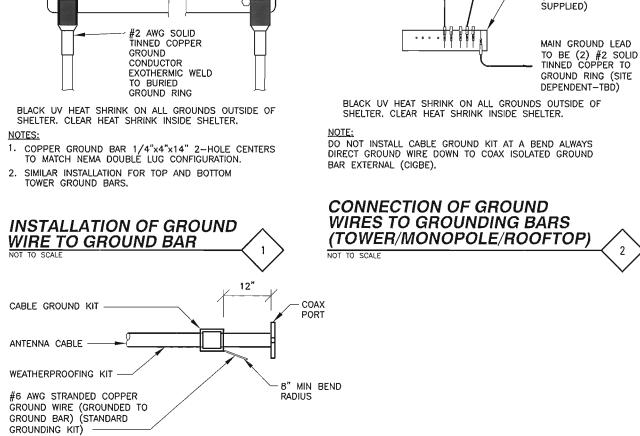

FROM ANTENNA

#6 AWG

STANDARD COPPER

JUMPER REQUIRED ONLY WHEN 7/8"ø

AND LARGER (TYP)

WEATHERPROOFING

STANDARD ANDREW

GROUND KIT (TYP.)

SEE NOTE BELOW.

ANTENNA CABLE


GROUND BAR


(CONTRACTOR

(TYP.)

KIT, ANDREW

#221213 (TYP)

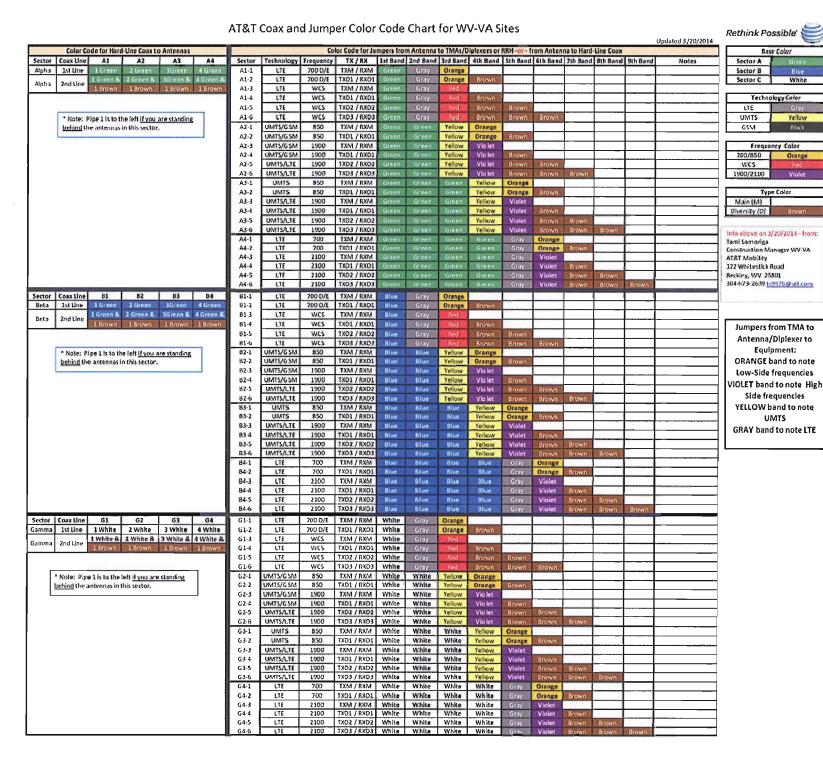

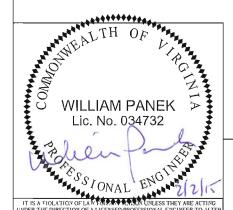

CABLE GROUND KIT

4164 INNSLAKE DRIVE, SUITE B GLEN ALLEN, VA 23060 (804) 217-7088 (MAIN) (757) 401-6453 (FAX)



LIBERTY PLAZA 1 4801 COX ROAD, SUITE 300 GLEN ALLEN, VA 23060

LTE AC/3C SITE NO. CV305 **COURT SQUARE** FA# 10068631

500 COURT SQUARE CHARLOTTESVILLE, VA 22902

SCALE:

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0	2/2/15	ISSUED FOR CONSTRUCTION	SRN	SRN	-	
A	1/16/15	ISSUED FOR REVIEW	SRN	LAM	-	
10	DATE	REVISIONS	BY	снк	APP'D	

DESIGNED: SRN

CHECKED: LAM

**COAX & JUMPER COLOR CODE CHART** 

GROUNDING DETAILS & COLOR CODE CHART

Yellow

DRAWING NUMBER REV 10068631 0 E2

at&t