

Board of Architectural Review (BAR) **Certificate of Appropriateness**

Please Return To: City of Charlottesville

Department of Neighborhood Development Services

P.O. Box 911, City Hall Charlottesville, Virginia 22902

Telephone (434) 970-3130 Fax (434) 970-3359

Please submit ten (10) copies of application form and all attachments.

For a new construction project, please include \$375 application fee. For all other projects requiring BAR approval, please include \$125 application fee. For projects that require only administrative approval, please include \$100 administrative fee. Make checks payable to the City of Charlottesville.
The BAR meets the third Tuesday of the month.

Deadline for submittals is Tuesday 3 weeks prior to next BAR meeting by 4 p.m.

	,
Owner Name PRIDE HOLDINGS LLC	Applicant Name ROGER L. BIRLE AIA
Project Name/Description Tower House	Parcel Number 53 011 7-00 6
Property Address 408 PARK STREET	CHARLOTTENILE, VA 22902
THE RESERVE OF THE PROPERTY OF	
Applicant Information Address: DC.P.ARCHITECTS ZOCST STINE CHARLDTESVILLE, VAZ Email: RRIRLE / DC.P.ARCHITECTS (A) Phone: (W) 434.777.44801) FAX: 434.790.8720	Signature of Applicant I hereby attest that the information I have provided is, to the best of my knowledge, correct. (Signature also denotes commitment to pay invoice for required mail notices.) Signature Date
Property Owner Information (if not applicant) Address: Po Box 1537 CHAPLOTIESVILLE VA 22907 Email: Phone: (W) 434.979.0342(H) FAX:	Print Name Date Property Owner Permission (if not applicant) I have read this application and hereby give my consent to its ubmission
Do you intend to apply for Federal or State Tax Credits for this project?	7/17/14 Signature Date
	WILLIAM PRITCHARD JR. 17 JUL 14 Print Name Date
Description of Proposed Work (attach separate narrate PRESERVATION) CERTIFICATE PROVIDED ON 15 JUL WITH BA	ive if necessary): PLEASE SEE "HISTORIC APPLICATION", PREVIOUSLY R SUBMITTAL:
List All Attachments (see reverse side for submittal re BLUL 14 - PERMIT PLANS SUB 5 JUL 14 - BAR SURMITTAL: 1	quiromonto).
11 0,04	

From: Scala, Mary Joy

Sent: Thursday, July 17, 2014 8:29 AM

To: Garett Rouzer (GRouzer@dgparchitects.com); Roger Birle (RBirle@dgparchitects.com)

Subject: BAR Actions July 15, 2014 - 408 Park Street

July 17, 2014

The above referenced project was discussed at a meeting of the Charlottesville Board of Architectural Review during "Matters from the public not on the agenda." The following action was taken:

Roger Birle from DGP Architects requested administrative approval for a tax credit project at 408 Park Street, including replacing the roof, replacing a door on the front second floor, replacing four pairs of windows on the south side, and adding new shutters. In addition, planned repairs included: window well, railings, front walk, and brick repointing. There was consensus that administrative approval would be appropriate.

You may now submit an application for administrative approval.


Mary Joy Scala, AICP


Preservation and Design Planner
City of Charlottesville
Department of Neighborhood Development Services
City Hall – 610 East Market Street
P.O. Box 911
Charlottesville, VA 22902
Ph 434.970.3130 FAX 434.970.3359
scala@charlottesville.org



Google earth


feet 300 meters 100

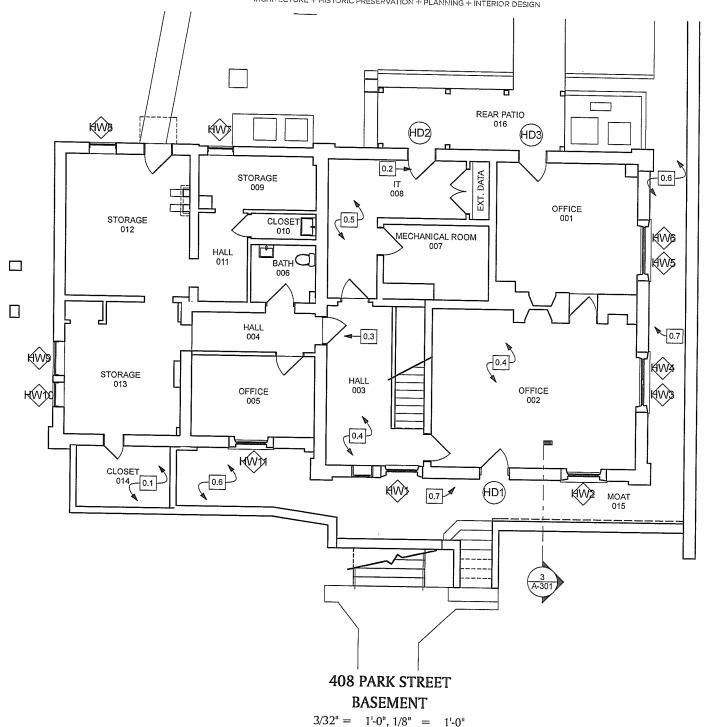

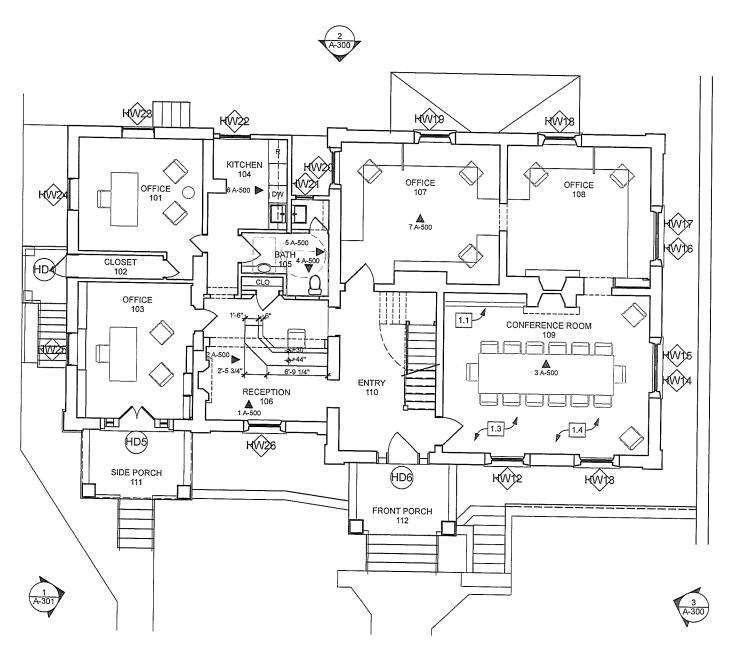


408 PARK STREET FIRST FLOOR

 $3/32^{\circ} = 1'-0'', 1/8'' = 1'-0''$

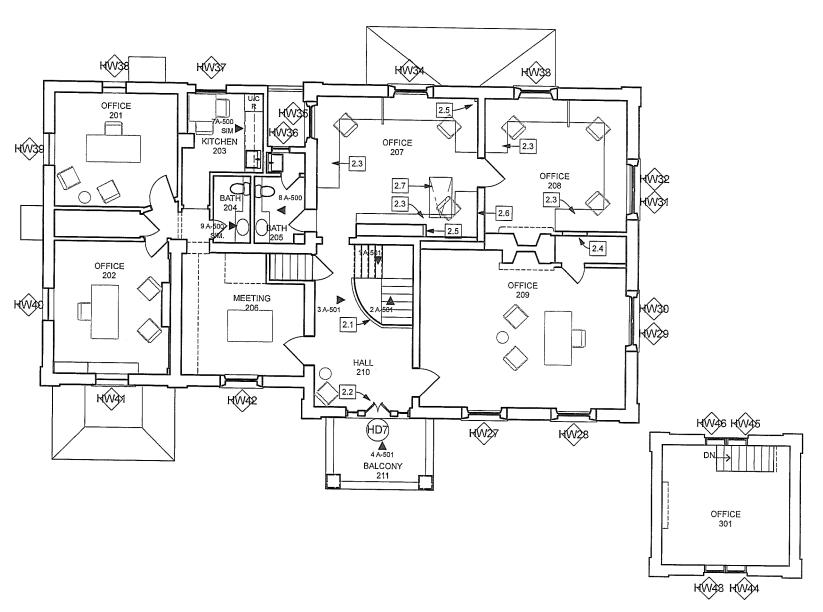

408 PARK STREET SECOND FLOOR & TOWER

3/32" = 1'-0"

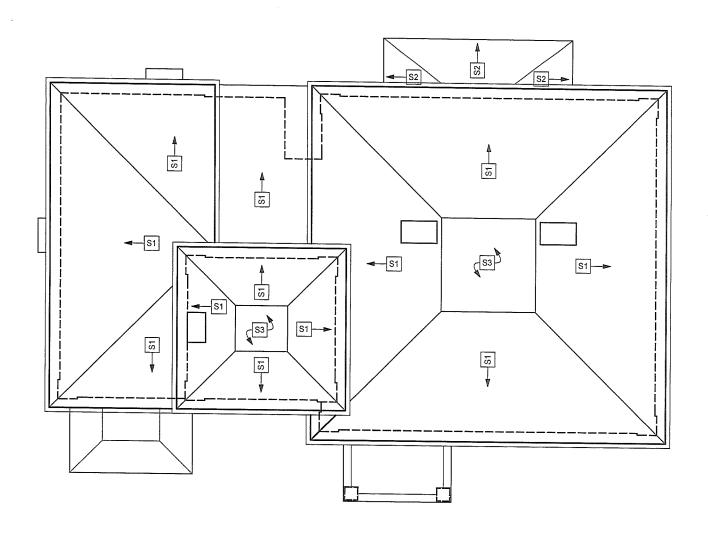

408 PARK STREET ROOF3/32" = 1'-0"





408 PARK STREET
WEST ELEVATION
NOT TO SCALE

ARCHITECTURE + HISTORIC PRESERVATION + PLANNING + INTERIOR DESIGN





SCHEMATIC EAST ELEVATION

SCHEMATIC SOUTH ELEVATION


408 PARK STREET
EAST & SOUTH ELEVATIONS
NOT TO SCALE



SCHEMATIC NORTH ELEVATION






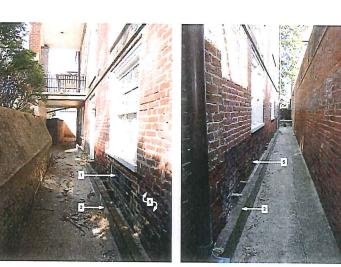


408 PARK STREET
NORTH & SOUTHWEST ELEVATIONS
NOT TO SCALE

ARCHITECTURE + HISTORIC PRESERVATION + PLANNING + INTERIOR DESIGN

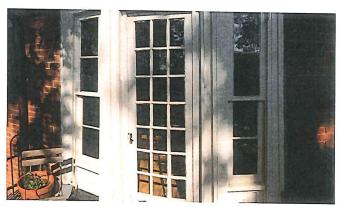

EXISTING

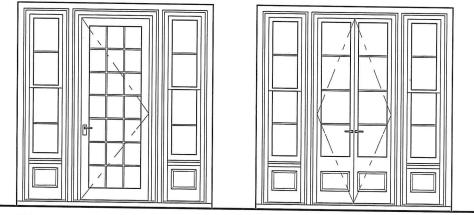

EXISTING

PROPOSED (HISTORIC)

408 PARK STREET BALCONY DOOR



408 PARK STREET

ROOF

NOT TO SCALE

COMMONWEALTH OF VIRGINIA DEPARTMENT OF HISTORIC RESOURCES

STATE HISTORIC REHABILITATION TAX CREDIT PROGRAM HISTORIC PRESERVATION CERTIFICATION APPLICATION PART 2 - DESCRIPTION OF REHABILITATION

DHR Project No.:

Instructions: Read the instructions carefully before completing application. No certification will be made unless a completed application form has been received. Type or print clearly in black ink. If additional space is needed, use continuation sheets or attach blank sheets. A copy of this form may be provided to the Virginia Department of Taxation. The decision by the Virginia Department of Historic Resources with respect to certification is made on the basis of the descriptions in this application form. In the event of any discrepancy between the application form and other, supplementary material submitted with it (such as architectural plans, drawings and specifications), the application form shall take precedence.

Address of property:	Street 408 Park Street			
· · · · · · · · · · · · · · · · · · ·	City Charlottesville	County	State <u>VA</u> Zij	2290
Listed individua	lly in the Virginia Landmarks Re	gister: give date of listing		
	stered Historic District: specify:		County Courthouse His	oric D
Has a Part 1 Application	on (Evaluation of Significance) b nitted:June 20 2014	een submitted for this project? Date of certific	? : yes	По
	if application for federal tax cred			
		as submitted)		
Data on building and	rehabilitation project:			
	ted: <u>1854-1861</u>	Total number of housing ur	nits before rehabilitation	: 0
	Brick Masonry	Number that are le	ow-moderate income: 0_	
	ation: Office	Total number of housing ur		
Froposed use(s) after re	ehabilitation: <u>Office</u> pilitation: <u>\$475,000</u>	Number that are l Floor area before rehabilita	low-moderate income: 0	
	phase number 1 of 1 phases	Floor area after rehabilitation		
	(est.): <u>August 2014</u>	Completion date (est.): Dec		
Project contact:				
Name Roger L. Birle, F	Principal, Dalgliesh Gilpin Paxtor	Architects		
Street 206 5 th St. NE	, , , ,	City Charlottesville		
State VA	Zip <u>22902</u>	Daytime Telephone N	umber <u>434-977-4480</u>	
•				
Owner:				0014
	d.Jr. Sig	gnature	Date 6-20	<i>)-2014</i>
Name William Pritchar Organization Pride Hol				
Name William Pritchar Organization Pride Ho Social Security or Taxp	Min - II O			

Property Address 408 Park St., Charlottesville, VA 22902 DHR Project Number:		
5. DETAILED DESCRIPTION OF REHABILITAT construction, alterations, etc. Complete below	TION/PRESERVATION WORK - Includes site work, new	
Number 1. Architectural feature Exterior Brick Walls Approximate date of feature 1854-1861, c. 1985 Describe existing feature and its condition: In some areas original brick has been poorly repointed with Portland cement. Some joints have deteriorated completely. East façade is not original. Brick is failing on South façade between 1st and 2nd floor windows. Rising damp is evident alongside "moat." Photo no. 01-A to 01-D Drawing no.	Describe work and impact on existing feature: Repointing only as necessary using lime mortar to match existing. Portland cement repointing to be cut out preserving existing brick. New hand moulded brick to match original in size, character, and color as needed at repairs. Original brick to be reused as feasible. No abrasive chemical or high-pressure water cleaning will be performed. Repointing to be in accordance with NPS Preservation Brief #2.	
Number 2. Architectural featureExterior Window Well "Moat" Approximate date of featureUnknown Describe existing feature and its condition: Existing concrete moat around West and South walls of building holds water against brick walls. Masonry vents that are not original have CMU or brick curbs that have failed. Water is settling below existing Basement floor system. Photo no. 02-A to 02-E Drawing no.	Describe work and impact on existing feature: Existing, not original, slab will be removed allowing foundation wall to be waterproofed below grade. New slab to be poured with greater pitch than existing. Basement floor system will be replaced and not require venting, thus no exterior curbed vents will be needed in moat.	
Number 3. Architectural feature Roof/gutters and downspouts Approximate date of feature c. 1985 Describe existing feature and its condition: Combination of composite asphalt shingles, standing seam metal, and EPDM rubber roofing is at end of its lifecycle. Copper gutters and downspouts are leaking and no longer properly attached. Photo no. 03-A to 03-D Drawing no.	Describe work and impact on existing feature: New roof and flashing to be hand-crimped standing seam steel in prefinished charcoal color. New gutters and downspouts to match existing to be copper. New EPDM at flat roof areas to be black in color.	
Number 4. Architectural feature Basement floor system Approximate date of feature Unknown Describe existing feature and its condition: Existing Basement has one area along West and South walls which has wood floor system and minimal crawl space below. This area floods and retains moisture. Current finish flooring is wall-to-wall carpet over painted narrow pine flooring. Photo no	Describe work and impact on existing feature: Existing wood floor system to be removed in these two rooms. Subsurface drainage channel to be created with gravel, piping and sump pump. New insulated and water-proofed concrete slab to be poured with new engineered pine flooring finish over top.	

DHR Form TC-2; Revised 8/02

Property Name "Tower House"

Property Name "Tower House"

Property Address 408 Park St., Charlottesville, VA 22902	DHR Project Number:
Number 5. Architectural feature HVAC System Approximate date of feature c. 1995 - 2005 Describe existing feature and its condition: Existing heating and cooling is with forced-air heat-pump system. Partial Basement is conditioned with electric split system through-wall units. Units are approaching end of lifecycle with older units using obsolete Freon.	Describe work and impact on existing feature: New units as needed with Basement units sized to sufficiently provide ducted air in spaces presently served with through-wall units, which will be removed. Brick repair at these areas is described in Feature #1.
Photo no. <u>05-A to 05-B</u> Drawing no	
Number 6. Architectural feature Electric/Data Systems Approximate date of feature c. 2000 Describe existing feature and its condition: Electric service and wiring has been updated and is sufficient. In some areas data and phone wiring is exposed and runs along interior surfaces in open bundles. Existing electric fixtures to remain.	Describe work and impact on existing feature: New data and phone to be brought to homerun locations in Basement and Attic. (2) 4" square drywall chases to be added in corners at Second Floor to conceal wiring. No original crown mould exists at these locations. Original baseboard will be removed in one location and reinstalled.
Photo no. 06-A to 06-C Drawing no.	
Number 7. Architectural feature Bathrooms Approximate date of feature c. 1995 Describe existing feature and its condition: Bathroom finishes and fixtures are outdated and failing. There is no handicap accessible bathroom presently.	Describe work and impact on existing feature: Bathroom finishes and fixtures to be replaced. One non-original interior partition wall to be moved on First Floor to allow for handicap accessible bathroom, which is required by Code.
Photo no. 07-A to 07-B Drawing no.	·
Number 8. Architectural feature Kitchenettes Approximate date of feature c. 1995 Describe existing feature and its condition: Kitchen and storage areas have outdated finishes, and fixtures.	Describe work and impact on existing feature: Kitchenette finishes and fixtures to be replaced. No interior walls or original features to be impacted.
Photo no. <u>08-A to 08-B</u> Drawing no.	

DHR Form TC-2; Revised 8/02 Page 3 of 7

Property Address 408 Park St., Charlottesville, VA 22902	DHR Project Number:
Number 9. Architectural feature Windows Approximate date of feature 1854-1861, c. 1985 Describe existing feature and its condition: Original windows are in various conditions. All are double hung single glazed. Windows on South façade have substantial rot with racked sashes. All original windows have interior double track storm units with plastic frames that are damaged. Several units have broken sash cords. Photo no. 09-A to 09-F Drawing no.	Describe work and impact on existing feature: On South façade four units to have sash replaced with insulated glass with clear low-e glass. Muntin profiles and configurations to match existing. Original windows to be restored according to NPS Preservation Brief #9 to allow for one operating unit per room. Storm windows to be replaced with low-profile enamel-coated steel units with one-over-one configuration.
Number 10. Architectural feature Exterior Porch Door Approximate date of feature Unknown, not original Describe existing feature and its condition: Frame and sidelights are original, but center door has been replaced mid-20 th Century. Thickened mullions are not original, but allow for existing standard door size.	Describe work and impact on existing feature: Replace door with pair of single glazed French doors that fit in original door opening. Muntins to align with original sidelights. Custom door to be of mahogany for paint with brass interlocking threshold. Exterior mahogany storm/screen panels to be single light.
Photo no. 10-A to 10-C Drawing no.	
Number 11. Architectural feature Second Floor Interior Guardrail Approximate date of feature Unknown, not original Describe existing feature and its condition: Second Floor stair balustrade turns into guardrail that has been extended with painted plywood panels. The original pickets have been removed, but the original handrail is still in place.	Describe work and impact on existing feature: Second Floor guard rail will match existing stair balustrade in design and material.
Photo no. 11-A to 11-E Drawing no.	
Number 12. Architectural feature Original Wood Interior Flooring Approximate date of feature 1854-1861 Describe existing feature and its condition: Existing floor on main levels is various widths of heart pine.	Describe work and impact on existing feature: Existing flooring to be cleaned and buffed, with no sanding required.
Photo no <u>12-A to 12-C_</u> Drawing no	

DHR Form TC-2; Revised 8/02

Property Name "Tower House"

Property Name "Tower House"	
Property Address 408 Park St., Charlottesville, VA 22902	
	DHR Project Number:

Number 13. Architectural feature Interior Plaster Approximate date of feature 1854-1861, c. 1995 Describe existing feature and its condition: Interior wall finishes are combination of original lime plaster, gypsum, and wall board. Hemosote panels were added at the end of the 20 th Century.	Describe work and impact on existing feature: Hemosote panels will be removed. Original plaster to be repaired using lime plaster. Gypsum and wall board to be repaired using gypsum wall compound. Original plaster has been tested and there is no asbestos present.
Photo no. 13-A to 13-D Drawing no.	
Number 14. Architectural feature Door Hardware Approximate date of feature c. 1995 Describe existing feature and its condition: Existing door hardware is a mix of mid-20 th Century replacements that do not match. No original hardware is present.	Describe work and impact on existing feature: All door hardware to be replaced with solid brass cylindrical passage sets.
Photo no. 14-A to 14-B Drawing no.	
Number 15. Architectural feature Exterior Metal Railing Approximate date of feature Unknown, not original Describe existing feature and its condition: Existing painted metal rails on West porches have rusted through at connection to concrete.	Describe work and impact on existing feature: New steel railing for paint will match existing in style and color, but be code compliant with regard to picket spacing.
Photo no. 15-A to 15-B Drawing no.	
Number 16. Architectural feature Front Walk Approximate date of feature Unknown, not original Describe existing feature and its condition: Existing soapstone and bluestone rustic walk is uneven and presents hazard to visitors.	Describe work and impact on existing feature: Existing stones will be reused as possible. Stone will be re-laid in sand-set bed with matching stone supplemented as needed.
Photo no. <u>16-A to 16-C</u> Drawing no. ———————————————————————————————————	

DHR Form TC-2; Revised 8/02

Property Address 408 Park St., Charlottesville, VA 22902 DHR Project Number:____ Number 17. Describe work and impact on existing feature: Architectural feature Fireplaces Existing built-ins will be removed from face of breast fronts. Approximate date of feature 1854-1861 New mantels will be added where original removed. Two Describe existing feature and its condition: fireplace lines will be opened and lined to provide gas log Existing fireplaces are all not in working condition. Several operation. have been boarded over and mantels removed. Photo no. 17-A to 17-F Drawing no. Number 18. Describe work and impact on existing feature: Architectural feature Exterior Basement Door Sill at "moat" to be replaced with stone sill and brass Approximate date of feature Unknown Approximate date of teature Unknown

Describe existing feature and its condition: interlocking threshold. Existing "moat" condition has led to rot at sill and jamb of West Basement access door. Photo no. <u>18-A to 18-C</u> Drawing no. _____ Number 19. Describe work and impact on existing feature: Architectural feature Shutters New shutters and operable hardware will be added to work with Approximate date of feature Not extant existing pintels as feasible. Shutters to be of mahogany with Describe existing feature and its condition: copper cap on edges. Though hardware (or mortise for such) is present at all windows, no shutters are existing. Photo no. 19-A Drawing no. Number 20. Describe work and impact on existing feature: Architectural feature Insulation in Attic Because existing hipped roofs are unvented, units and ducts are Approximate date of feature c. 1985 in attic apace, and for increased energy efficiency we will replace Describe existing feature and its condition: existing insulation with spray foam insulation at rafter bays. Existing insulation is blown cellulose between ceiling joists. Thickness and condition of existing insulation is inadequate. Photo no. 20-A to 20-B Drawing no.

DHR Form TC-2; Revised 8/02

Property Name "Tower House"

CONTINUATION/AMENDMENT SHEET

Historic Preservation Certification Application

Property A	ddress 408 Park St., Char	lottesville VA 22002		
Troperty A	runess 400 raik St., Chai	iottesvine, VA 22902		
Instructions of the Part 1	Read the instructions care and Part 2 application, or to	efully before completing. Typo amend an application alread	e, or print clearly in black in submitted. Photocopy add	nk. Use this sheet to continue secti
This sheet:	☐ continues Part 1	☐ continues Part 2	☐ amends Part 2	DHR Project Number:
		•		
Name		Signature		Date
Street			City	
State		Zip	Daytime Telephone Nu	mber

DHR Form TC-2; Revised 8/02

HISTORIC PRESERVATION CERTIFICATION APPLICATION PART 2 - PHOTOGRAPHS

Property	y Name: Tower House	
TIODCIL	y maine. Tower riouse	

Property Address: 408 Park Street, Charlottesville, VA

DHR Project Number:



Architectural Feature: Exterior Brick Walls



IMAGE 01-A



IMAGE 01-B



IMAGE 01-C



IMAGE 01-D

Number 2. Architectural Feature: Exterior Window Well "Moat"



IMAGE 02-A

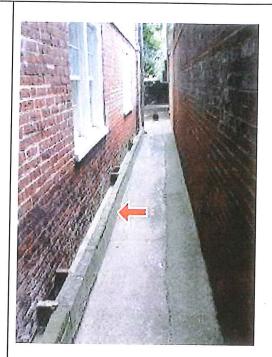


IMAGE 02-D





IMAGE 02-C

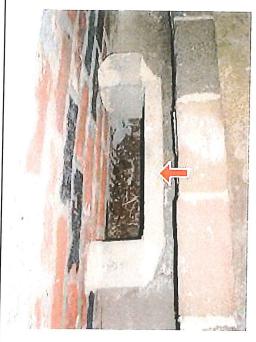


IMAGE 02-E

Number 3. Architectural Feature: Roof, Gutters and Downspouts



IMAGE 03-A



IMAGE 03-B



IMAGE 03-C



IMAGE 03-D

Number 4.

Architectural Feature: Basement Floor System

No Images.

Number 5. Architectural Feature: HVAC System



IMAGE 05-A



IMAGE 05-B

Number 6. Architectural Feature: Electric / Data Systems



IMAGE 06-A



IMAGE 06-C



IMAGE 06-B

Number 7.
Architectural Feature: Bathrooms



IMAGE 07-A



IMAGE 07-B

Number 8. Architectural Feature: Kitchenettes



IMAGE 08-A



IMAGE 08-B

Number 9. Architectural Feature: Windows



IMAGE 09-A



IMAGE 09-B

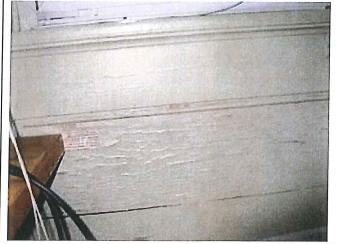


IMAGE 09-C



IMAGE 09-D



IMAGE 09-E



IMAGE 09-F

Number 10. Architectural Feature: Exterior Porch Door

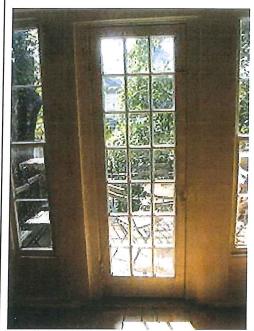


IMAGE 10-A





IMAGE 10-C

Number 11. Architectural Feature: Second Floor Interior Guardrail



IMAGE 11-A

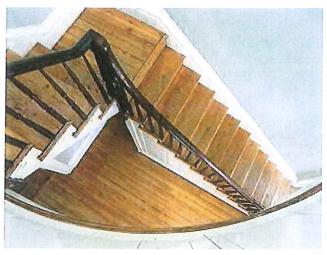


IMAGE 11-D



IMAGE 11-B



IMAGE 11-E



IMAGE 11-C

Number 12. Architectural Feature: Original Wood Interior Flooring



IMAGE 12-A



IMAGE 12-B

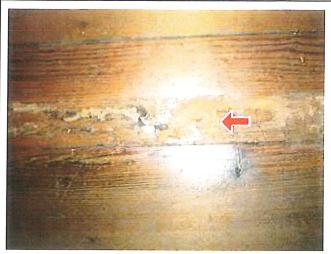


IMAGE 12-C

Number 13. Architectural Feature: Interior Plaster

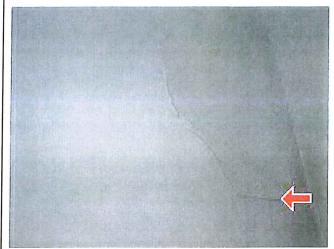


IMAGE 13-A

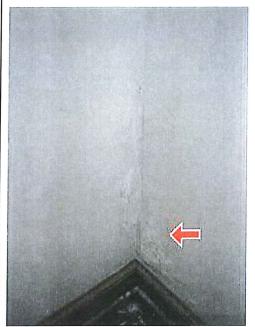


IMAGE 13-B

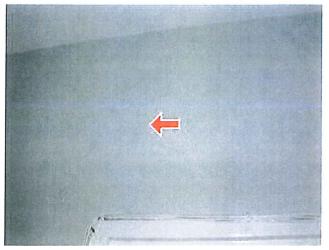


IMAGE 13-C

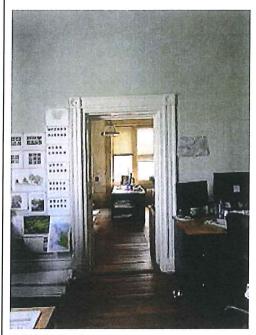


IMAGE 13-D

Number 14. Architectural Feature: Door Hardware

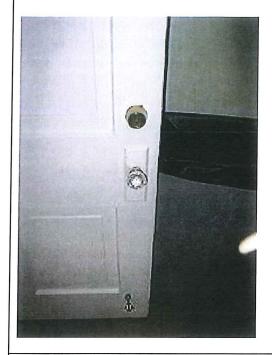




IMAGE 14-A

IMAGE 14-B

Number 15. Architectural Feature: Exterior Metal Railing



IMAGE 15-A



IMAGE 15-B

Number 16. Architectural Feature: Front Walk IMAGE 16-A

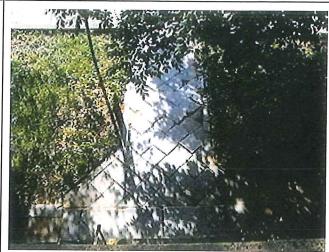


IMAGE 16-C

DHR Form TC-2; Revised 8/02 Page 12 of 15

IMAGE 16-B

Number 17. Architectural Feature: Fireplaces



IMAGE 17-A

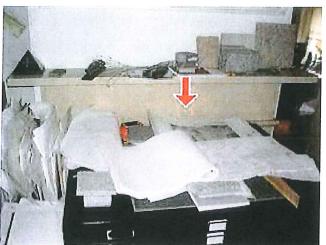


IMAGE 17-B

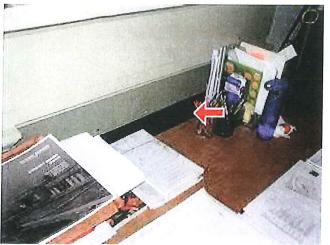


IMAGE 17-C



IMAGE 17-D



IMAGE 17-E

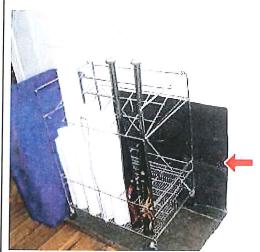


IMAGE 17-F

Number 18.
Architectural Feature: Exterior Basement Door



IMAGE 18-A



IMAGE 18-C



IMAGE 18-B

DHR Form TC-2; Revised 8/02 Page 14 of 15

Number 19. Architectural Feature: Shutters




IMAGE 19-A

Number 20. Architectural Feature: Insulation in Attic





IMAGE 20-B

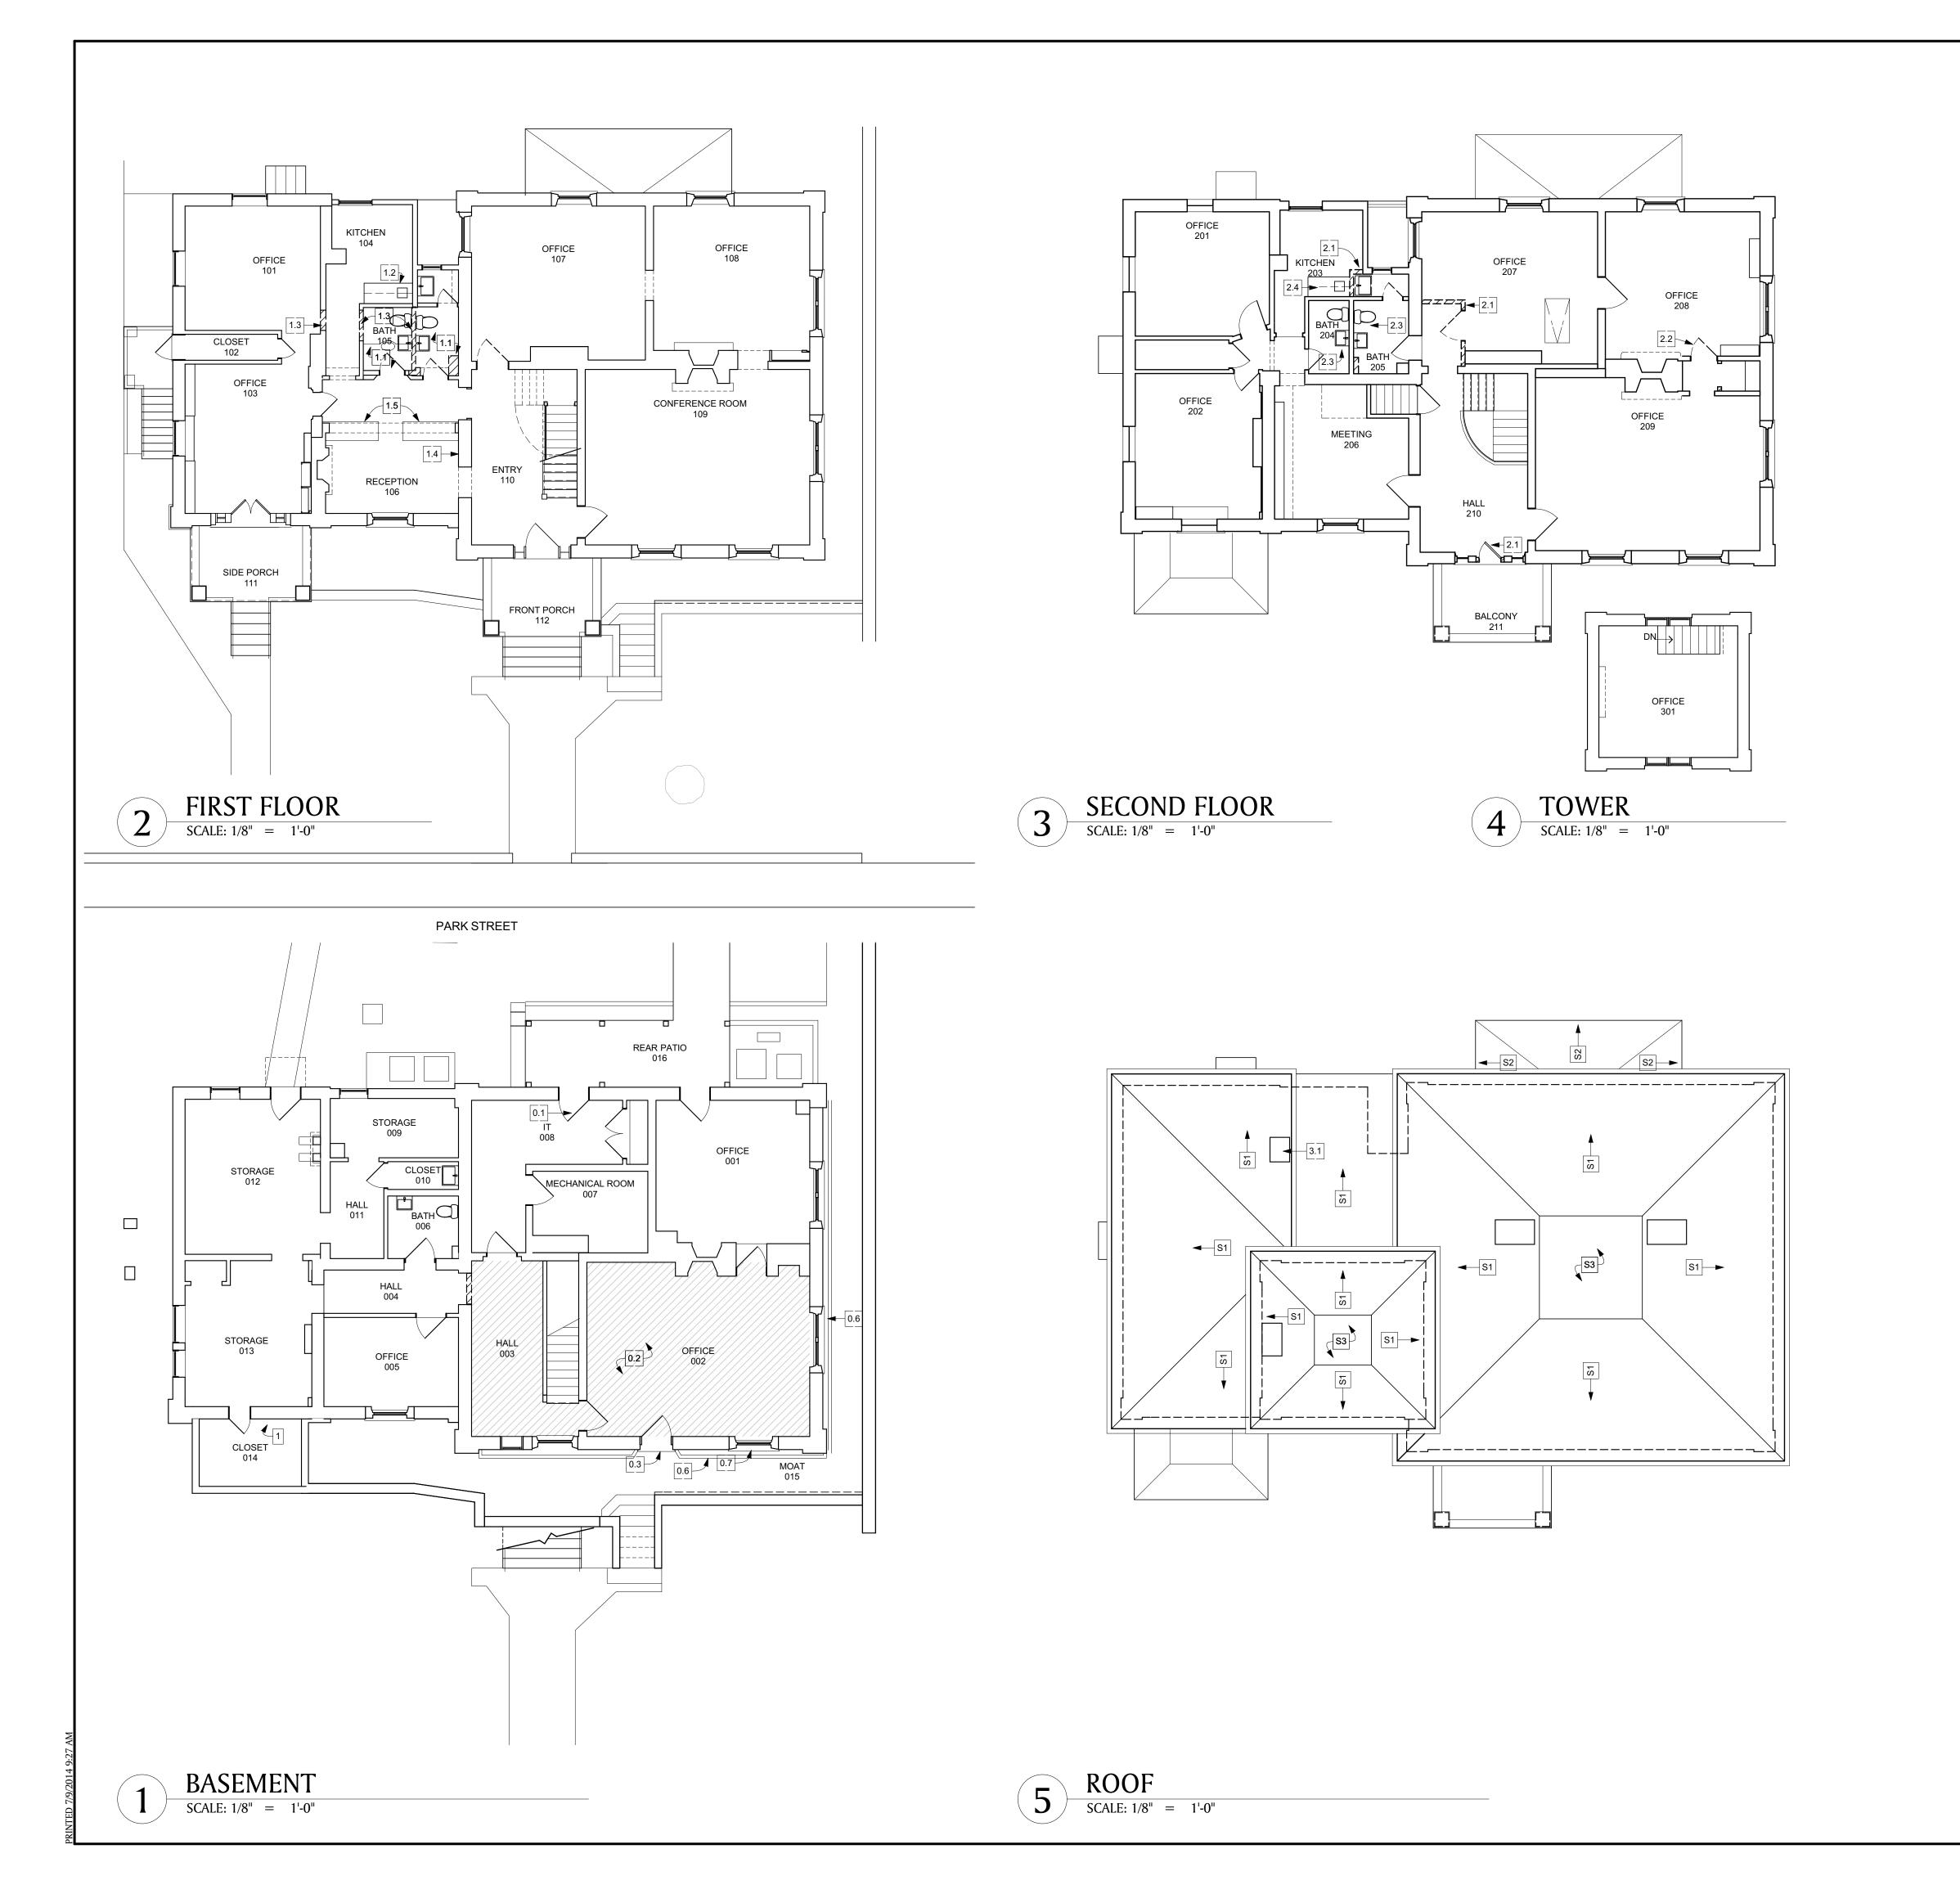

PROJECT DATA APPLICABLE CODES: - VIRGINIA UNIFORM STATEWIDE BUILDING CODE 2009 [VUSBC] - INTERNATIONAL EXISTING BUILDING CODE 2009 [IEBC] CONSTRUCTION TYPE: IIIB OCCUPANCY TYPE: B - BUSINESS FIRE PROTECTION - AUTOMATIC SPRINKLER PROTECTION: NO - FIRE ALARM: YES - SPECIAL SUPPRESSION SYSTEMS: NO NUMBER OF STORIES (INCLUDING BASEMENT): 4 SQUARE FOOTAGE (sf): - BASEMENT.... - FIRST FLOOR... - SECOND FLOOR..... - TOWER..... A-100 | SELECTIVE REMOVALS FLOOR PLANS A-200 | FLOOR PLANS A-300 | ELEVATIONS A-301 | ELEVATIONS & WALL SECTION A-500 | INTERIOR ELEVATIONS & FINISH SCHEDULE A-501 | INTERIOR ELEVATIONS E-200 | POWER & DATA PLANS

408 PARK STREET - PROJECT INFORMATION

408 PARK STREET - SELECTIVE REMOVAL NOTES

NEW CONSTRUCTION

EXISTING TO BE REMOVED

EXISTING TO REMAIN

GENERAL

1. REMOVE ALL HOMASOTE PANELS
2. REMOVE ALL ACP CEILINGS, VINYL BASE, AND WALLPAPER; U.N.O.

GROUND FLOOR

- 0.1 REMOVE AND SALVAGE DOOR PANEL
- 0.2 REMOVE WOOD FLOOR SYSTEM AT HATCHED AREA
- 0.3 REMOVE AND DISCARD DOOR
- 0.4 NOT USED
- 0.5 REMOVE AND DISCARD CARPET
- 0.6 REMOVE RILL ALONG MOAT
- 0.7 REMOVE AND DISCARD EXISTING THROUGH-WALL HVAC SYSTEM

FIRST FLOO

- 1.1 REMOVE AND DISCARD ALL PLUMBING FIXTURES AND CABINETS
- 1.2 REMOVE AND DISCARD ALL KITCHENETTE FIXTURES AND CABINETS
- 1.3 REMOVE AND DISCARD EXISTING WALLS AND DOOR
- REMOVE FINISHES TO EXPOSE EXISTING EXTERIOR BRICK WALL ON NORTH ELEVATION ONLY
- REMOVE AND SALVAGE SOAPSTONE COUNTERTOPS, TO BE REINSTALLED IN BATHS 204 & 205
- SECOND FLOOR
- 2.1 REMOVE AND DISCARD EXISTING WALLS AND DOOR
- **▼**2.2 REMOVE AND SALVAGE DOOR AND CASING
- 2.3 REMOVE AND DISCARD ALL PLUMBING FIXTURES AND CABINETS
- 2.3 REMOVE AND DISCARD ALL PLUMBING FIXTURES AND CABINETS

 2.4 REMOVE AND DISCARD ALL KITCHENETTE FIXTURES AND CABINETS

ATTIC / ROO

1. REMOVE AND DISCARD EXISTING ROOFING; SEE A-200

3.1 REMOVE AND DISCARD CHIMNEY BELOW ROOF LINE.



Approved:

Dalgliesh Gilpin Paxton

Architects

206 5th Street N.E.
P.O. Box 2555
Charlottesville Virginia, 22902
tel: 434·977·4480
fax: 434·296·8720
info@dgparchitects.com

CHARLOTTESVILLE, VIRGINIA

Job # Date
4381 8 JUL 14

Drawn Checked


ACS / GMR RLB

CONTRACTOR TO VERIFY ALL DIMENSIONS AT SITE AND SHALL NOTIFY ARCHITECT OF ANY DISCREPANCIES BEFORE PROCEEDING

	Revisions		
#	Date	Ву	

Sheet
A-100

PERMIT SET

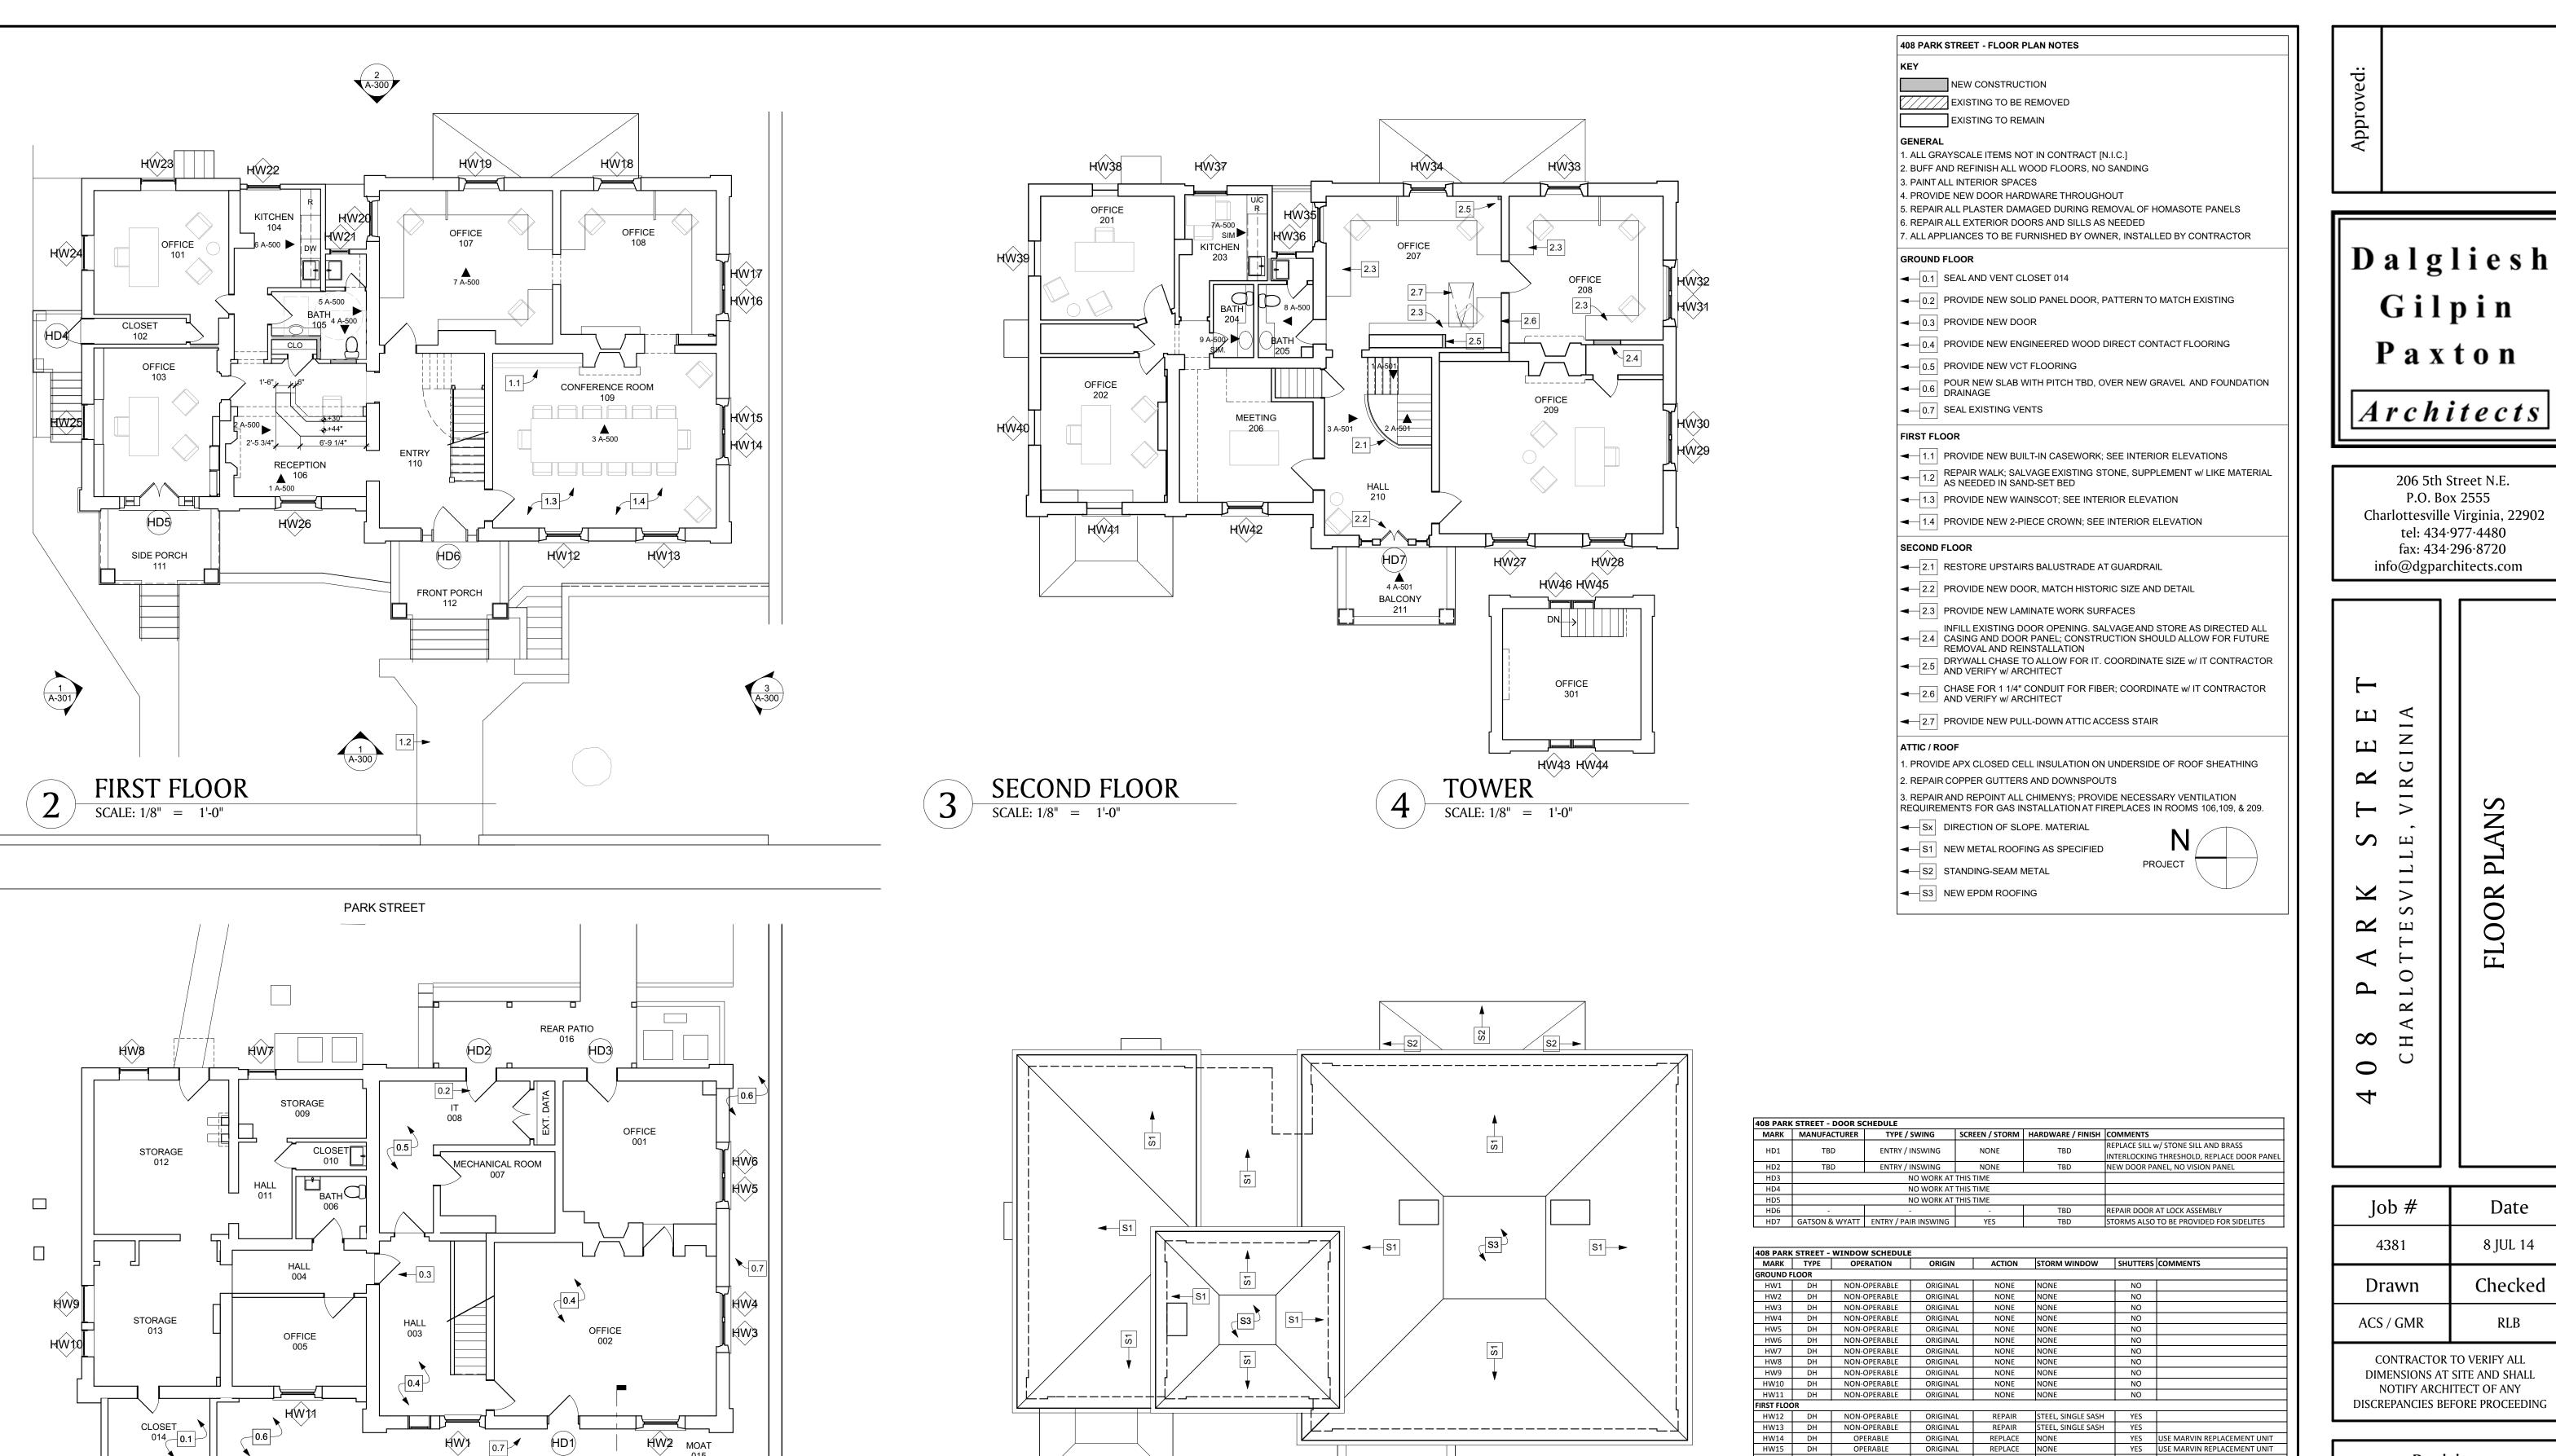

BASEMENT

 ∞ Job # Date 4381 8 JUL 14 Checked Drawn ACS / GMR RLB CONTRACTOR TO VERIFY ALL DIMENSIONS AT SITE AND SHALL NOTIFY ARCHITECT OF ANY DISCREPANCIES BEFORE PROCEEDING Revisions Date HW22 DH OPERABLE REPLACEMENT REPLACE NONE NO
HW23 DH NON-OPERABLE ORIGINAL REPAIR STEEL, SINGLE SASH NO
HW24 DH OPERABLE ORIGINAL RESTORE STEEL, SINGLE SASH NO
HW25 DH OPERABLE ORIGINAL RESTORE STEEL, SINGLE SASH NO
HW26 DH NON-OPERABLE ORIGINAL RESTORE STEEL, SINGLE SASH NO
HW26 DH NON-OPERABLE ORIGINAL REPAIR STEEL, SINGLE SASH YES PROVIDE LOWER INTERIOR PANEL Sheet A-200

YES USE MARVIN REPLACEMENT UNIT

NO USE MARVIN REPLACEMENT UNIT

YES USE MARVIN REPLACEMENT UNIT
YES USE MARVIN REPLACEMENT UNIT

OPERABLE ORIGINAL REPLACE NONE

DH OPERABLE REPLACEMENT REPLACE NONE

DH NON-OPERABLE ORIGINAL REPAIR STEEL, SINGLE SASH

DH OPERABLE REPLACEMENT REPLACE NONE

HW29DHOPERABLEORIGINALREPLACENONEYESHW30DHOPERABLEORIGINALREPLACENONEYESHW31DHOPERABLEORIGINALREPLACENONEYESHW32DHOPERABLEORIGINALREPLACENONEYESHW33DHNON-OPERABLEORIGINALREPAIRSTEEL, SINGLE SASHNOHW34DHNON-OPERABLEORIGINALREPAIRSTEEL, SINGLE SASHNOHW35DHOPERABLEORIGINALRESTORESTEEL, SINGLE SASHNOHW36DHOPERABLEORIGINALRESTORESTEEL, SINGLE SASHNOHW37DHOPERABLEORIGINALRESTORESTEEL, SINGLE SASHNOHW38DHOPERABLEORIGINALRESTORESTEEL, SINGLE SASHNOHW39DHNON-OPERABLEORIGINALREPAIRSTEEL, SINGLE SASHNOHW40DHNON-OPERABLEORIGINALREPAIRSTEEL, SINGLE SASHNOHW41DHOPERABLEORIGINALRESTORESTEEL, SINGLE SASHYESHW42DHOPERABLEORIGINALRESTORESTEEL, SINGLE SASHYESTOWER

 HW43
 DH
 NON-OPERABLE
 ORIGINAL
 REPAIR
 STEEL, SINGLE SASH
 NO

 HW44
 DH
 NON-OPERABLE
 ORIGINAL
 REPAIR
 STEEL, SINGLE SASH
 NO

 HW45
 DH
 NON-OPERABLE
 ORIGINAL
 REPAIR
 STEEL, SINGLE SASH
 NO

 HW46
 DH
 OPERABLE
 ORIGINAL
 RESTORE
 STEEL, SINGLE SASH
 NO

DH OPERABLE ORIGINAL

NON-OPERABLE ORIGINAL REPAIR STEEL, SINGLE SASH YES
NON-OPERABLE ORIGINAL REPAIR STEEL, SINGLE SASH YES

REPLACE NONE

By

Gilpin

Paxton

Architects

206 5th Street N.E. P.O. Box 2555

Charlottesville Virginia, 22902

tel: 434·977·4480

fax: 434·296·8720

info@dgparchitects.com

1. PAINT TRIM AND ALL WINDOWS AND DOORS
2. CONSULT WITH MASON AND EVALUATE ENTIRE BUILDING FOR BRICK REPOINTING AND REPAIR. FOLLOW PRESERVATION BRIEF #2: "REPOINTING MORTAR JOINTS IN HISTORIC MASONRY BUILDINGS."

3. PROVIDE NEWCOMPOSITE SHUTTERS BY TIMBERLANE AND OPERABLE HARDWARE; COORDINATE AND REUSE EXISTING PINTELS WHERE POSSIBLE SUPPLEMENT WITH MATCHING HARDWARE

- REMOVE AND DISCARD THROUGH-WALL UNIT, REPAIR WITH BRICK TO MATCH EXISTING
- → 2 REMOVE CURB AND SEAL EXISTING VENTS
- 3 CLEAN AND REPAIR BRICK AS SPECIFIED
- 4 PROVIDE NEW METAL RAILINGS
- 5 AREA OF BRICK RESTORATION





SCHEMATIC WEST ELEVATION SCALE: 1/4'' = 1'-0''





3 SCHEMATIC SOUTH ELEVATION

SCALE: 1/4" = 1'-0"

Dalgliesh Gilpin Paxton

Architects


206 5th Street N.E. P.O. Box 2555 Charlottesville Virginia, 22902 tel: 434·977·4480 fax: 434·296·8720 info@dgparchitects.com

 ∞ \pm 0


Job# Date 8 JUL 14 4381 Checked Drawn ACS / GMR

CONTRACTOR TO VERIFY ALL DIMENSIONS AT SITE AND SHALL NOTIFY ARCHITECT OF ANY DISCREPANCIES BEFORE PROCEEDING

Revisions			
#	Date	Ву	

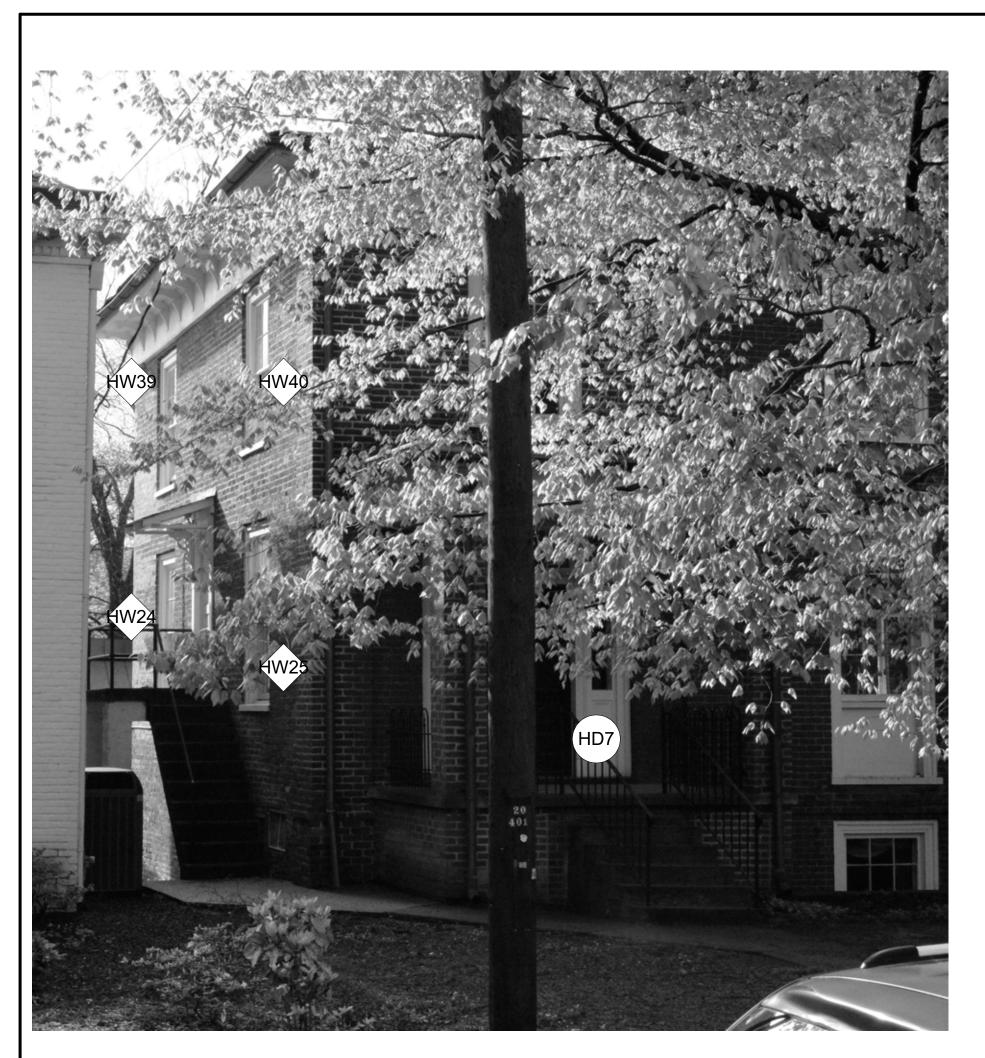


SCHEMATIC NORTH ELEVATION SCALE: 1/4" = 1'-0"

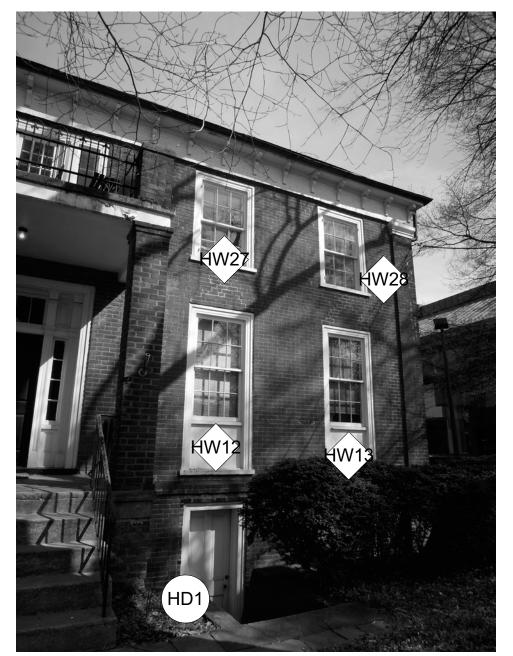









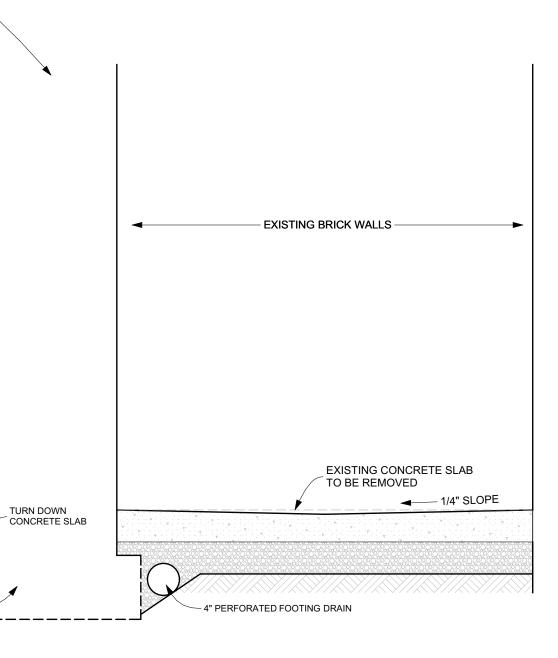

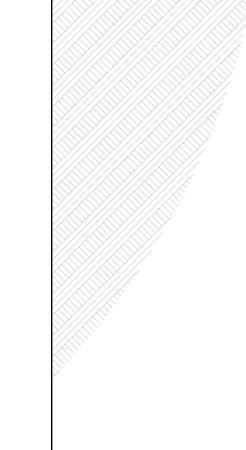

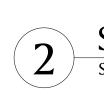

SCHEMATIC SOUTHWEST ELEVATION

SCALE: 1/4" = 1'-0"

SUBSURFACE DRAINAGE CHANNEL

408 PARK STREET - ELEVATION NOTES

1. PAINT TRIM AND ALL WINDOWS AND DOORS
2. CONSULT WITH MASON AND EVALUATE ENTIRE BUILDING FOR BRICK REPOINTING AND REPAIR. FOLLOW PRESERVATION BRIEF #2: "REPOINTING MORTAR JOINTS IN HISTORIC MASONRY BUILDINGS."

3. PROVIDE NEWCOMPOSITE SHUTTERS BY TIMBERLANE AND OPERABLE HARDWARE; COORDINATE AND REUSE EXISTING PINTELS WHERE POSSIBLE SUPPLEMENT WITH MATCHING HARDWARE

REMOVE AND DISCARD THROUGH-WALL UNIT, REPAIR WITH BRICK TO MATCH EXISTING

REMOVE CURB AND SEAL EXISTING VENTS

→ 3 CLEAN AND REPAIR BRICK AS SPECIFIED

4 PROVIDE NEW METAL RAILINGS → 5 AREA OF BRICK RESTORATION

Dalgliesh Gilpin Paxton

Architects


206 5th Street N.E. P.O. Box 2555 Charlottesville Virginia, 22902 tel: 434·977·4480 fax: 434·296·8720 info@dgparchitects.com

 \sim 0

Job #	Date	
4381	8 JUL 14	
Drawn	Checked	
ACS / GMR	RLB	

CONTRACTOR TO VERIFY ALL DIMENSIONS AT SITE AND SHALL NOTIFY ARCHITECT OF ANY DISCREPANCIES BEFORE PROCEEDING

	Revisions	
#	Date	Ву

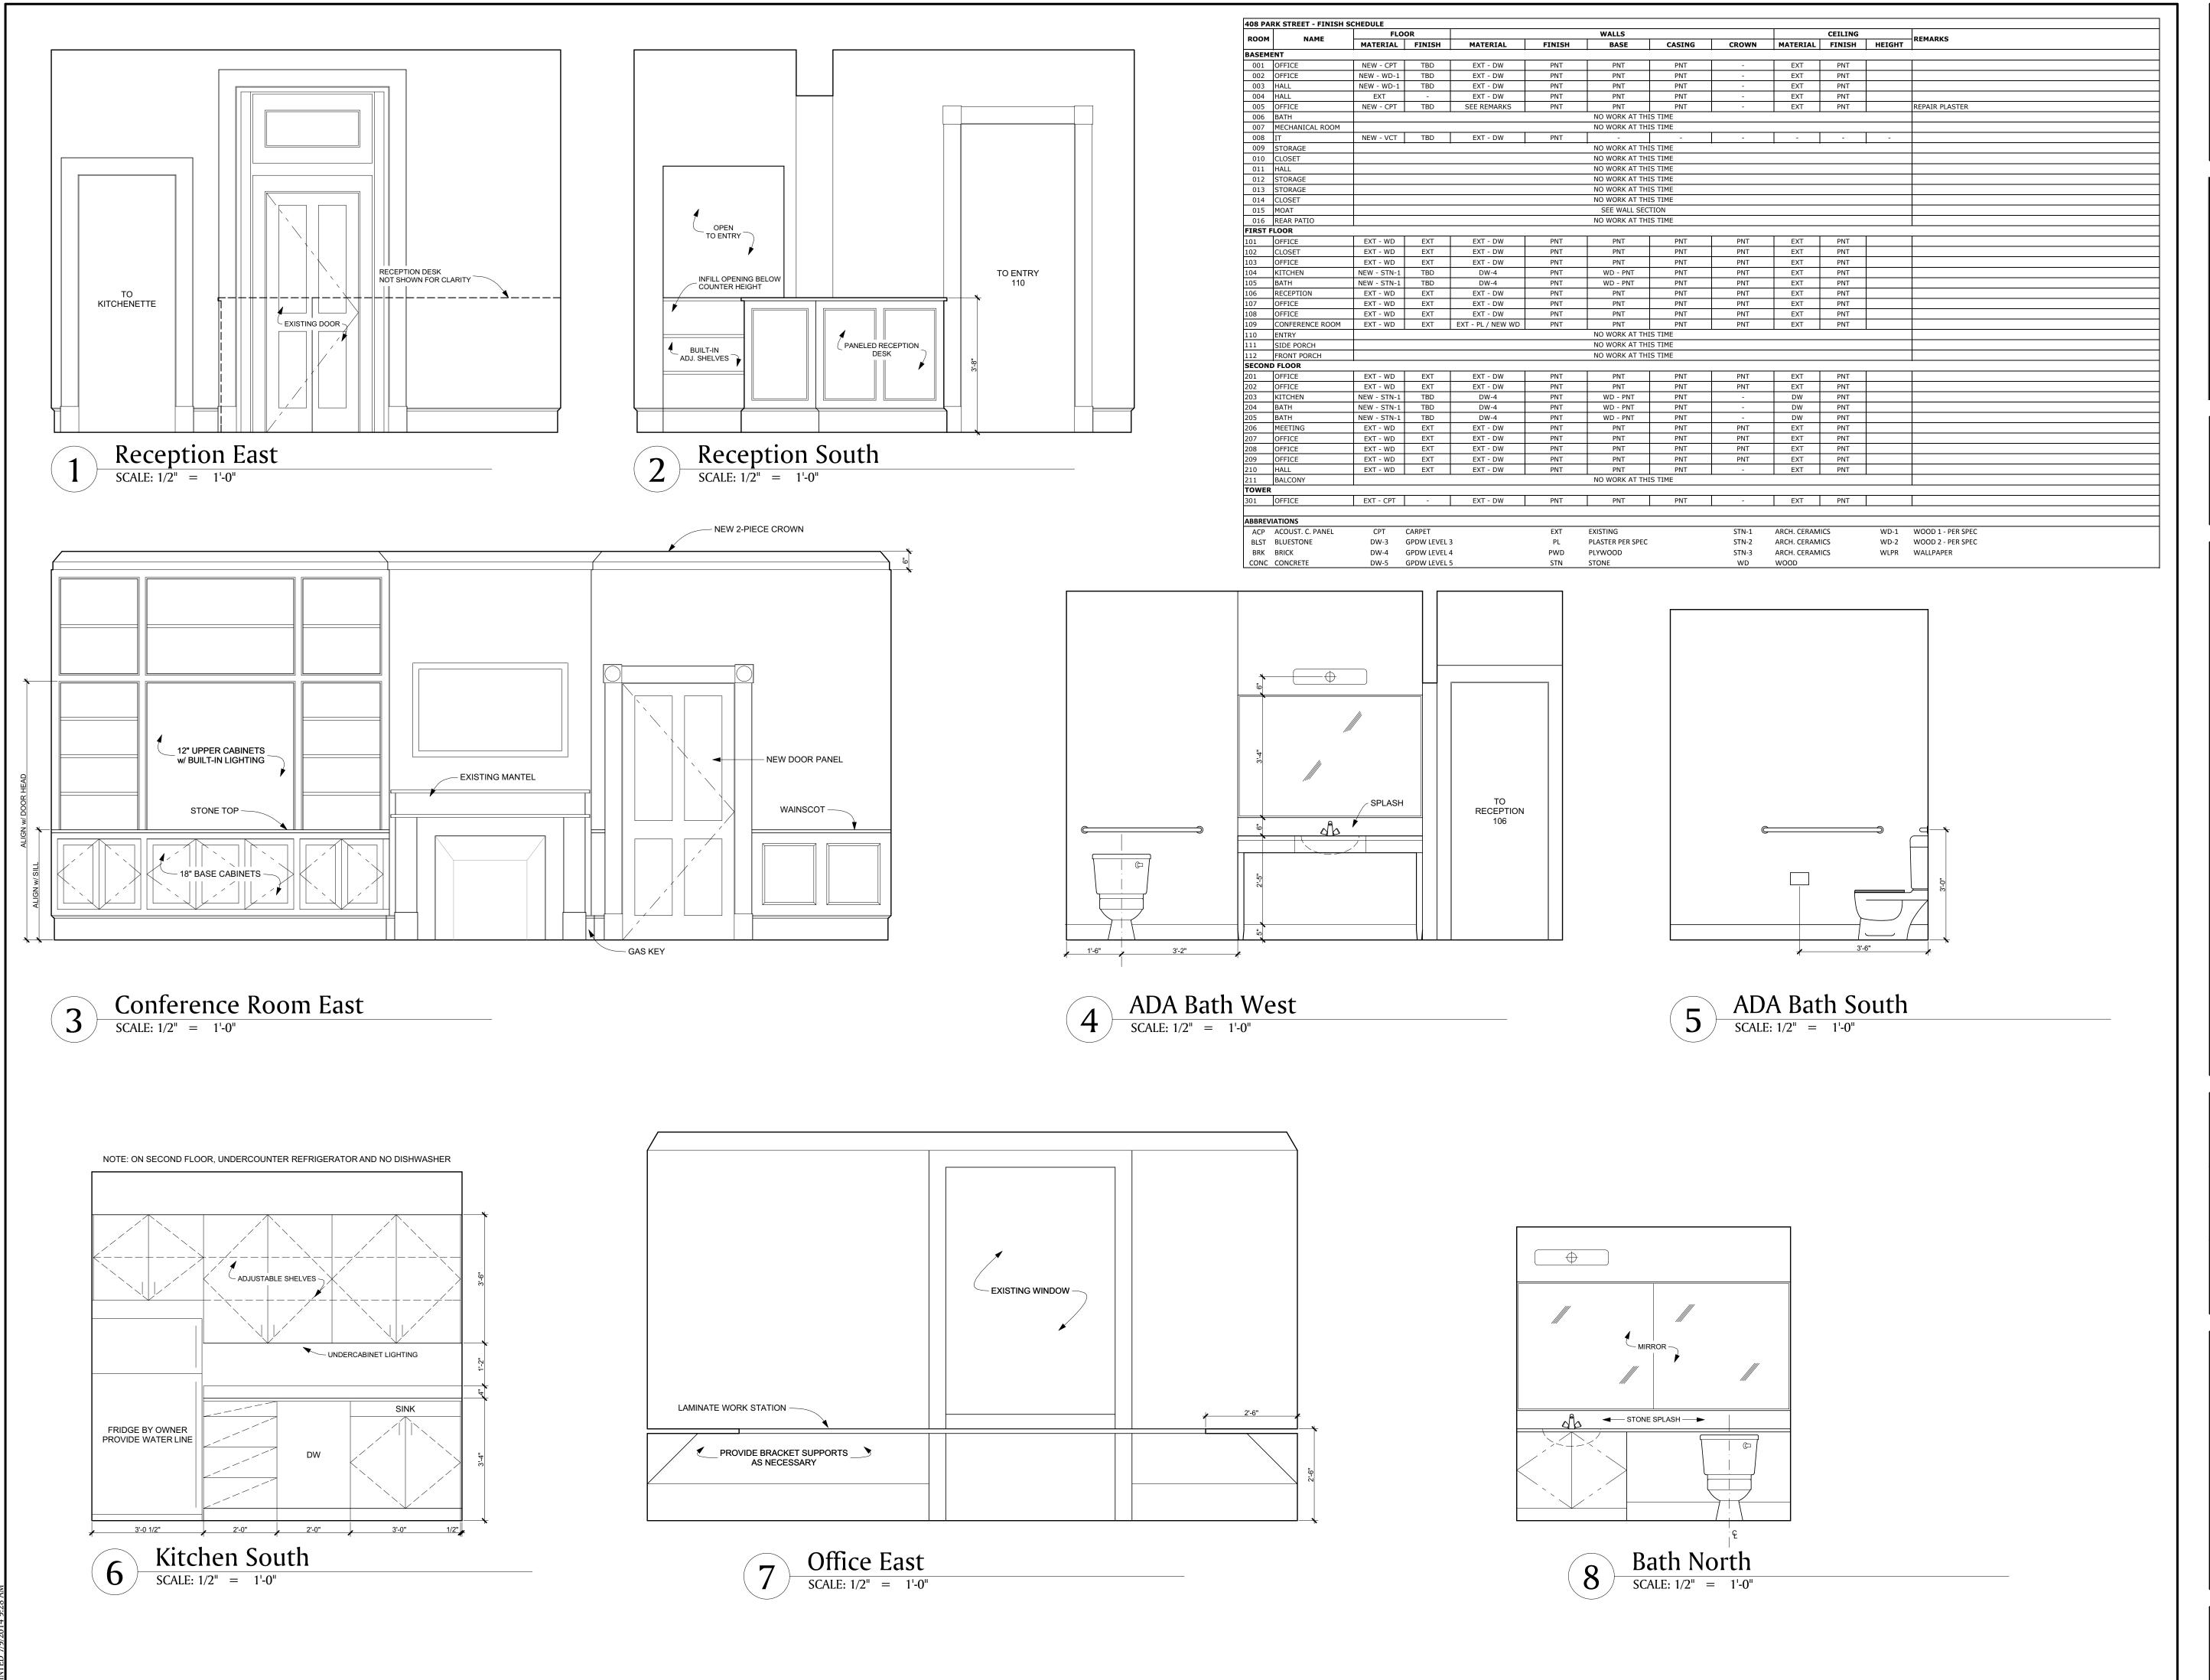

Approved:

Dalgliesh
Gilpin
Paxton

Architects

206 5th Street N.E.
P.O. Box 2555
Charlottesville Virginia, 22902
tel: 434·977·4480
fax: 434·296·8720
info@dgparchitects.com

4 0 8 P A R K S T R E E T
CHARLOTTESVILLE, VIRGINIA
INTERIOR FI FVATIONS 8, FINISH SCHIDIII

Job #	Date
4381	8 JUL 14
Drawn	Checked
ACS / GMR	RLB

CONTRACTOR TO VERIFY ALL
DIMENSIONS AT SITE AND SHALL
NOTIFY ARCHITECT OF ANY
DISCREPANCIES BEFORE PROCEEDING

	Revisions	
#	Date	Ву





210 Hall South NOT TO SCALE

Hall West

NOT TO SCALE

Hall East



PROVIDE A NEW PAIR OF WOOD DOORS INCLUDING HARDWARE, HEIGHT AND WIDTH TO MATCH ORIGINAL OPENING

RESTORE GUARDRAIL AND PROVIDE PICKETS TO MATCH EXISTING REMOVE AND DISCARD GUARDRAIL INFILL

REPAIR FLOORING IN AREAS IMPACTED BY SELECTIVE REMOVALS

Z RIOR

Dalgliesh

Gilpin

Paxton

Architects

206 5th Street N.E.

Charlottesville Virginia, 22902

tel: 434·977·4480 fax: 434·296·8720

P.O. Box 2555

info@dgparchitects.com


	L
Job #	Date
4381	8 JUL 14
Drawn	Checked
ACS / GMR	RLB

 ∞

0

CONTRACTOR TO VERIFY ALL DIMENSIONS AT SITE AND SHALL NOTIFY ARCHITECT OF ANY DISCREPANCIES BEFORE PROCEEDING

	Revisions	
#	Date	Ву

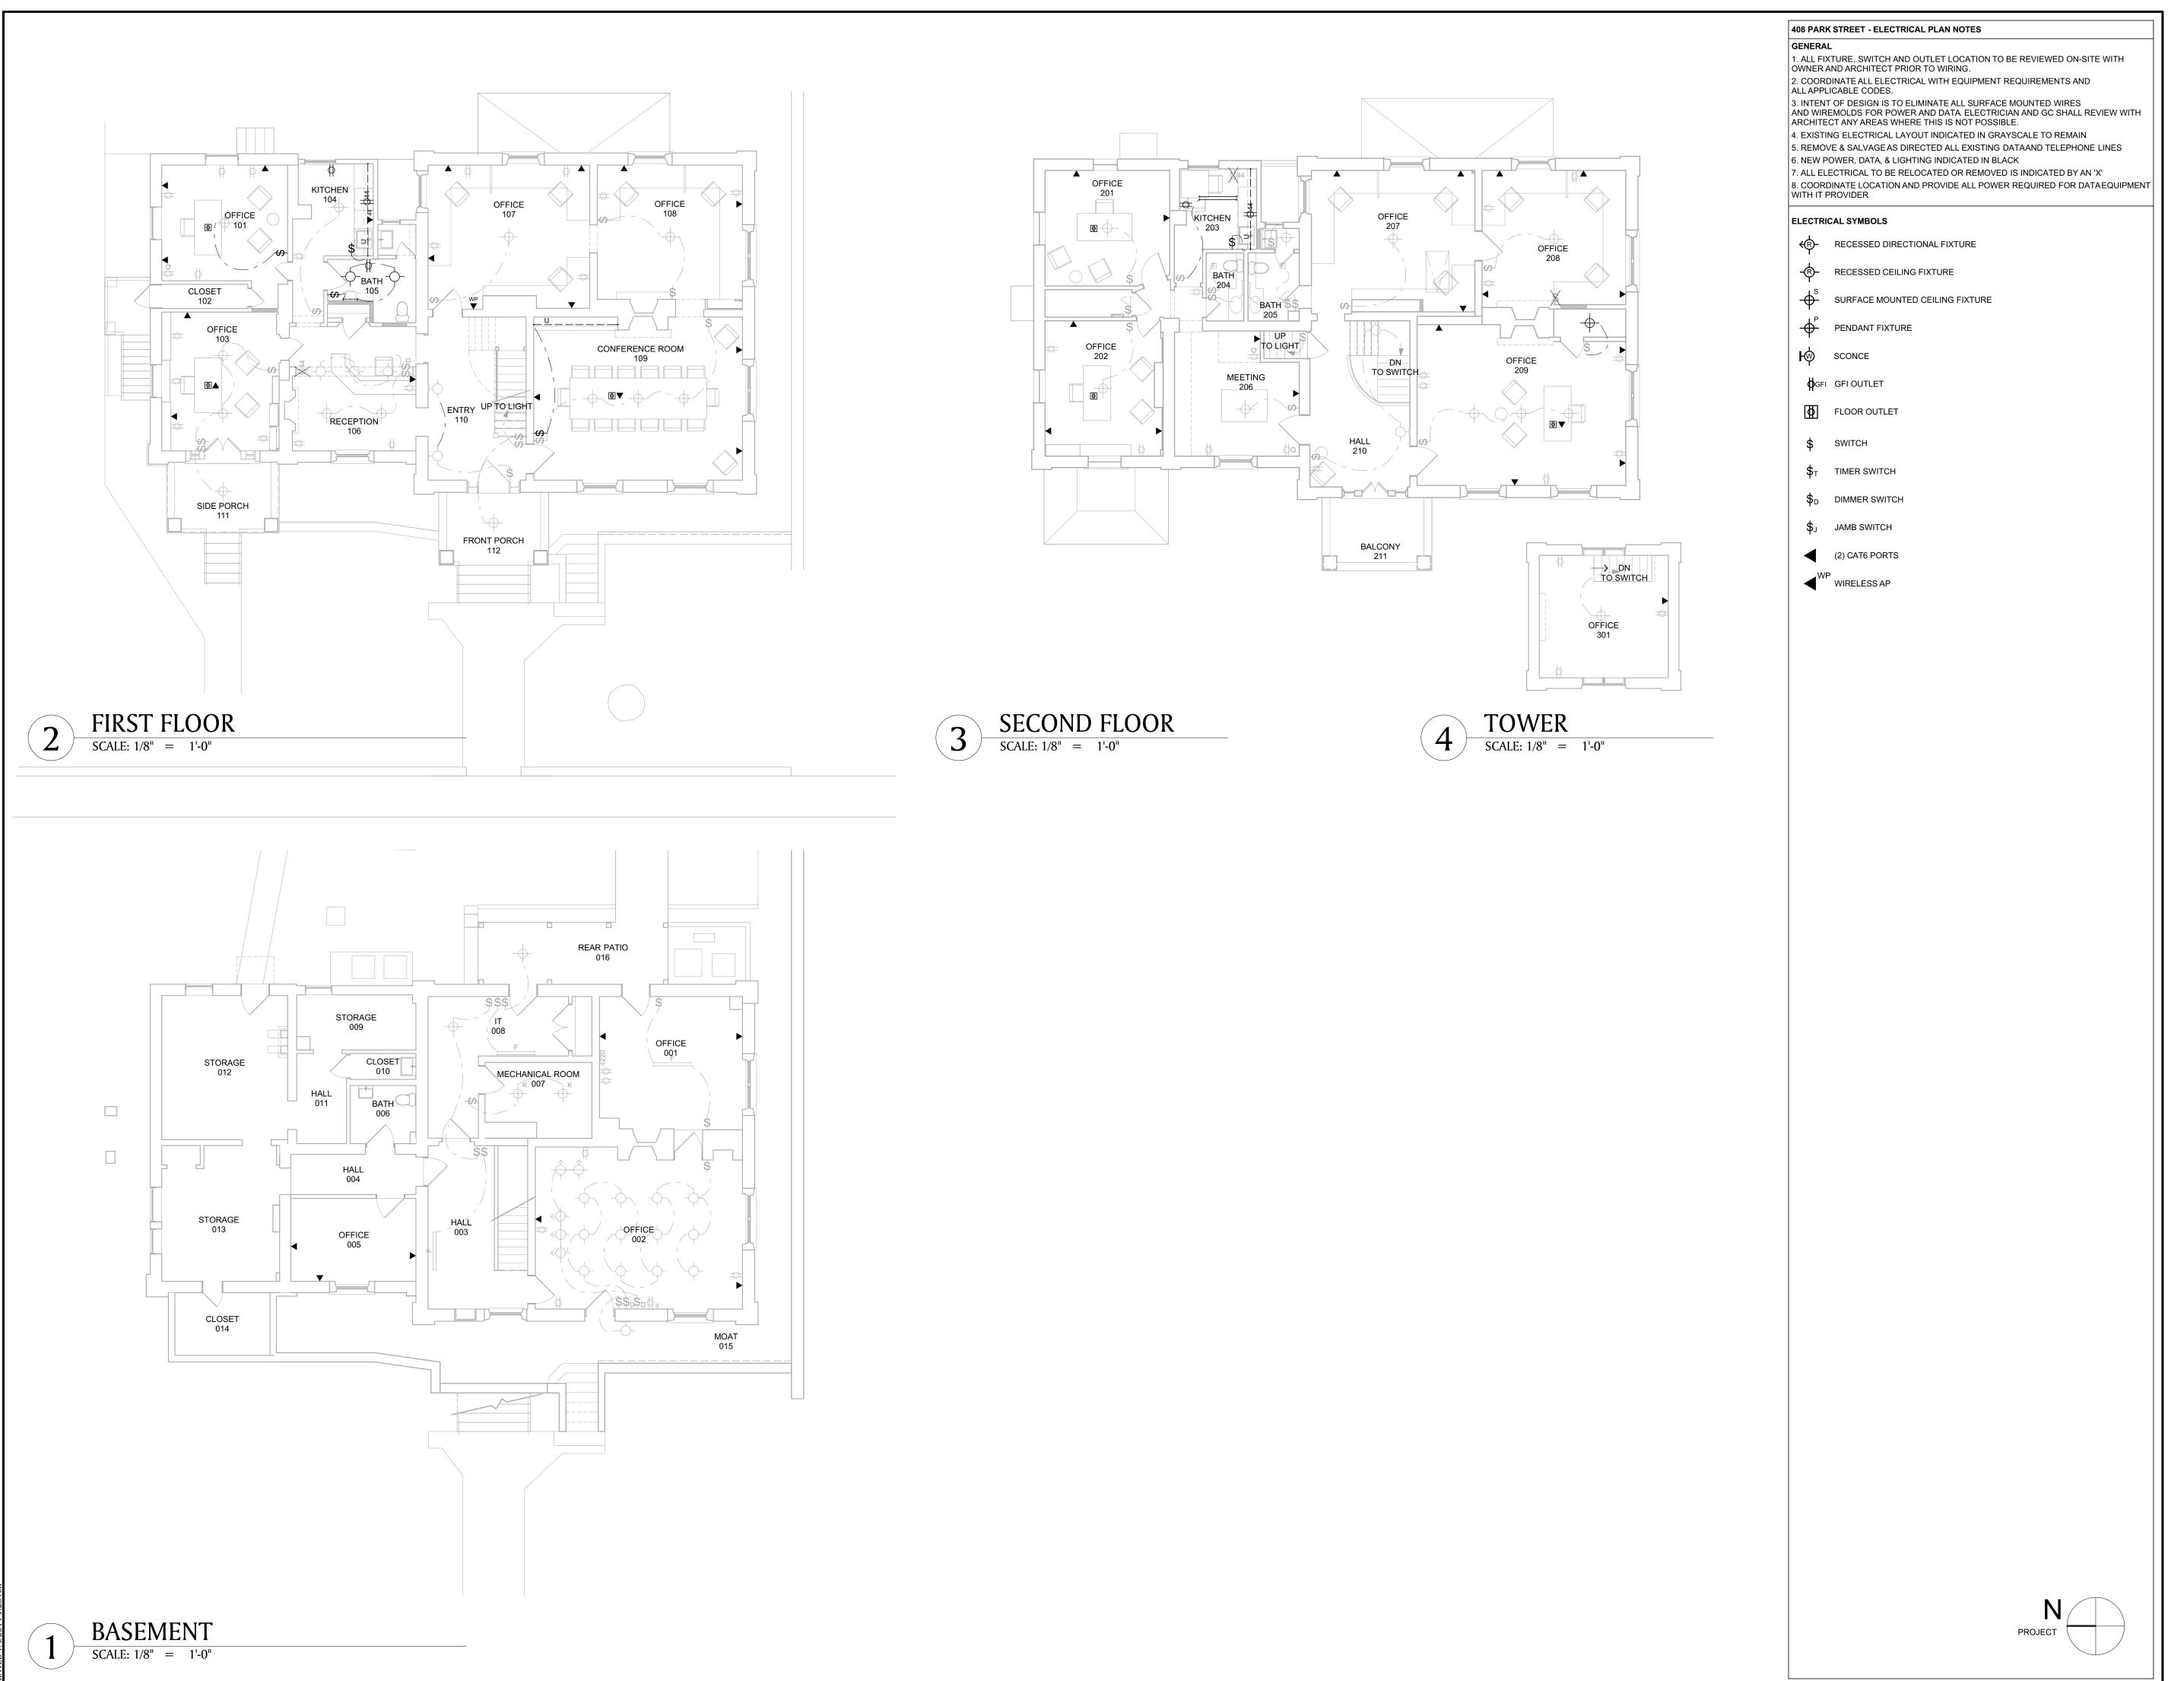

Approved:

Dalgliesh
Gilpin
Paxton

Architects

206 5th Street N.E.
P.O. Box 2555
Charlottesville Virginia, 22902
tel: 434·977·4480
fax: 434·296·8720
info@dgparchitects.com

O 8 P A R K S T R E E T CHARLOTTESVILLE, VIRGINIA

ER

POWI

Job # Date
4381 8 JUL 14

Drawn Checked

ACS / GMR RLB

CONTRACTOR TO VERIFY ALL
DIMENSIONS AT SITE AND SHALL
NOTIFY ARCHITECT OF ANY
DISCREPANCIES BEFORE PROCEEDING

Revisions		
#	Date	Ву

Sheet
E-200