From: Rourke, Kristin

Sent: Tuesday, November 27, 2012 12:48 PM

To: cgathright@dgarchs.com

Subject: November BAR - 315 West Main Street

November 27, 2012

Clark Gathright 100 10th Street NE Suite 200 Charlottesville, VA 22902

Certificate of Appropriateness Application (Deferred from August 2012)

BAR 12-05-03
315 W Main Street
Tax Map 32 Parcels 197 and 198
Clark Gathright, Applicant/VIM, Inc., Owner
New 7-story hotel

Dear Applicant,

The above referenced project was discussed before a meeting of the City of Charlottesville Board of Architectural Review (BAR) on November 20, 2012. The following action was taken:

Approved (7-0) with the following conditions and information to come back to the BAR for final approval:

- 1. Color of stucco on C building;
- 2. Courtyard furnishings and plantings;
- 3. Comprehensive sign package [requires BAR recommendation and City Council approval];
- 4. Further investigation whether planting is possible on the north side of the property in association with the parking deck;
- 5. Banding on A & B buildings: approve either brick soldier course or precast options;
- 6. Exclude approval of final lighting and mechanical package until later date.

A friendly suggestion was made to look at further articulation of windows on south elevations.

Note that the BAR's intent was to allow the preliminary site plan approval to occur.

If you have any questions, please contact me at 434-970-3130 or scala@charlottesville.org.

Sincerely yours,

Mary Joy Scala, AICP Preservation and Design Planner

Mary Joy Scala, AICP

Preservation and Design Planner City of Charlottesville Department of Neighborhood Development Services City Hall - 610 East Market Street P.O. Box 911

CITY OF CHARLOTTESVILLE BOARD OF ARCHITECTURAL REVIEW STAFF REPORT

November 20, 2012



Certificate of Appropriateness Application (Deferred from August 2012)

BAR 12-05-03 315 W Main Street Tax Map 32 Parcels 197 and 198 Clark Gathright, Applicant/VIM, Inc., Owner New 7-story hotel

Background

301 West Main Street (c. 1957) and 315 West Main Street (c. 1938; 1947; 1951) are located in the Downtown ADC District.

October 18, 2005 - BAR approves (8-0) demolition of 301 West Main Street. The applicant requested deferral of the 315 West Main Street application in order to have prepared a structural report.

November 15, 2005 - BAR approves (7-2) demolition of 315 West Main Street

<u>September 18, 2006</u> - The Director of Neighborhood Development Services agreed to extend both certificates of appropriateness for one year as permitted by Sec. 34- 280 because the building tenant (RSC equipment rental) exercised their option to renew their lease for another year.

November 28, 2006 – BAR denied (9-0) CVS project based on standards and guidelines especially site plan, massing, scale, and materials.

October 16, 2007 - BAR approves (7-0) demolition of both buildings on consent agenda.

<u>July 15, 2008</u> – BAR approved (6-2) a new mixed-use project including the concept of the massing, general articulation, and disposition of materials, but required the details to be re-studied and returned to the BAR for further approval.

<u>September 25, 2008</u> - The Director of Neighborhood Development Services agreed to extend both demolition approvals for one year, until October 16, 2009.

May 19, 2009 - The BAR approved (8-1) the application for demolition of 301 and 315 West Main Street and asked staff to report back next month regarding the City Attorney's opinion as to when the permit will expire. (The applicant asked the BAR if the one-year approval could begin in October 2009, when the previous permit would expire, rather than the meeting date.) The City Attorney's opinion was that the permit would expire one year from the meeting date, or May 19, 2010.

<u>June 15, 2010</u>- The BAR approved demolition of 301 W Main (8-0); approved demolition of 315 W Main (6-2 with Brennan and Schoenthal opposed).

<u>June 15, 2011</u> - The Director of Neighborhood Development Services agreed to extend the validity of the COA for one year, or until June 15, 2012.

Current project

<u>February 21, 2012</u> – The BAR was generally supportive of the preliminary proposal. Suggestions made were to wrap the corner of Building C with Building B; landscaping and screening parking are important; pedestrian access to Main Street is important; give thought to courtyard (trees, access to hotel).

May 15, 2012 - The BAR approved (4-2-1) the application as submitted to demolish 301 and 315 W Main Street.

May 15, 2012- The BAR accepted (6-0-1) the applicant's request for deferral. The BAR requested further details on: the materials, wall sections, windows details, cornices, articulation of façades, lighting (cut sheets and photometrics), paving materials. Look at the plans along West Main Street. Do not necessarily propose white windows; part of the building may want to be monochromatic.

June 19, 2012 – The BAR approved (5-1-1 with Adams opposed and Hogg abstaining) the massing, conceptual landscape plan, and conceptual use of manufactured stone and brick on the A & B structures with full detailing of those elements, samples, manufacturer's product information and all things requested at the last meeting (building section, window details, etc.) to come back to the BAR for final approval.

The BAR approved (5-1-1 with Adams opposed and Hogg abstaining) the conceptual use of stucco on the C structure subject to all detailing and color studies as discussed coming back to the BAR for final approval.

August 21, 2012 - The applicant requested deferral before the meeting.

This property is located in the Downtown ADC District. The Guidelines describe the West Main Street sub-area as: increasingly vital commercial district with strong definition of the street edge and moderate pedestrian activity typically medium scaled, turn of the century masonry structures, generally mixed use with commercial/service below and residential above, street parking with small off street lots.

The current zoning is *Downtown Corridor* Mixed Use District, which requires a minimum height of 45 feet and allows a maximum height of 70 feet with stepback requirements. Up to 101 feet may be permitted with a special use permit. The parking zone is "Parking Modified Zone"

The minimum height of the streetwall must be 40 feet, and the maximum height of the streetwall must be 45 feet, containing **exactly 3 interior floors**. After 45 feet, there shall be a minimum stepback of 25 feet. At least 75% of the streetwall must be built to the property line adjacent a primary street (both Ridge-McIntire and West Main are primary streets). Up to 25% of the streetwall may be set back a maximum of 20 feet, except up to 50% may be set back up to 20 feet if streetscape trees are provided, or if City Council approves a special use permit.

Application

The applicant seeks final approval for a seven-story hotel with 124 rooms and parking for 119 vehicles, including one level of structured parking (82 spaces) and a surface parking lot (37 spaces). The surface parking lot and the drive-up lobby entrance are accessed from both Ridge-McIntire and 4th Street NW entrance/exits.

The attached email outlines two major design changes:

- 1. The arrival level has been raised, eliminating the need for a two-level lobby.
- 2. Building A now has mezzanine guest rooms, rather than double height meeting rooms. (See Discussion and Recommendations this change conflicts with zoning, which requires exactly three floors not four.)

The West Main Street frontage includes two sections of hotel buildings (referred to as buildings A and B) separated by a terrace/courtyard. The top two/three floors of these three-story buildings are hotel rooms. On the Ridge-McIntire frontage there are windows that look into the flex space and the pool area. The top three floors along Ridge-McIntire are hotel rooms.

One main entrance to the hotel is proposed along West Main Street, in building B. There are two (minor) entrances to the hotel from the courtyard, one accessing the lobby and one accessing meeting rooms in building A. The terrace/courtyard has been reduced in size since the last submittal, and it is not landscaped. There are no pedestrian entrances along Ridge-McIntire.

Building C, the main part of the hotel, is 7 stories in height. There is a drive-up/pedestrian entrance under a porte-cochere in the parking lot.

The building materials on buildings A and B are:

Manufactured stone veneer Arriscraft Renaissance base and cornice, Brick veneer Old Virginia Brick wood mould Colonial Red Range, and Aluminum/Quaker SH 8050 historical windows dark bronze.

The building materials on building C are:

³/₄" stucco smooth finish Cloud White walls, Stucco cornice (new addition), and Aluminum/Quaker 8050 windows dark bronze.

Consistently used materials include:

Aluminum Kawneer storefront dark bronze, Clear low-e glazing, Metal clad marquee/canopy, and Canvas burgundy awnings.

A 6-foot high bronze equipment screen is shown on building B but no screens are shown around equipment on the roofs of buildings A and C.

The streetscape includes Zelcovas in tree wells with brick pavers and concrete used for sidewalks and the courtyard. Brick pavers are also used in the surface parking lot.

Criteria, Standards, and Guidelines

Review Criteria Generally

Sec. 34-284(b) of the City Code states that,

In considering a particular application the BAR shall approve the application unless it finds:

- (1) That the proposal does not meet specific standards set forth within this division or applicable provisions of the Design Guidelines established by the board pursuant to Sec. 34-288(6); and
- (2) The proposal is incompatible with the historic, cultural or architectural character of the district in which the property is located or the protected property that is the subject of the application.

Pertinent Standards for Review of Construction and Alterations include:

- (1) Whether the material, texture, color, height, scale, mass and placement of the proposed addition, modification or construction are visually and architecturally compatible with the site and the applicable design control district;
- (2) The harmony of the proposed change in terms of overall proportion and the size and placement of entrances, windows, awnings, exterior stairs and signs;
- (3) The Secretary of the Interior Standards for Rehabilitation set forth within the Code of Federal Regulations (36 C.F.R. §67.7(b)), as may be relevant;
- (4) The effect of the proposed change on the historic district neighborhood;
- (5) The impact of the proposed change on other protected features on the property, such as gardens, landscaping, fences, walls and walks;
- (6) Whether the proposed method of construction, renovation or restoration could have an adverse impact on the structure or site, or adjacent buildings or structures;
- (8) Any applicable provisions of the City's Design Guidelines.

Pertinent Design Review Guidelines for New Construction

A. Introduction

3. Building Types

e. Multi-lot

Often new commercial, office, or multiuse buildings will be constructed on sites much larger than the traditionally sized lots 25 to 40 feet wide. Many sites for such structures are located on West Main Street and in the 14th and 15th Street area of Venable neighborhood. These assembled parcels can translate into new structures whose scale and mass may overwhelm neighboring existing structures. Therefore, while this building type may need to respond to the various building conditions of the site, it also should employ design techniques to reduce its visual presence. These could include varying façade wall planes, differing materials, stepped-back upper levels, and irregular massing.

B.Setback

- 1. Construct new commercial buildings with a minimal or no setback in order to reinforce the traditional street wall.
- 2. Use a minimal setback if the desire is to create a strong street wall or setback consistent with the surrounding area.
- 3. Modify setback as necessary for sub-areas that do not have well-defined street walls.
- 4. Avoid deep setbacks or open corner plazas on corner buildings in the downtown in order to maintain the traditional grid of the commercial district.
- 5.In the West Main Street corridor, construct new buildings with a minimal (up to 15 feet according to the zoning ordinance) or no setback in order to reinforce the street wall. If the site adjoins historic buildings, consider a setback consistent with these buildings.
- 6.On corners of the West Main Street corridor, avoid deep setbacks or open corner plazas unless the design contributes to the pedestrian experience or improves the transition to an adjacent residential area.
- 7.New buildings, particularly in the West Main Street corridor, should relate to any neighborhoods adjoining them. Buffer areas should be considered to include any screening and landscaping requirements of the zoning ordinance. 8.At transitional sites between two distinctive areas of setback, for instance between new commercial and historic commercial, consider using setbacks in the new construction that reinforce and relate to

C. Spacing

- 2. Commercial and office buildings in areas that have a well-defined street wall should have minimal spacing between them.
- 3. In areas that do not have consistent spacing, consider limiting or creating a more uniform spacing in order to establish an overall rhythm.
- 4. Multi-lot buildings should be designed using techniques to incorporate and respect the existing spacing on a residential street.

P. 3.6 Massing & Footprint

- 1.New commercial infill buildings' footprints will be limited by the size of the existing lot in the downtown or along the West Main Street corridor. Their massing in most cases should be simple rectangles like neighboring buildings. 2.New infill construction in residential sub-areas should relate in footprint and massing to the majority of surrounding historic dwellings.
- 3.Neighborhood transitional buildings should have small building footprints similar to nearby dwellings. a.If the footprint is larger, their massing should be reduced to relate to the smaller-scaled forms of residential structures.
- b. Techniques to reduce massing could include stepping back upper levels, adding residential roof and porch forms, and using sympathetic materials.
- 4.Institutional and multi-lot buildings by their nature will have large footprints, particularly along the West Main Street corridor and in the 14th and 15th Street area of the Venable neighborhood.
- a. The massing of such a large scale structure should not overpower the traditional scale of the majority of nearby buildings in the district in which it is located.
- b. Techniques could include varying the surface planes of the buildings, stepping back the buildings as the structure increases in height, and breaking up the roof line with different elements to create smaller compositions.

E. Height and Width

1. Respect the directional expression of the majority of surrounding buildings. In commercial areas, respect the expression of any adjacent historic buildings, which generally will have a more vertical expression.

- 2. Attempt to keep the height and width of new buildings within a maximum of 200 percent of the prevailing height and width in the surrounding sub-area.
- 3.In commercial areas at street front, the height should be within 130 percent of the prevailing average of both sides of the block. Along West Main Street, heights should relate to any adjacent contributing buildings. Additional stories should be stepped back so that the additional height is not readily visible from the street.
- 4. When the primary façade of a new building in a commercial area, such as downtown, West Main Street, or the Corner, is wider than the surrounding historic buildings or the traditional lot size, consider modulating it with bays or varying planes.
- 5. Reinforce the human scale of the historic districts by including elements such as porches, entrances, storefronts, and decorative features depending on the character of the particular sub-area.
- 6. In the West Main Street corridor, regardless of surrounding buildings, new construction should use elements at the street level, such as cornices, entrances, and display windows, to reinforce the human scale,

F. Scale

- 1. Provide features on new construction that reinforce the scale and character of the surrounding area, whether human or monumental. Include elements such as storefronts, vertical and horizontal divisions, upper story windows, and decorative features.
- 2. As an exception, new institutional or governmental buildings may be more appropriate on a monumental scale depending on their function and their site conditions.

H. Orientation

- 1. New commercial construction should orient its façade in the same direction as adjacent historic buildings, that is, to the street.
- 2. Front elevations oriented to side streets or to the interior of lots should be discouraged.

I.Windows and Doors

- 1. The rhythm, patterns, and ratio of solids (walls) and voids (windows and doors) of new buildings should relate to and be compatible with adjacent historic facades.
- a. The majority of existing buildings in Charlottesville's historic districts have a higher proportion of wall area than void area except at the storefront level.
- b. In the West Main Street corridor in particular, new buildings should reinforce this traditional proportion.
- 2. The size and proportion, or the ratio of width to height, of window and door openings on new buildings' primary facades should be similar and compatible with those on surrounding historic facades.
- a. The proportions of the upper floor windows of most of Charlottesville's historic buildings are more vertical than horizontal.
- b. Glass storefronts would generally have more horizontal proportions than upper floor openings.
- 3. Traditionally designed openings generally are recessed on masonry buildings and have a raised surround on frame buildings. New construction should follow these methods in the historic districts as opposed to designing openings that are flush with the rest of the wall.
- 4. Many entrances of Charlottesville's historic buildings have special features such as transoms, sidelights, and decorative elements framing the openings. Consideration should be given to incorporating such elements in new construction.
- 5. Darkly tinted mirrored glass is not an appropriate material for windows in new buildings within the historic districts.
- 6. If small-paned windows are used, they should have true divided lights or simulated divided lights with permanently affixed interior and exterior muntin bars and integral spacer bars between the panes of glass.

 7. Avoid designing false windows in new construction.
- 8. Appropriate material for new windows depends upon the context of the building within a historic district, and the design of the proposed building. Sustainable materials such as wood, aluminum-clad wood, solid fiberglass, and metal windows are preferred for new construction. Vinyl windows are discouraged.
- 9. Glass shall be clear. Opaque spandrel glass or translucent glass may be approved by the BAR for specific applications.

K. Street level Design

1. Street level facades of all building types, whether commercial, office, or institutional, should not have blank walls; they should provide visual interest to the passing pedestrian.

- 2. When designing new storefronts or elements for storefronts, conform to the general configuration of traditional storefronts depending on the context of the sub-area. New structures do offer the opportunity for more contemporary storefront designs.
- 3. Keep the ground level facades(s) of new retail commercial buildings at least eighty percent transparent up to a level of ten feet.
- 4. Include doors in all storefronts to reinforce street level vitality.
- 5. Articulate the bays of institutional or office buildings to provide visual interest.
- 6. Institutional buildings, such as city halls, libraries, and post offices, generally do not have storefronts, but their street levels should provide visual interest and display space or first floor windows should be integrated into the design.
- 7. Office buildings should provide windows or other visual interest at street level.
- 8. Neighborhood transitional buildings in general should not have transparent first floors, and the design and size of their façade openings should relate more to neighboring residential structures.
- 9. Along West Main Street, secondary (rear) facades should also include features to relate appropriately to any adjacent residential areas.
- 10. Any parking structures facing on important streets or on pedestrian routes must have storefronts, display windows, or other forms of visual relief on the first floors of these elevations.
- 11. A parking garage vehicular entrance/exit opening should be diminished in scale, and located off to the side to the degree possible.

L. Foundation and Cornice

- 1. Distinguish the foundation from the rest of the structure through the use of different materials, patterns, or textures.
- 2. Respect the height, contrast of materials, and textures of foundations on surrounding historic buildings.
- 3. If used, cornices should be in proportion to the rest of the building.
- 4. Wood or metal cornices are preferred. The use of fypon may be appropriate where the location is not immediately adjacent to pedestrians.

M. Materials and Textures

- 1. The selection of materials and textures for a new building should be compatible with and complementary to neighboring buildings.
- 2. In order to strengthen the traditional image of the residential areas of the historic districts, brick, stucco, and wood siding are the most appropriate materials for new buildings.
- 3. In commercial/office areas, brick is generally the most appropriate material for new structures. "Thin set" brick is not permitted. Stone is more commonly used for site walls than buildings.
- 4. Large-scale, multi-lot buildings, whose primary facades have been divided into different bays and planes to relate to existing neighboring buildings, can have varied materials, shades, and textures.
- 5. Synthetic siding and trim, including, vinyl and aluminum, are not historic cladding materials in the historic districts, and their use should be avoided.
- 6. Cementitious siding, such as HardiPlank boards and panels, are appropriate.
- 7. Concrete or metal panels may be appropriate.
- 8. Metal storefronts in clear or bronze are appropriate.
- 9. The use of Exterior Insulation and Finish Systems (EIFS) is discouraged but may be approved on items such as gables where it cannot be seen or damaged. It requires careful design of the location of control joints.
- 10. The use of fiberglass-reinforced plastic is discouraged. If used, it must be painted.
- 11. All exterior trim woodwork, decking and flooring must be painted, or may be stained solid if not visible from public right-of-way.

O. Details and Decorations

- 1. Building detail and ornamentation should be consistent with and related to the architecture of the surrounding context and district.
- 2. The mass of larger buildings may be reduced using articulated design details.
- 3. Pedestrian scale may be reinforced with details.

Discussion and Recommendations

Downtown Corridor zoning requires exactly three floors within the 40-45 foot high streetwall portion of the building. Building A incorrectly contains four floors.

Zoning requires that all the rooftop mechanical units must be screened.

The BAR may also wish to comment on the landscaping/site plan and articulation details of the building facades (sections, window and stucco details), specific materials, stucco color, and lighting.

Signage

The BAR must review signage for new construction. Three signs are permitted on a corner property. The signage as shown does not comply with zoning requirements as follows:

- 1. Signs are not permitted anywhere above the second floor window sills.
- 2.In the Downtown ADC District:

Freestanding and monument signs are not permitted;

Internally lit signs (including channel letters) are not permitted;

Projecting signs may be 10 square feet; the aggregate signage area permitted is 50 square feet.

The BAR may wish to comment on the proposed signage in relation to the following Downtown ADC District zoning requirement for signage: "The character of all signs shall be harmonious to the character of the structure on which they are placed. Among other things, consideration shall be given to the **location of signs** on the structure in relation to the surrounding buildings; the use of **compatible colors**; the use of **appropriate materials**; the size and style of **lettering and graphics**; and the type of **lighting**."

The applicant may choose to apply for a Comprehensive Signage Plan, which allows modifications from existing regulations for good reason, to be recommended by the BAR and approved by City Council. Staff could recommend four hotel signs, including one canopy sign at each main hotel entrance, and a monument sign at each car entrance to the parking lot. Staff would not recommend signage above the second floor window sills, and would not recommend internally lit signage. In the Downtown ADC district, externally lit signage or halo-lit letters are most appropriate.

Suggested Motion

Having considered the standards set forth within the City Code, including City Design Guidelines for New Construction, I move to find that the proposed hotel satisfies the BAR's criteria and is compatible with this property and other properties in the Downtown ADC district, and that the BAR approves the proposal with the following modifications....

Scala, Mary Joy

From:

Clark Gathright <cgathright@dgarchs.com>

Sent:

Wednesday, August 15, 2012 2:54 PM

To:

Scala, Mary Joy

Subject:

West Main Residence Inn

Mary Joy:

We are going through a number of internal space re-design issues on the hotel which are likely to affect the exterior of the hotel.

I've been asked to request a deferral for next week's meeting.

Clark Gathright

Daggett + Grigg Architects 100 10th Street NE, Suite 200 Charlottesville, VA 22902 434.971.8848

Scala, Mary Joy

From: Sent: Kathy Brown <kathy@virginiapregnancy.org> Wednesday, August 15, 2012 10:49 AM

To:

Scala, Mary Joy

Subject:

Comments for BAR

Dear Ms. Mary Joy Scala,

We received the notice dated Aug 7, 2012, about a 7 story hotel being proposed across the street from The Pregnancy Centers of Central Virginia on West Main St. I am the Executive Director of The Pregnancy Centers and our largest Center is located at 320 West Main St. It sees on average 90-140 women each month.

A hotel in the neighborhood will change the character of the street dramatically. It will add more traffic and on-street parking needs for events and patrons of the hotel. Have these needs been addressed while still preserving the businesses and service organizations on the same block?

We also would ask that the handicapped parking space in front of our Center be moved to in front of the hotel, and this space revert back to a regular parking spot. This handicapped parking spot used to be in front of the bus station, but was moved to in front of our center several years ago. We only have this one parking spot in front of our building on the street. We do have a private parking lot behind our building, but many clients as well as people donating baby furniture & maternity items to us are not comfortable driving the narrow alley to our parking area. The parking spot would be very useful and helpful. I believe most of the handicapped drivers needing a parking spot would be patrons of the hotel and thus it makes sense that the handicapped spot be on the same side of the street as the hotel.

Thank you for your consideration of my comments. Sincerely, Kathy

Kathy Brown
Executive Director
The Pregnancy Centers of Central Virginia
1420 Greenbrier Place
Charlottesville, VA 2901
434-979-4516, ext 107
www.virginiapregnancy.org

"Do not be overcome by evil, but overcome evil with good."





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Building Section

A7.2 Building Section

<u>S</u> 1	GNAGE
1	Proposed Signs
2	North Elevation
3	East Elevation
4	South Elevation
5	Proposed Monument Sign
6	Proposed Monument Sign

ELECTRICAL

E1.0 Site Photometric Plan

Project Data

SITE ACREAGE:

48,974 SQ. FT. (1.12 ACRES)

GUEST ROOMS:

A7.1

GARAGE PARKING: 82 SPACES PARKING SPACES: GRADE PARKING: 31 SPACES TOTAL PARKING: 119 SPACES

CONSTRUCTION TYPE:

FLOORS:

7 FLOORS

BUILDING HEIGHT:

69'-4" TO TOP OF STRUCTURAL ROOF 1'-4" TO TOP OF PARAPET

SQUARE FOOTAGE:			
FLOOR	GROSS SQ. FOOTAGE		
OWER LEVEL PARKING PLAN	31,498 SQ. FT.		
OWER LEVEL PLAN		6,213 SQ. FT.	
ELEVATED PARKING STRUCTURE	18,2001 SQ. FT.		
GROUND FLOOR PLAN		21,Ø32 5Q. FT.	
SECOND FLOOR / MEZZANINE PLAN		15,52Ø SQ. FT,	
HIRD FLOOR PLAN		19,976 SQ. FT.	
OURTH FLOOR PLAN		19,976 SQ. FT.	
IFTH FLOOR PLAN		12,080 SQ. FT.	
IXTH FLOOR PLAN		12,080 SQ. FT.	
EVENTH FLOOR PLAN		11,811 SQ. FT.	
OTAL	49.698 SQ FT	118.694 SO ET	



803 S. MOUNT MORIAH SUITE 100B MEMPHIS. TN 38117 (901) 683-7175 p. (901) 683-2385 f.

ISSUED DATE

NO.	REVISIONS	DATE

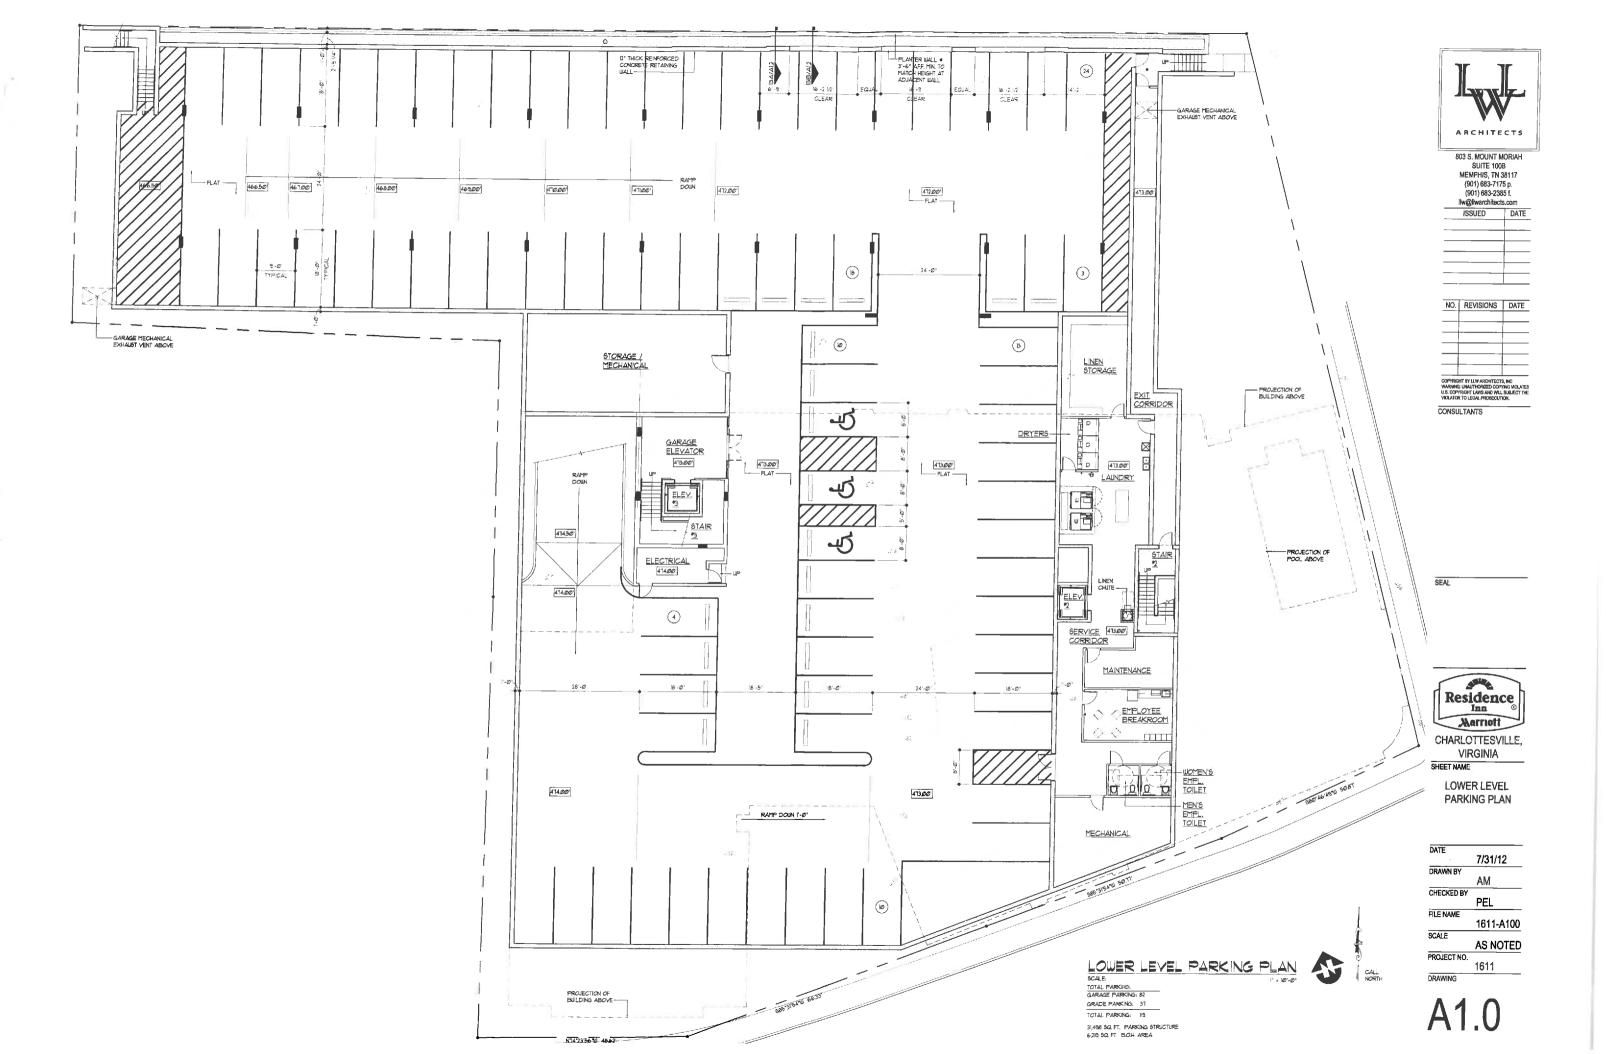
CONSULTANTS

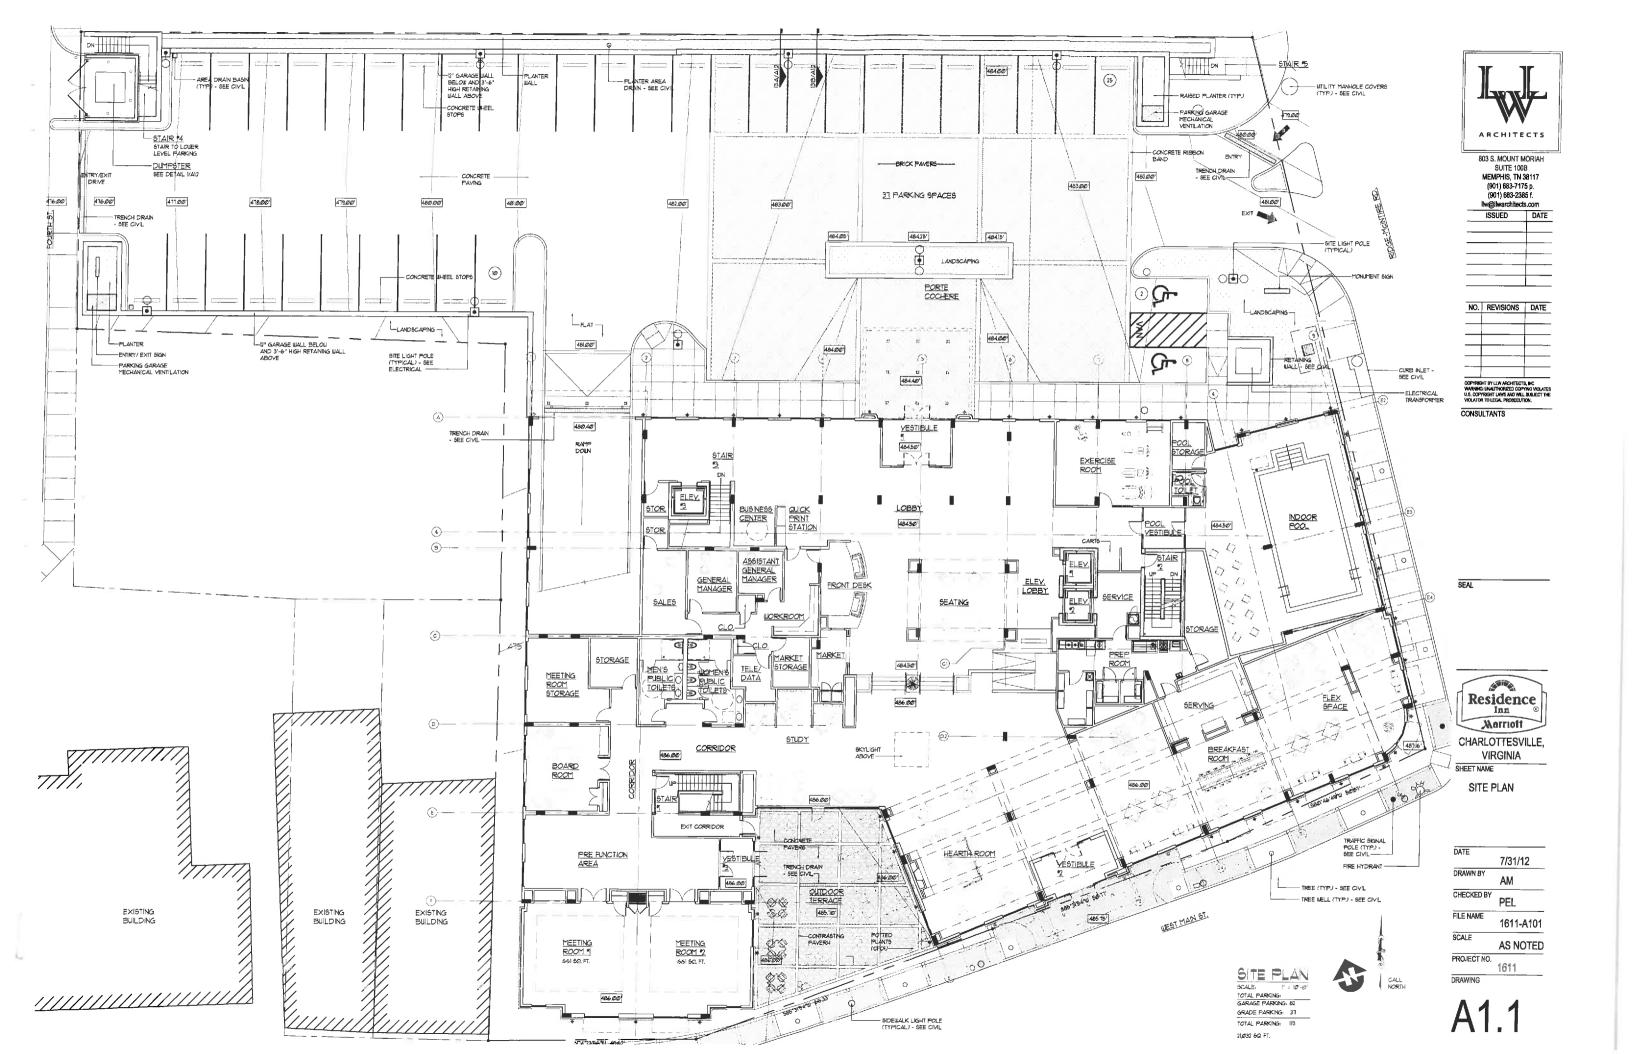


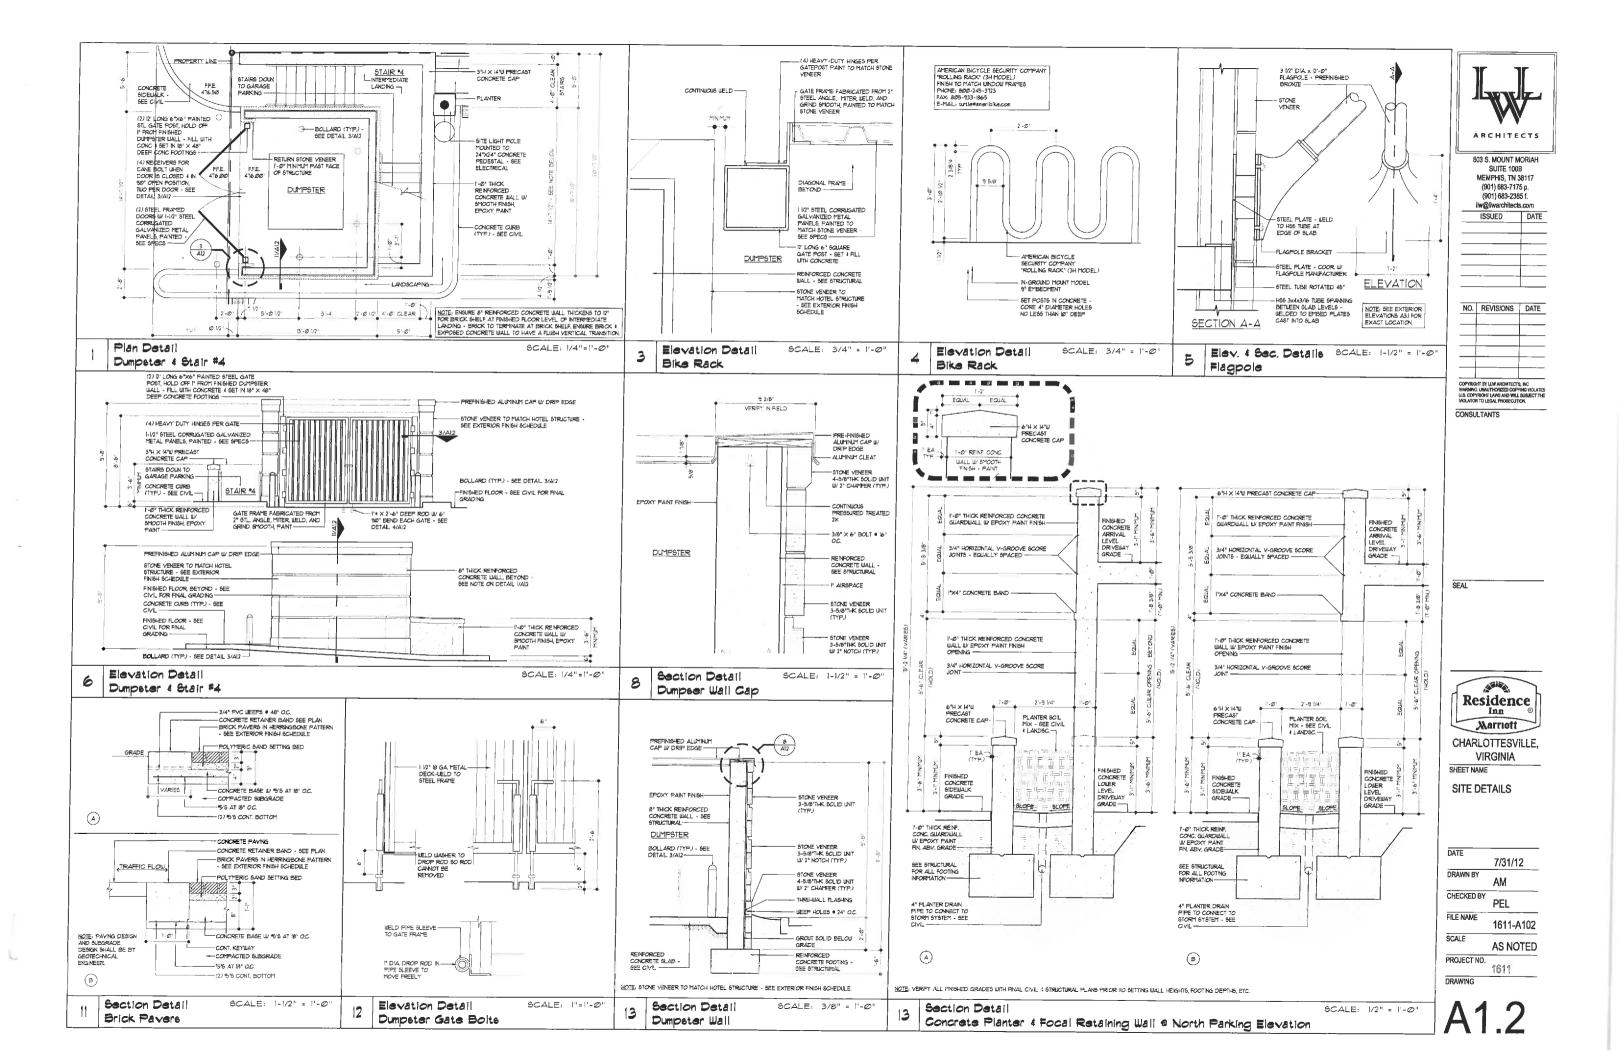
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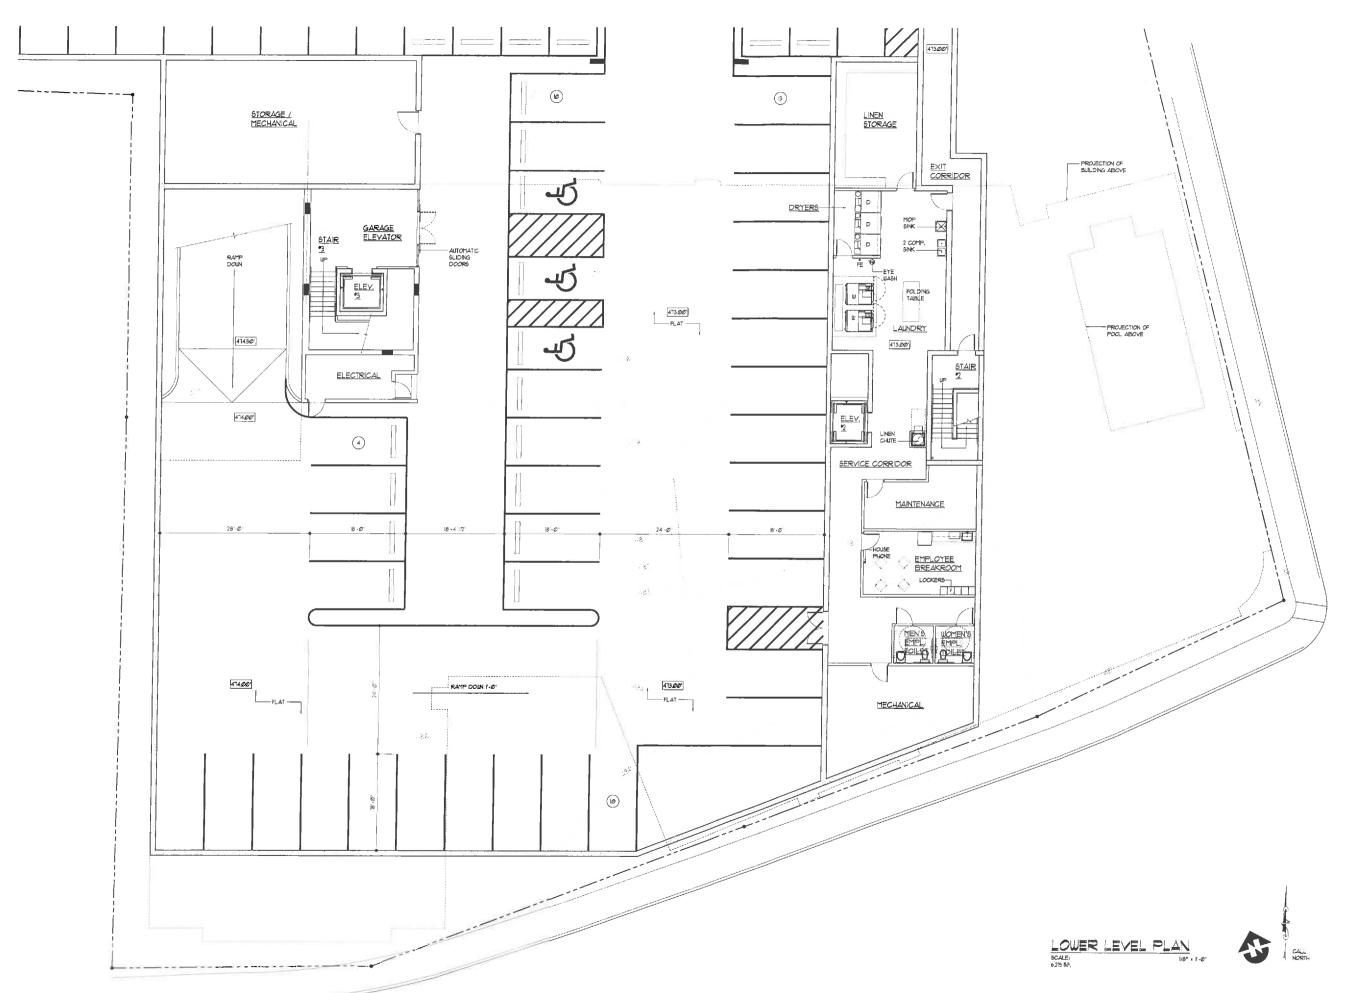
COVER SHEET WITH PROJECT DATA

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803 S. MOUNT MORIAH SUITE 100B MEMPHIS, TN 38117 (901) 683-7175 p. (901) 683-2385 f. Ilw@liwarchitects.com

ISSUED DATE

NO. REVISIONS DATE

VIOLATOR TO LEGAL PROSECT

CONSULTANTS

SEAL



CHARLOTTESVILLE, VIRGINIA SHEET NAME

> LOWER LEVEL PLAN

DATE 7/31/12

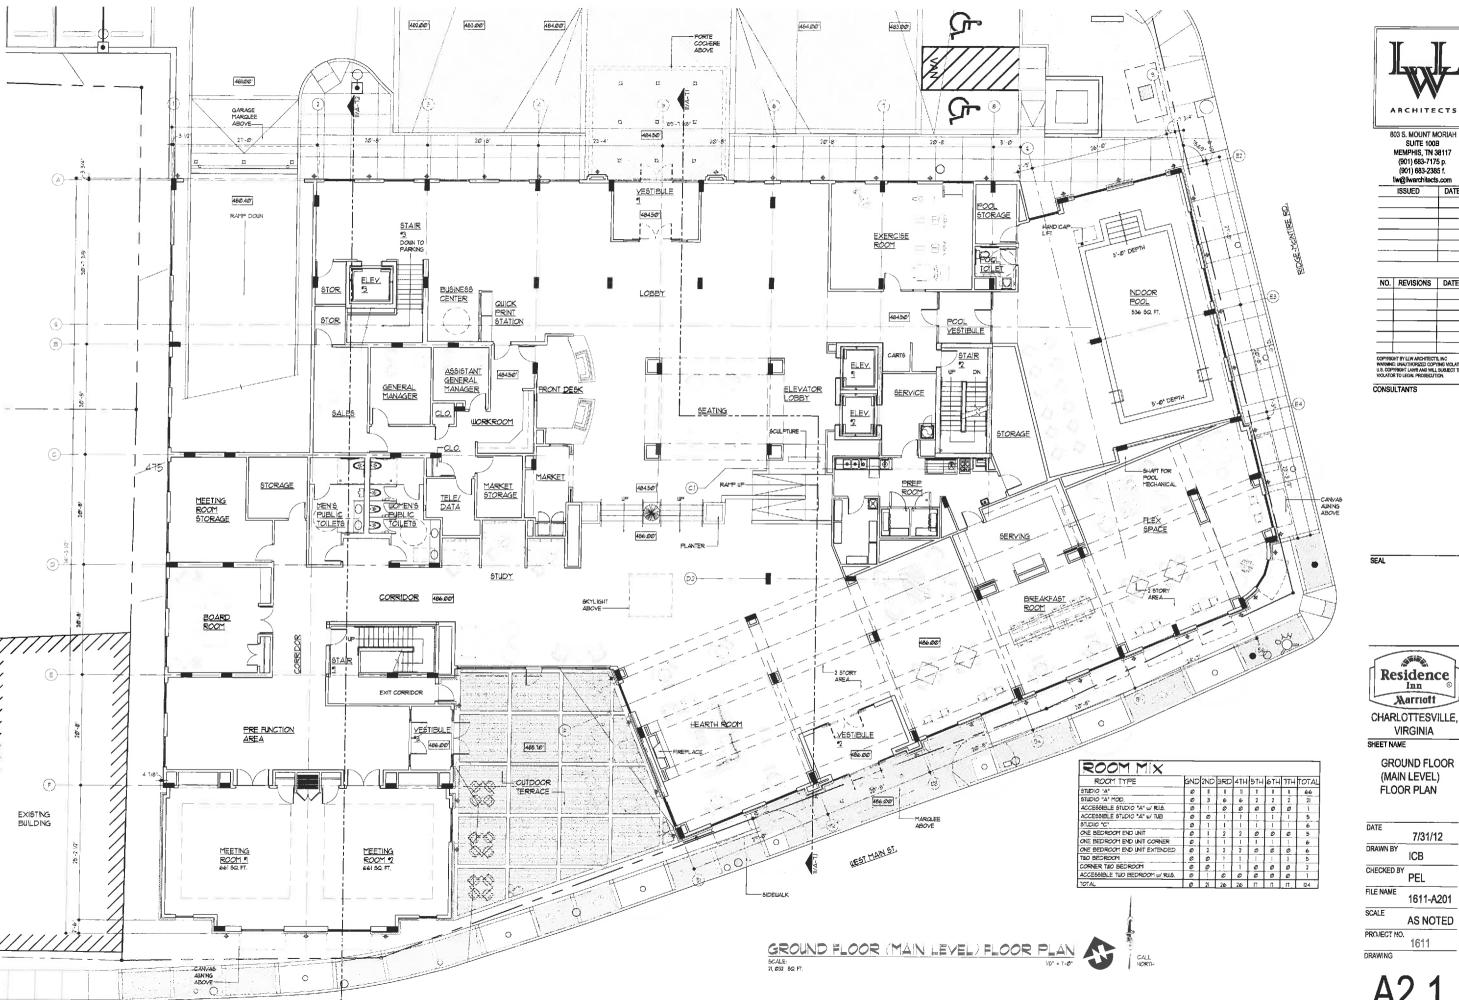
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SCALE AS NOTED

PROJECT NO. 1611



ARCHITECTS

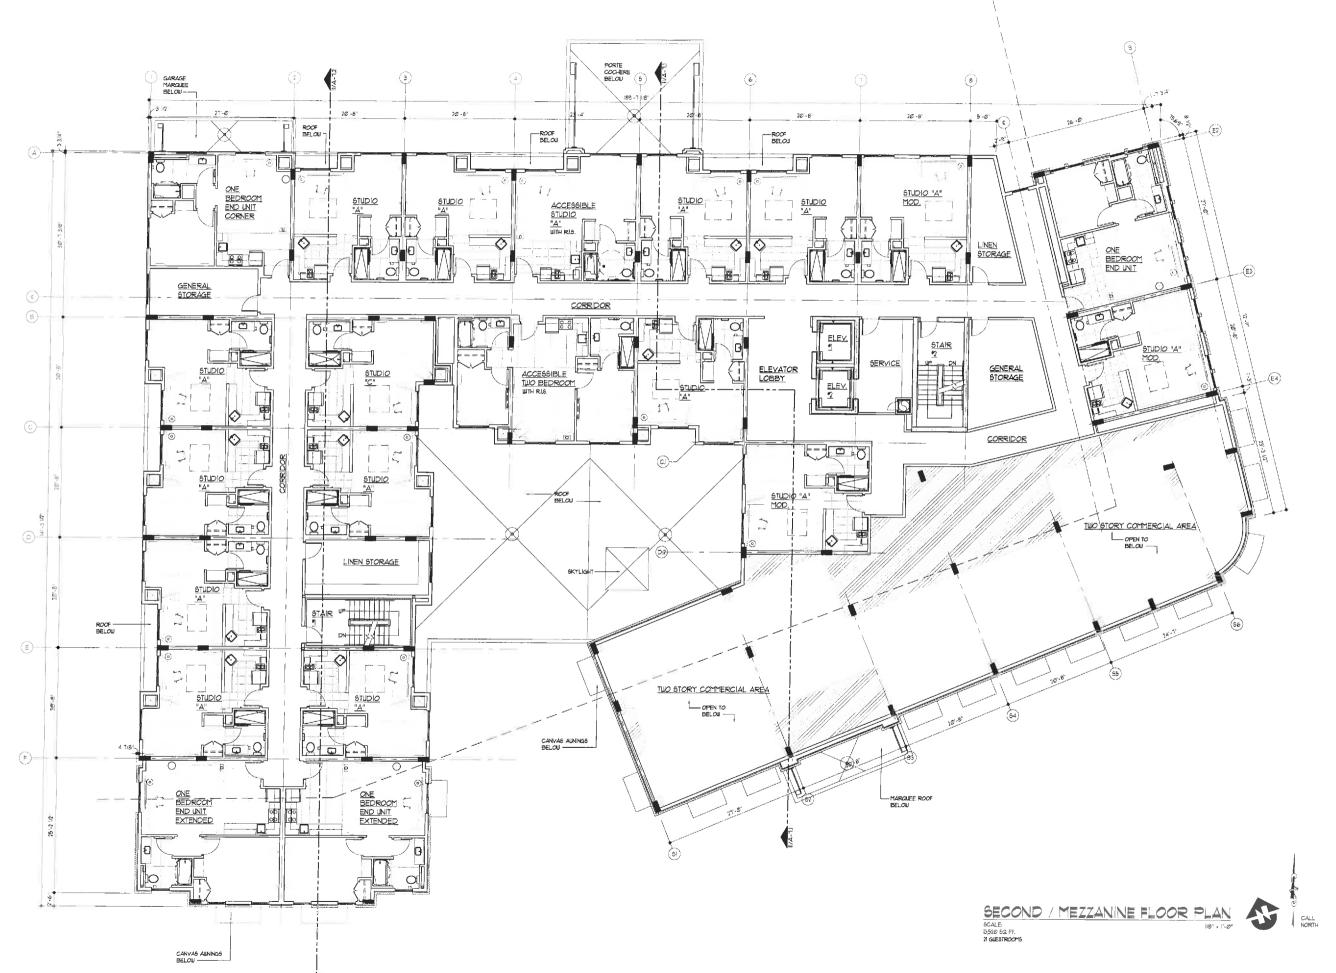
iw@iwarchitects.com		
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NO.	REVISIONS	DAT
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Residence

CHARLOTTESVILLE,

7/31/12 1611-A201 AS NOTED





803 S. MOUNT MORIAH SUITE 100B MEMPHIS, TN 38117 (901) 683-7175 p. (901) 683-2385 f.

Iw@Ilwarchitects.com
ISSUED DATE

NO. REVISIONS DATE

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CONSULTANTS

SEAL



CHARLOTTESVILLE, VIRGINIA

SECOND / MEZZANINE FLOOR PLAN

DATE 7/31/12

DRAWN BY ICB

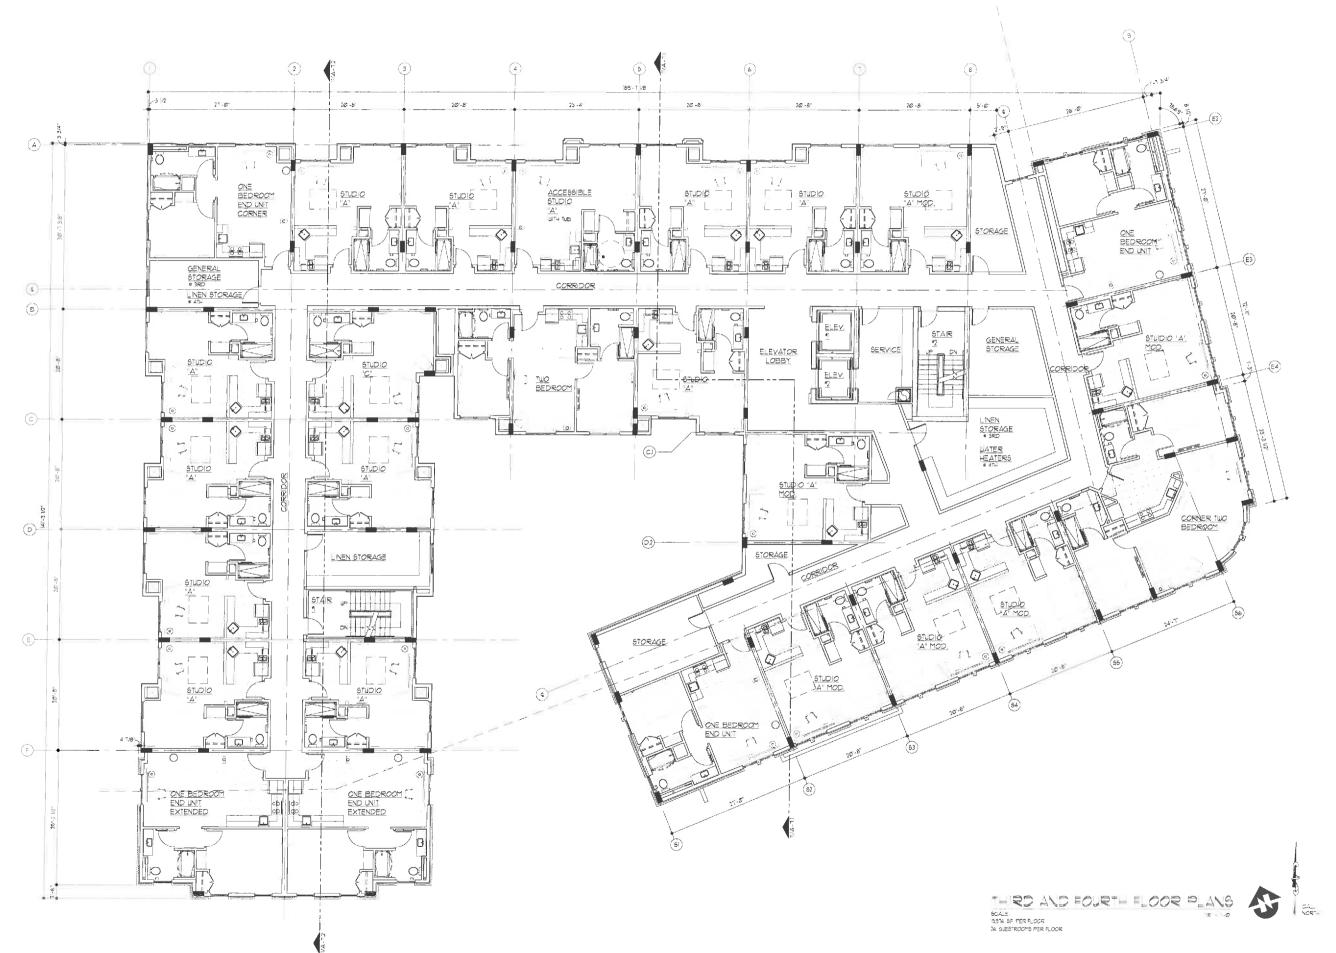
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FILE NAME 1611-A202

SCALE AS NOTED

PROJECT NO. 1611

DRAWING





803 S. MOUNT MORIAH SUITE 100B MEMPHIS, TN 38117 (901) 683-7175 p. (901) 683-2385 f. Ilw@llwarchitects.com

ISSUED DATE

NO. REVISIONS DATE

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CHARLOTTESVILLE, VIRGINIA SHEET NAME

THIRD AND FOURTH FLOOR PLANS

DATE 7/31/12

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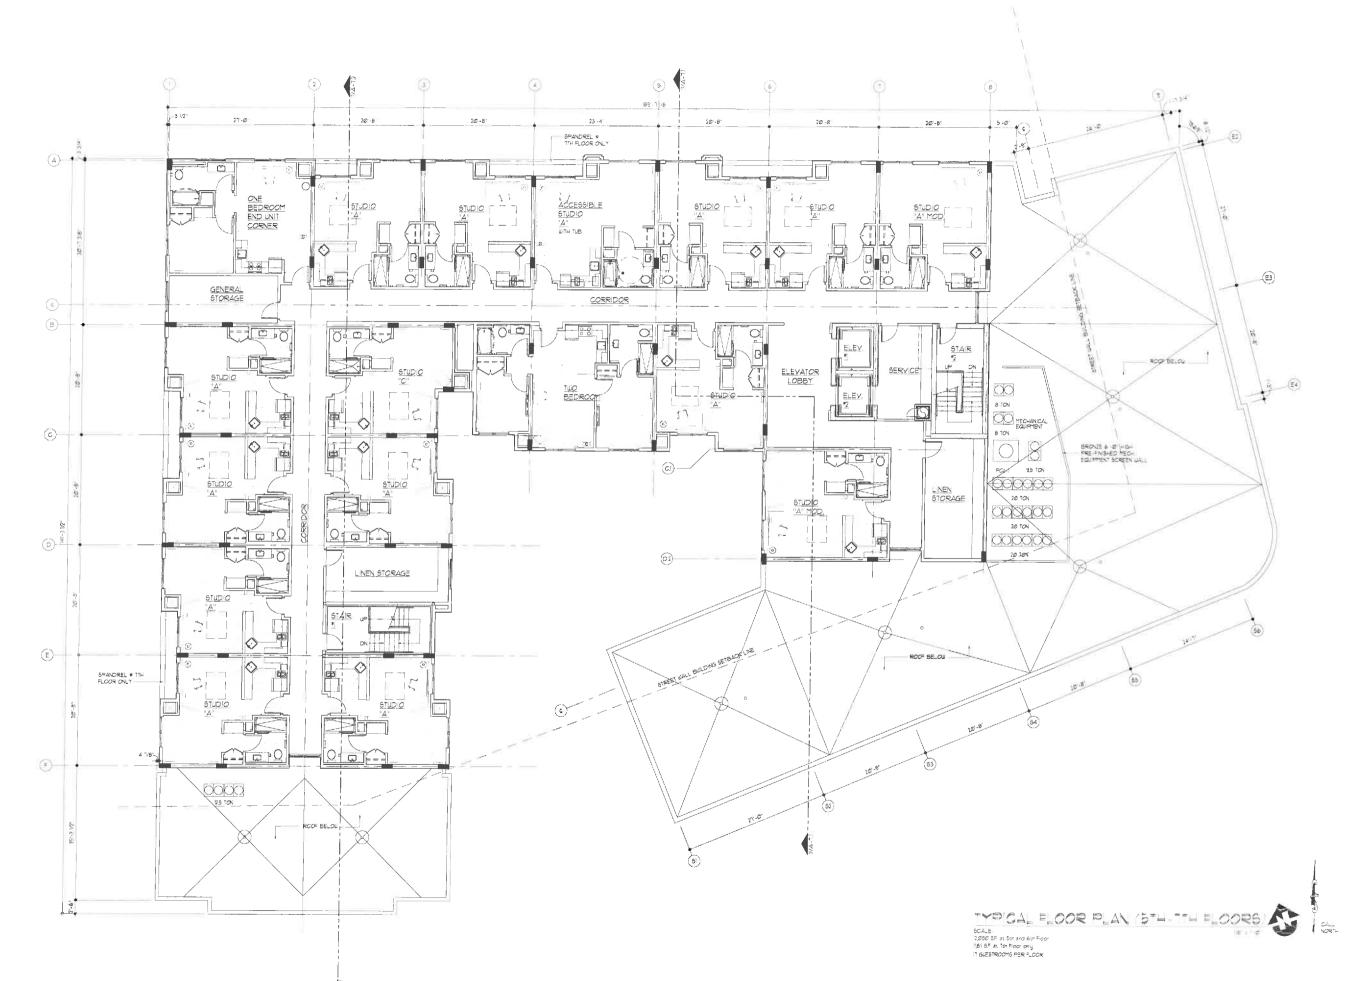
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CHARLOTTESVILLE, VIRGINIA SHEET NAME

> TYPICAL FLOOR PLAN (5TH-7TH) FLOORS

DATE 7/31/12

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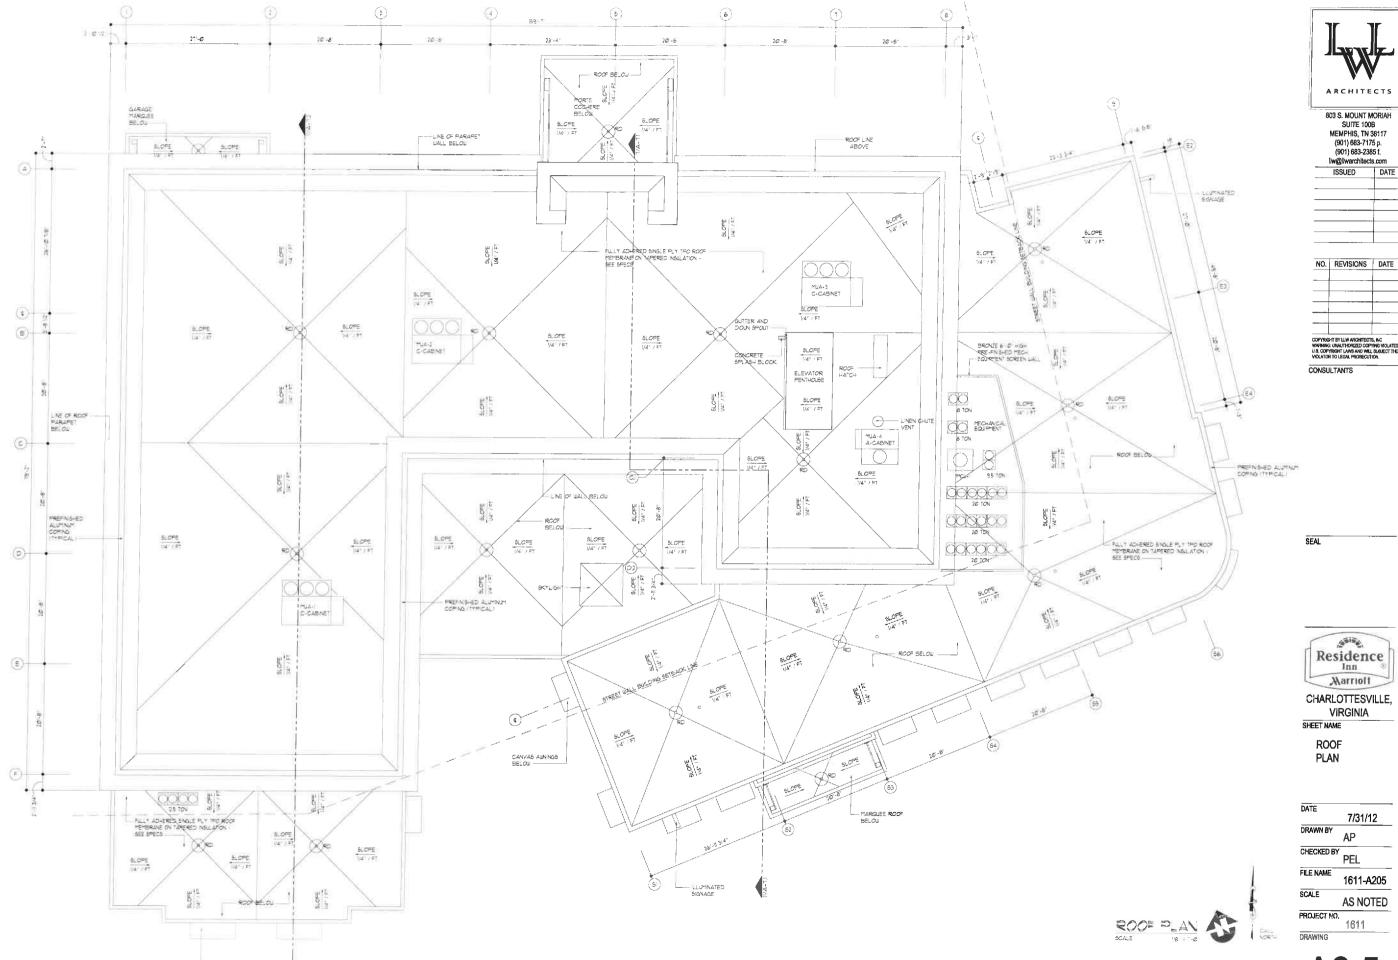
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ΕX	TERIOR FINISH SCHE	DULE	
BUILDING ELEMENT	MATERIAL	FINISH	COLOR
BUILDING SKIN	ARRISCRAFT RENAISSANCE STONE	SMOOTH	TAN
BUILDING SKIN	OLD VIRGINIA BRICK MODULAR	MOOD MOULD	COLONIAL RED RANGE
BUILDING SKIN	CEMENT STUCCO	5MOOTH	961 CLOUD WHITE- BENJAMIN MOORE
MORTAR	CEMENT	CONCAVE	IVORY BUFF- ARGOS MASONRY CEMENT
WINDOWS	ALLMINUM/QUAKER 8050 SH 8050 HISTORICAL	PRE-FIN.	DARK BRONZE
STOREFRONT	ALUMINUM/ KAUNEER	PRE-FIN.	DARK BRONZE
GLAZING	ANNEALED OR TEMPERED	LOW-E	CLEAR
MARQUEE	ALIMINUM	PRE-FIN.	DARK BRONZE
CANVAS AUNINGS	CANVAS	SMOOTH	BURGANDY
CEILINGS • RECESSED ENTRIES	STUCCO	HTOOME	TBD.
MECHANICAL LOUVERS	ALUMINUM	PRE-FIN.	COLOR TO MATCH ADJACENT SURFACE
HOLLOW METAL DOORS	HOLLOW METAL	PAINT	COLOR TO MATCH ADJACENT SURFACE
COPING, EXPOSED FLASHING	ALIMINIM	PRE-PIN.	COLOR TO MATCH ADJACENT SURFACE
LIGHT FIXTURES	ALUMINUM	PRE-FIN.	DARK BRONZE
FLAG POLES	ALUMINUM	PRE-FIN.	DARK BRONZE
TRELLIS . COURTYARD	ALUMINUM	PRE-HIN.	DARK BRONZE
BRICK PAVERS	OLD VIRGINIA BRICK	TAYLOR	1911 DARK RED LUGGED ITEM 17LR3

GRAPHIC	SCHEDULE	
	BRICK: OLD VIRGINIA BRICK MODULAR COLOR: COLONIAL RED RANGE FINISH: WOOD MOULD	
	STONE: ARRISCRAFT RENAISSANCE UNITS COLOR: TAN FINISH: SMOOTH	
	MORTAR ARGOS MASONRY CEMENT COLOR: IVORY BLIFT	
	STUCCO Benjay'in moore classic color: cloud white 961	4

	KEY LEGEND		
A	WINDOW KEY (SEE SHEET AS4)		
A	DOOR KEY (SEE SHEET A92)		
VAO.O	SECTION KEY (SEE SKEET NUM, INSIDE OF KEY)		
.	INDICATES HEIGHT ABOVE FINISH FLOOR (GRD. FLR.)		

SOUTH ELEVATION

EXTERIOR ELEVATIONS



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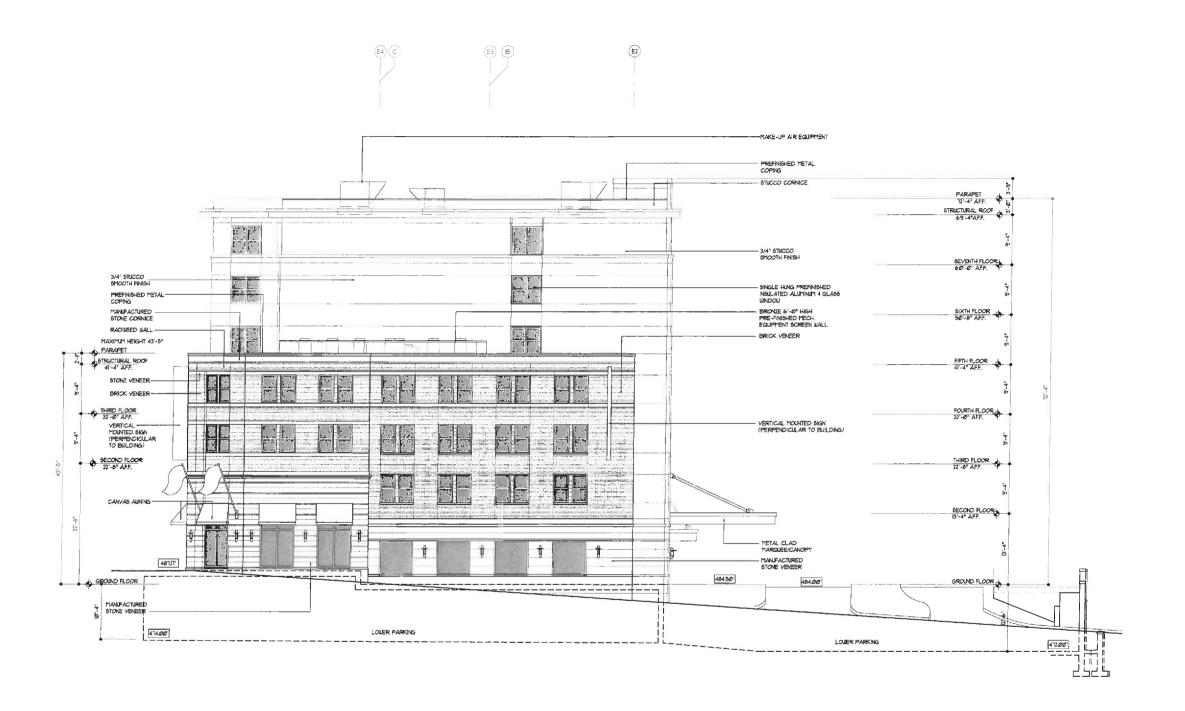
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CHARLOTTESVILLE, **VIRGINIA**

ELEVATIONS (ROTATED)

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EXTERIOR FINISH SCHEDULE			
BUILDING ELEMENT	MATERIAL	FINISH	COLOR
BUILDING SKIN	ARRISCRAFT RENAISSANCE STONE	SMOOTH	TAN
BUILDING SKIN	OLD VIRGINIA BRICK MODULAR	WOOD MOULD	COLONIAL RED RANGE
BUILDING SKIN	CEMENT STUCCO	HTOOMS	1961 CLOUD WHITE- BENJAMIN MOORE
MORTAR	CEMENT	CONCAVE	IVORY BUFF- ARGOS MASONRY CEMENT
WINDOWS	ALUMINUM/QUAKER 8050 SH 8050 HISTORICAL	PRE-FIN.	DARK BRONZE
STOREFRONT	ALUMINUM/ KAUNEER	PRE-FIN.	DARK BRONZE
GLAZING	ANNEALED OR TEMPERED	LOW-E	CLEAR
MARQUEE	ALUMNUM	PRE-FIN.	DARK BRONZE
CANYAS AUNINGS	CANVAS	SMOOTH	BURGANDY
CEILINGS . RECESSED ENTRIES	STUCCO	SMOOTH	TBD.
MECHANICAL LOUVERS ALUMINUM		PRE-FIN.	COLOR TO MATCH ADJACENT SURFACE
HOLLOW METAL DOORS	HOLLOW METAL	PAINT	COLOR TO MATCH ADJACENT SURFACE
COPING, EXPOSED FLASHING	ALIMNIM	PRE-FIN.	COLOR TO MATCH ADJACENT SURFACE
LIGHT FIXTURES	ALIMNIM	PRE-FIN.	DARK BRONZE
LAG POLES	ALUMINUM	PRE-FIN.	DARK BRONZE
RELLIS O COURTY ARD	ALUMINUM	PRE-FIN.	DARK BRONZE
BRICK PAVERS	OLD VIRGINIA BRICK	TAYLOR CLAY 4"X8"	1911 DARK RED LUGGED ITEM TLR3

BRICK : OLD VIRGINIA BRICK MODULAR COLOR: COLONIAL RED RANGE FNISH: WOOD MOULD
STONE: ARRISCRAFT RENAISSANCE UNITS COLOR: TAN FINISH: SMOOTH
MORTAR ARGOS MAGONRY CEMENT COLOR: IVORY BUFF
STUCCO BENJAMIN INCORE CLASSIC

	KEY LEGEND
Δ	WINDOW KEY (SEE SHEET A9.4)
(A)	DOOR KEY (SEE SHEET A32)
VAO.O	SECTION KEY (SEE SHEET MUM, INSIDE OF KEY)
•	INDICATES HEIGHT ABOVE FINISH FLOOR (GRD. FLR.)

EAST ELEVATION

EXTERIOR ELEVATIONS SCALE: 1/0" = 1'-0"



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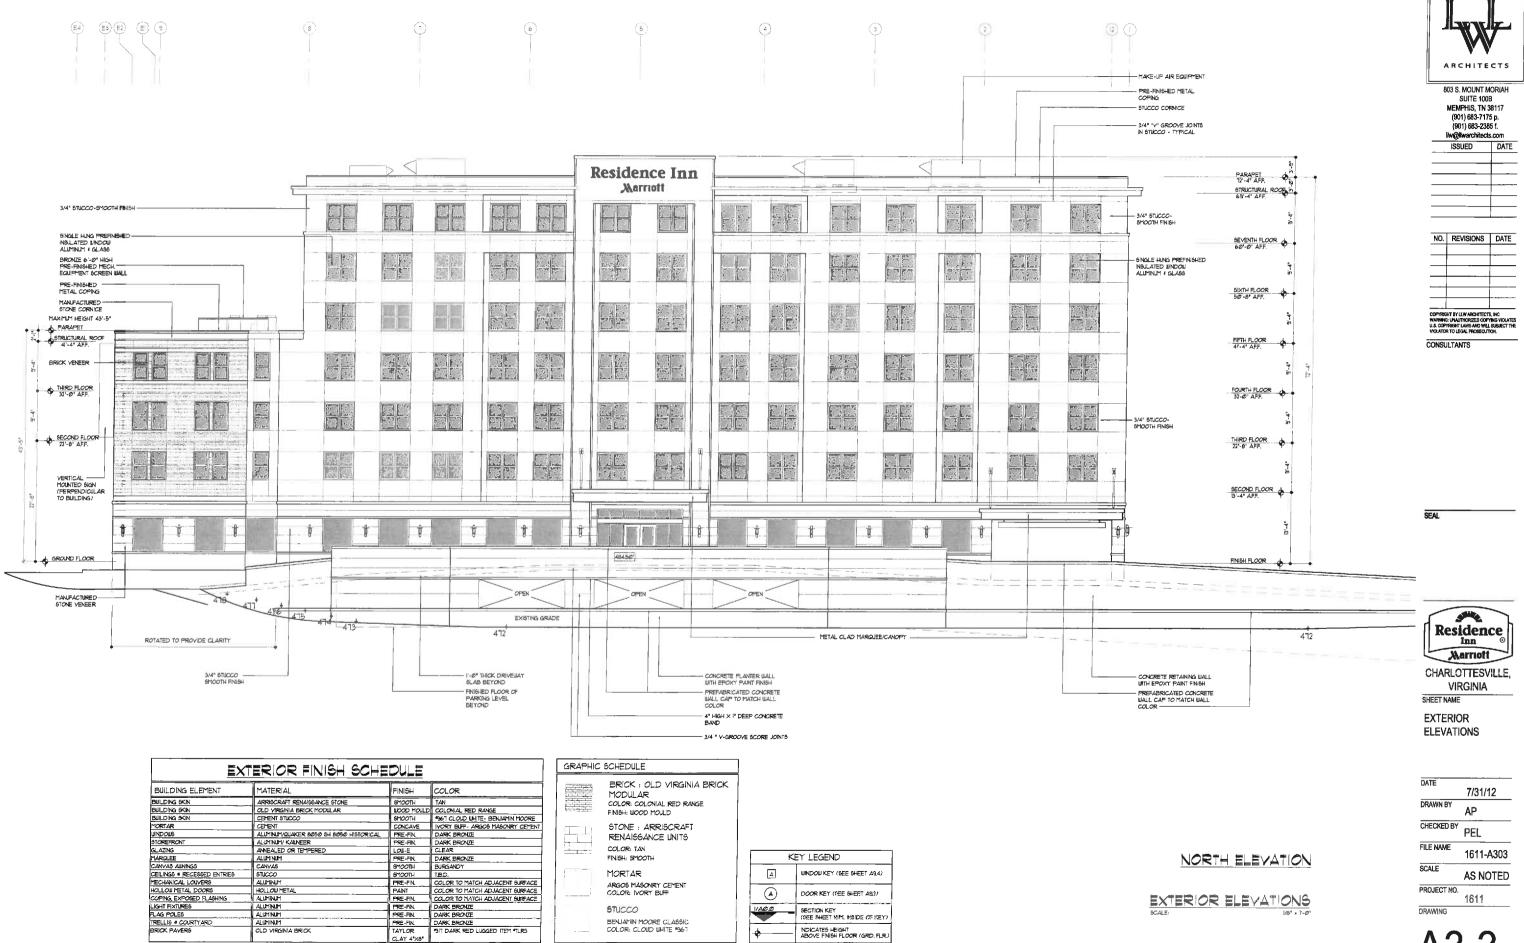
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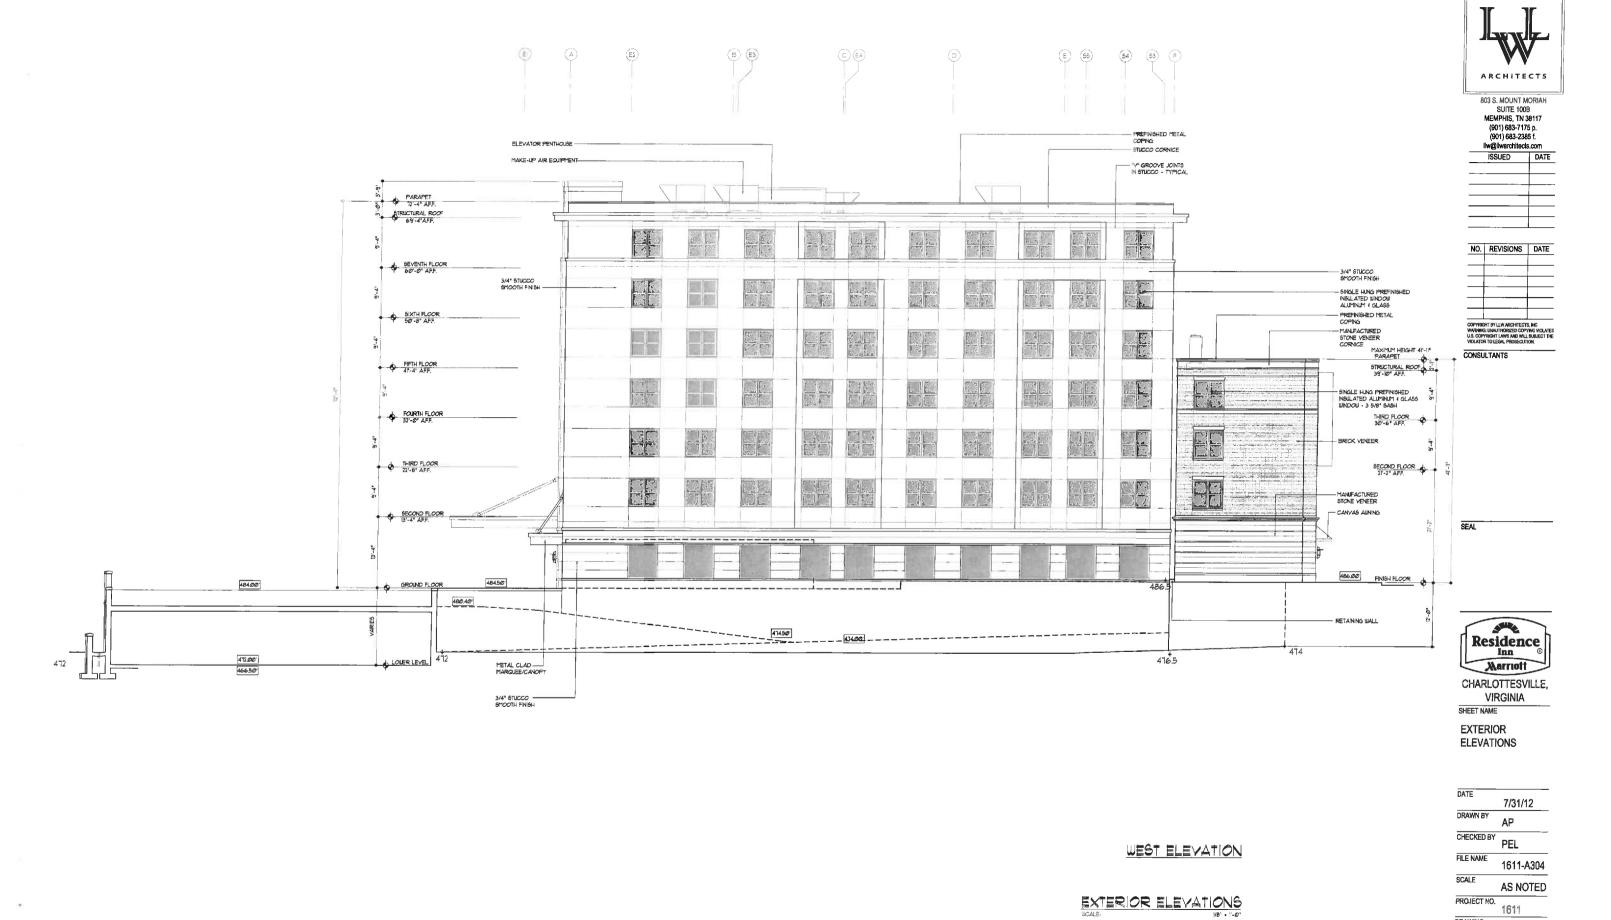
EXTERIOR **ELEVATIONS**

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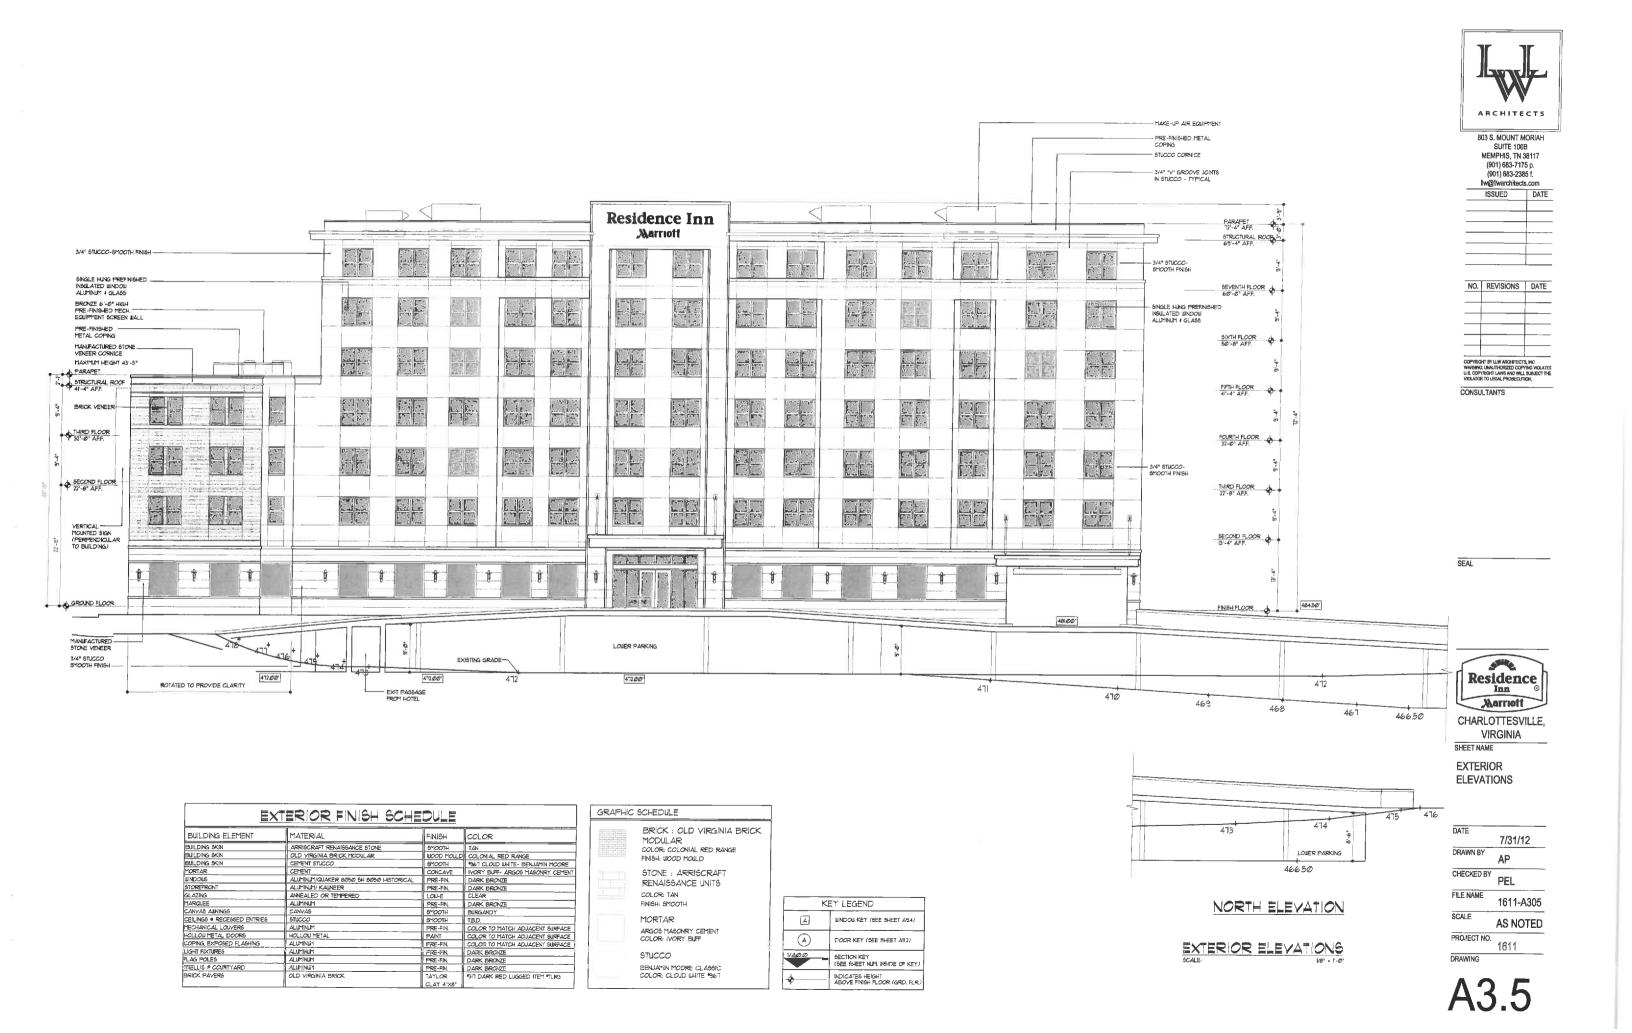
A3.2

DRAWING





A3.4





GRAPHIC SCHEDULE

BRICK: OLD VIRGINIA BRICK

KEY LEGEND

(A)

WINDOW KEY (SEE SHEET A9.4)

DOOR KEY (SEE SHEET A92)

SECTION KEY (SEE SHEET NUM, INSIDE OF KEY)

INDICATES HEIGHT ABOVE FINISH FLOOR (GRD, FLR.)

MODULAR COLOR: COLONIAL RED RANGE

STONE : ARRISCRAFT

RENAISSANCE UNITS

ARGOS MASONRY CEMENT COLOR: IVORY BUFF

BENJAMIN MOORE CLASSIC COLOR: CLOUD WHITE *361

FINISH: WOOD MOULD

COLOR: TAN

MORTAR

STUCCO

FINISH: SMOOTH

EXTERIOR FINISH SCHEDULE

CEMENT ALLMINIM/QUAKER 8050 SH 8050 HISTORICAL ALLMINIM/ KAUNEER

ARRISCRAFT RENAISSANCE STONE
OLD VIRGINIA BRICK MODULAR
CEMENT STUCCO

ANNEALED OR TEMPERED
ALUMINUM
CANYAS

ALUMINUM
ALUMINUM
ALUMINUM
ALUMINUM
ALUMINUM
ALUMINUM
ALUMINUM
OLD VIRGINIA BRICK

FINISH

COLOR

WOOTH HOLD COVERED FOR ANY COME.

SOFT CLODE WHITE: BENUATIN MOORE
CONCAVE

IVORY BUFF- ARGOS MASONRY CEMENT
PRE-FIN

DARK BRONZE

LOU-E

CLEAR

9MOOTH TBD.
PRE-FIN COLOR TO MATCH ADJACENT SURFACE
PAINT COLOR TO MATCH ADJACENT SURFACE

PAINT COLOR TO MATCH ADJACENT SURFACE
PRE-FIN COLOR TO HATCH ADJACENT SURFACE
PRE-FIN DARK BRONZE
PRE-FIN DARK BRONZE
PRE-FIN DARK BRONZE
TAYLOR
5TI DARK RED LUSGED ITEM TURS

DARK BRONZE BURGANDY

SMOOTH TAN WOOD MOULD COLONIAL RED RANGE

MATERIAL

STUCCO

BUILDING ELEMENT

MARQUEE
CANVAS AUNINGS
CEILINGS • RECESSED ENTRIES

MECHANICAL LOUVERS HOLLOW METAL DOORS COPING, EXPOSED FLASHING

LIGHT FIXTURES
FLAG POLES
TRELLIS * COURTYARD
BRICK PAVERS

BUILDING SKIN

BUILDING SKIN BUILDING SKIN MORTAR

GLAZING

ARCHITECTS

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VIRGINIA SHEET NAME

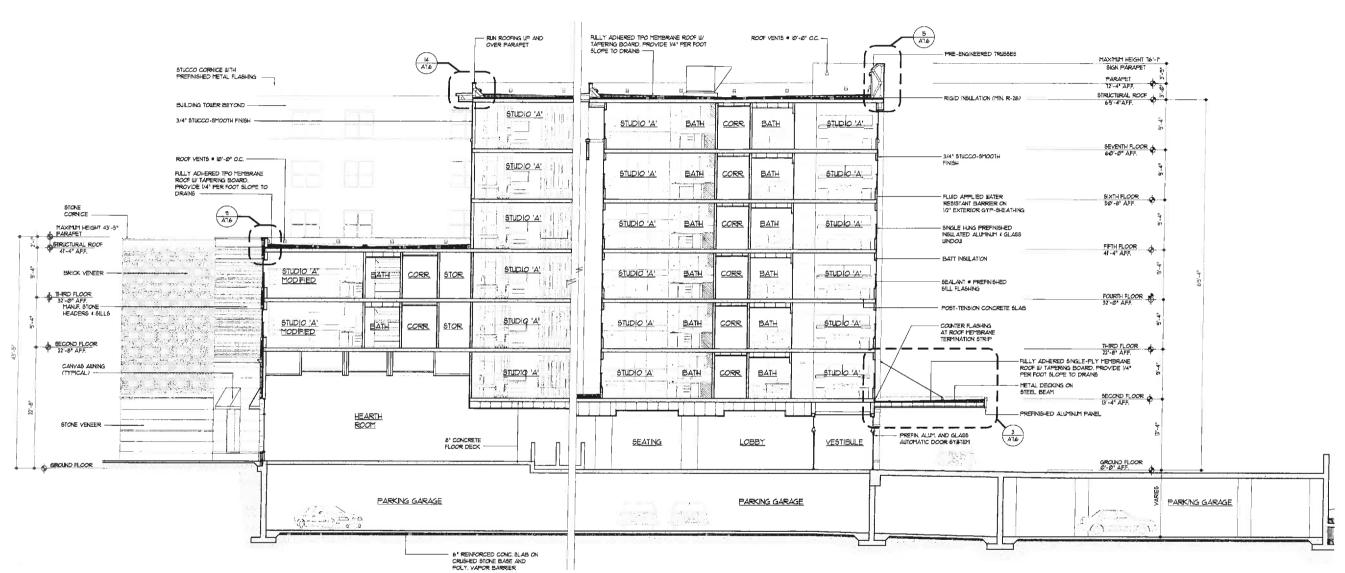
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A3.6





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CHARLOTTESVILLE, VIRGINIA SHEET NAME

BUILDING SECTION

BUILDING SECTION VB. 1-0"

DATE 7/31/12

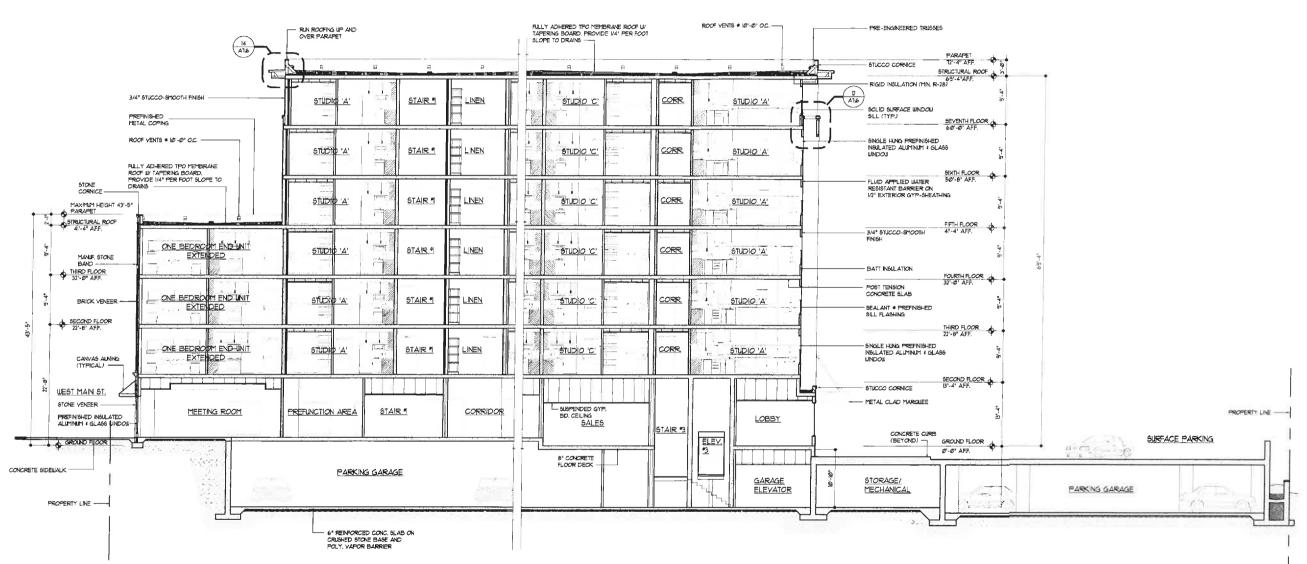
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CHARLOTTESVILL VIRGINIA SHEET NAME

BUILDING SECTION

BUILDING SECTION SCALE: 1/8' - 1'-0" DATE 7/31/12

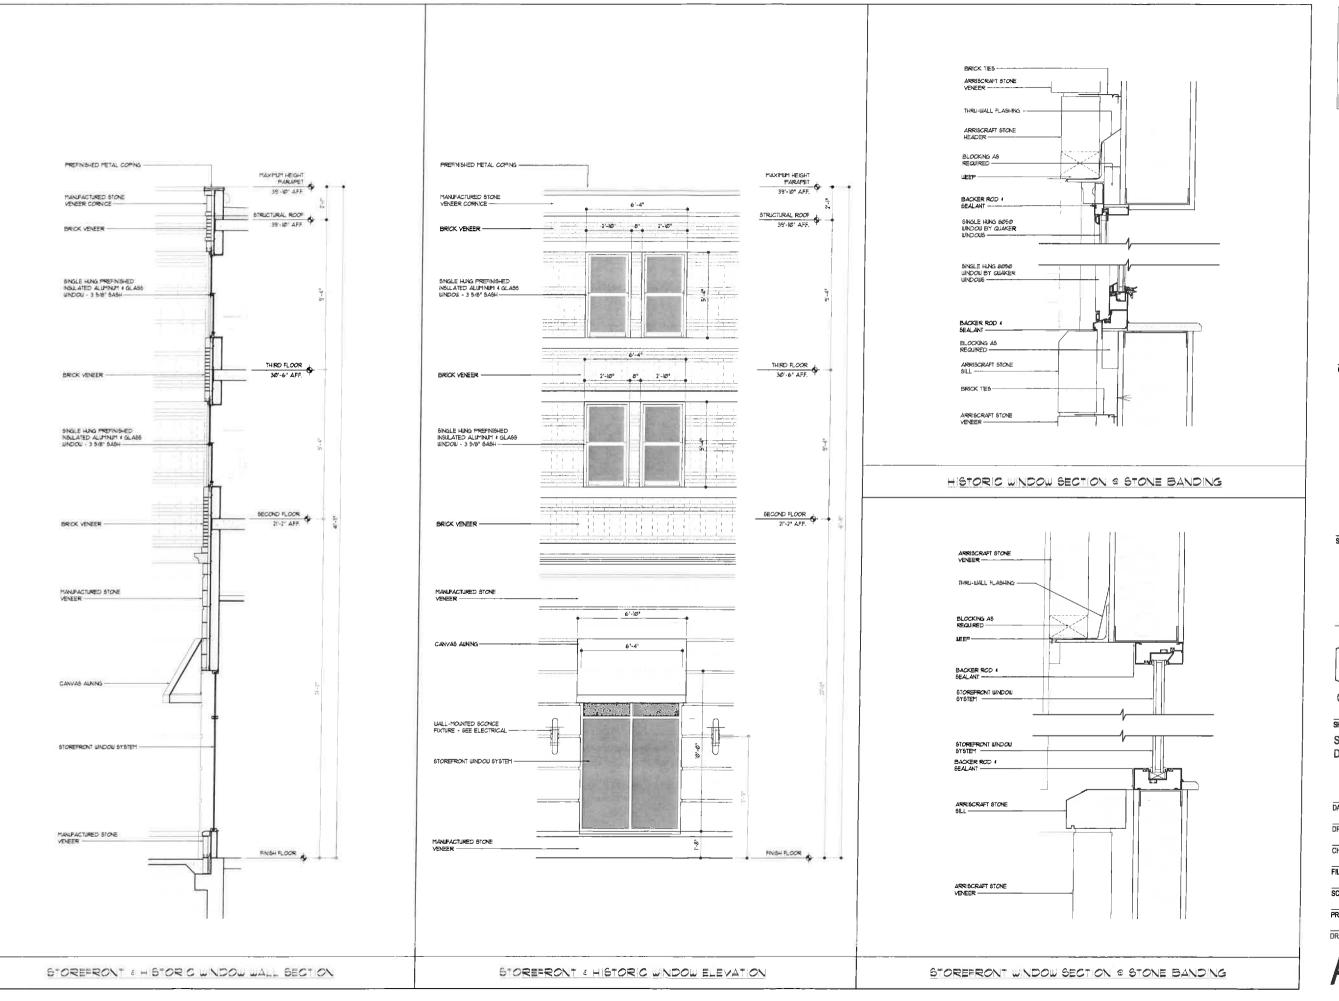
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FILE NAME 1611-A702

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SHEET NAME
SECTION
DETAILS

DATE 7/31/12

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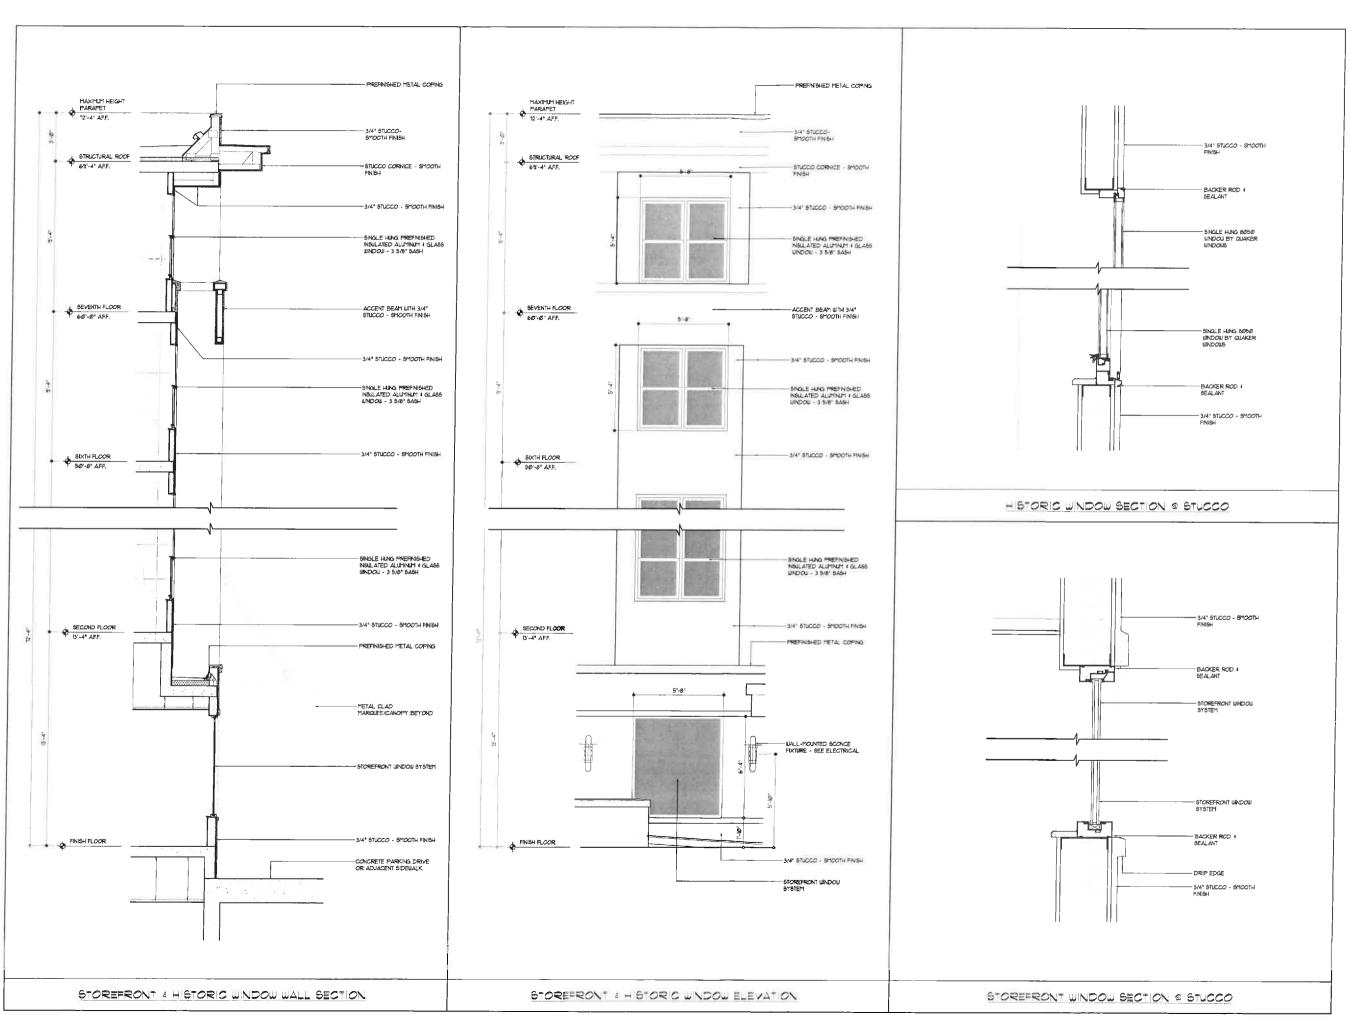
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CHARLOTTESVILLE, VIRGINIA SHEET NAME

SECTION DETAILS

DATE 7/31/12

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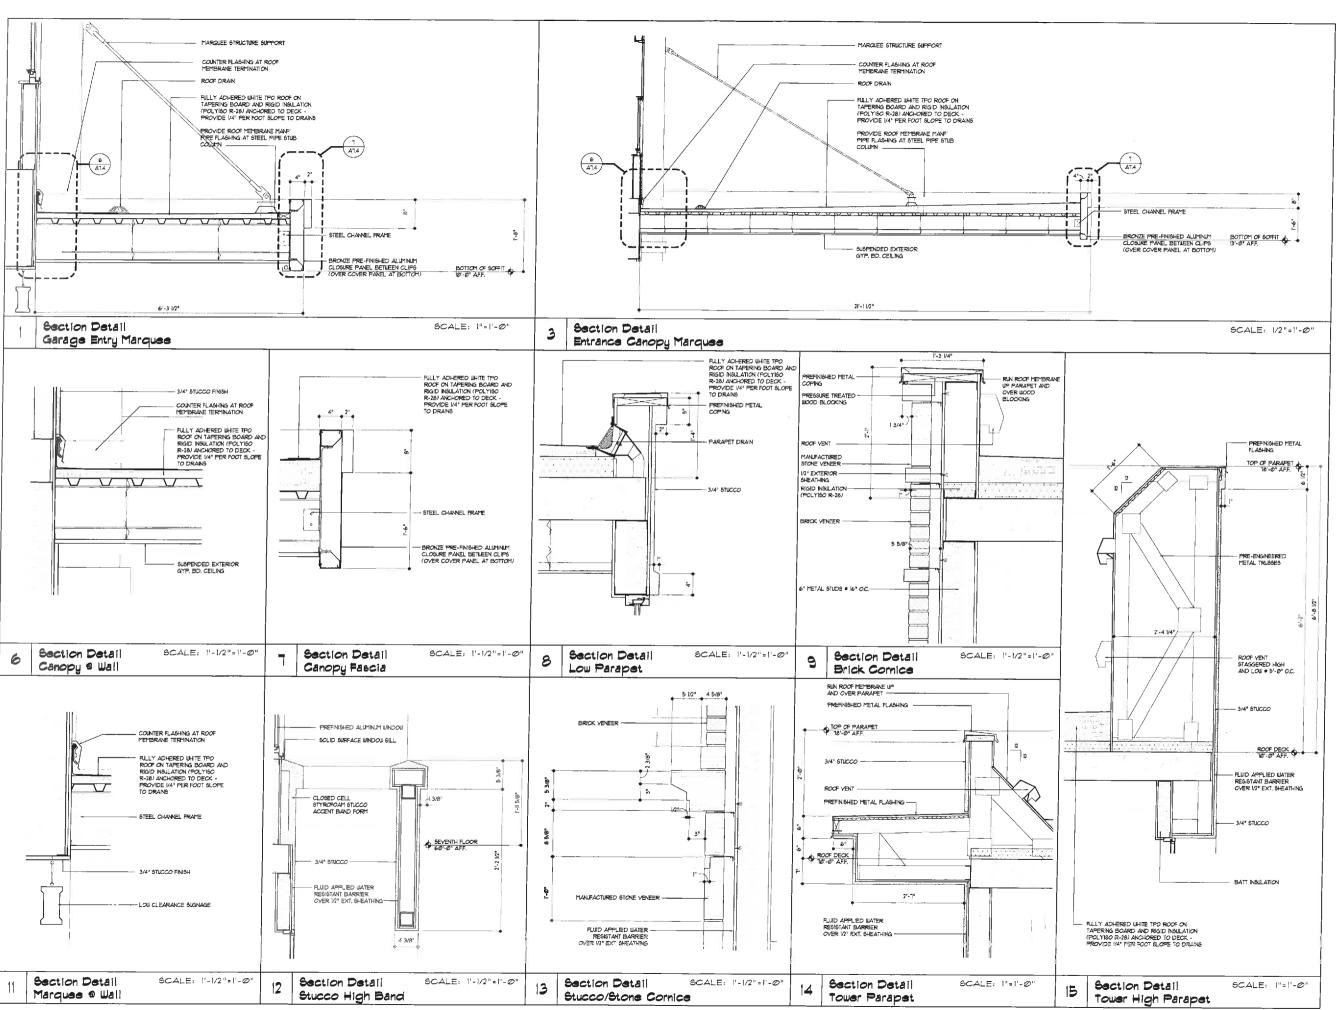
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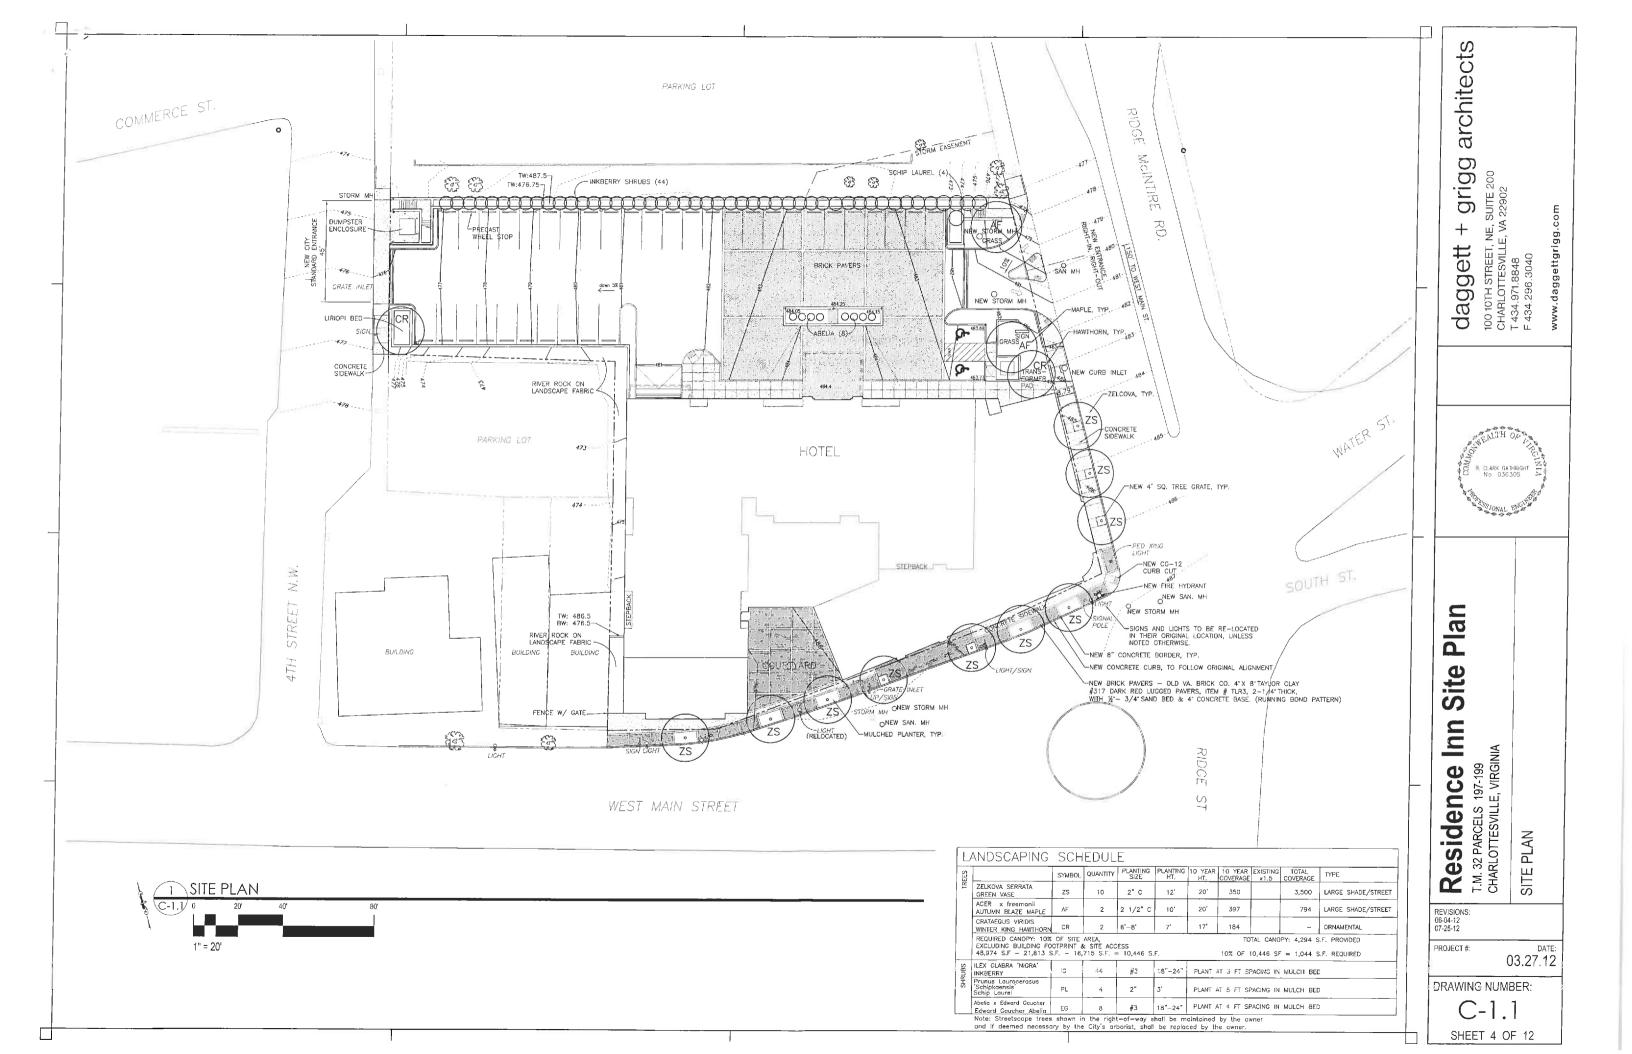
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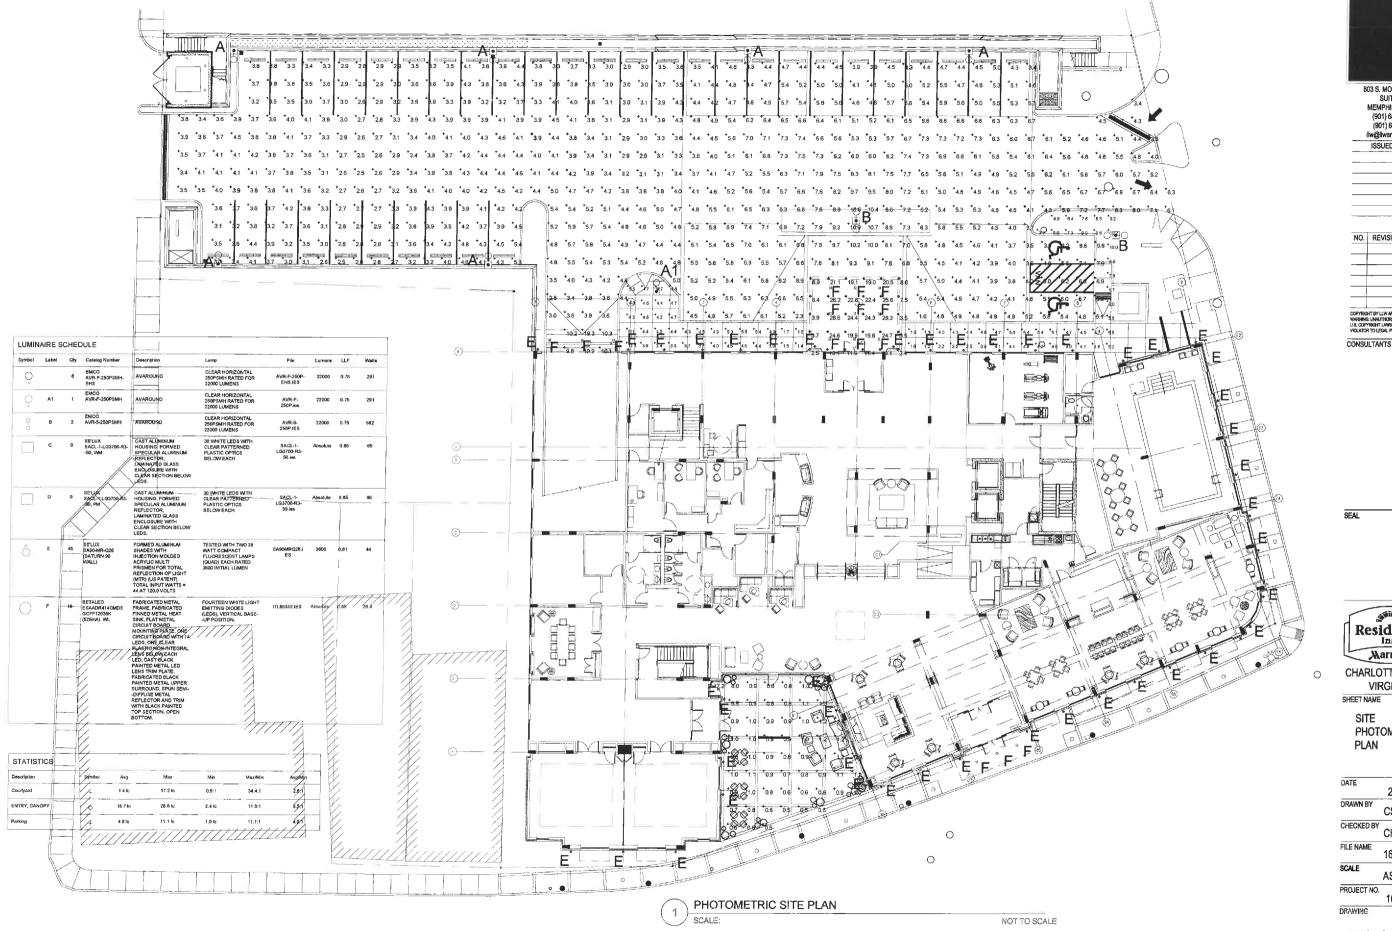


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SECTION DETAILS

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CHARLOTTESVILLE, VIRGINIA

SHEET NAME

SITE PHOTOMETRIC PLAN

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CHARLOTTESVILLE, VIRGINIA

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Aerial view looking north from Ridge St.

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View from West Main/Ridge St. intersection

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View from West Main St.



Courtyard View from West Main St.

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View looking south on Fourth St.



October 30, 2012 Page 7 of 9

View from northeast



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View looking south on Ridge St.



View looking west from Water St.

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