From: Scala, Mary Joy

**Sent:** Wednesday, May 30, 2012 4:42 PM **To:** Gathright, Clark (cgathright@dgarchs.com)

**Cc:** 'Vlong@williamsmullen.com' **Subject:** FW: 315 W Main Street

May 30, 2012

Clark Gathright 100 10<sup>th</sup> Street NE Suite 200 Charlottesville, VA 22902

#### **Certificate of Appropriateness Application**

BAR 12-05-03 315 W Main Street Tax Map 32 Parcels 197 and 198 Clark Gathright, Applicant/VIM, Inc., Owner New 7-story hotel

Dear Applicant,

The above referenced project was discussed before a meeting of the City of Charlottesville Board of Architectural Review (BAR) on May 15, 2012.

The following action was taken:

The BAR accepted (6-0-1) the applicant's request for deferral. The BAR requested further details on: the materials, wall sections, windows details, cornices, articulation of façades, lighting (cut sheets and photometrics), paving materials. Look at the plans along West Main Street. Do not necessarily propose white windows; part of the building may want to be monochromatic.

If you have any questions, please contact me at 434-970-3130 or scala@charlottesville.org.

Sincerely yours,

Mary Joy Scala, AICP
Preservation and Design Planner

#### Mary Joy Scala, AICP

Preservation and Design Planner
City of Charlottesville
Department of Neighborhood Development Services
City Hall - 610 East Market Street
P.O. Box 911
Charlottesville, VA 22902
Ph 434.970.3130 FAX 434.970.3359
scala@charlottesville.org

### CITY OF CHARLOTTESVILLE BOARD OF ARCHITECTURAL REVIEW STAFF REPORT May 15, 2012



Certificate of Appropriateness Application

BAR 12-05-03
315 W Main Street
Tax Map 32 Parcels 197 and 198
Clark Gathright, Applicant/VIM, Inc., Owner
New 7-story hotel

#### **Background**

301 West Main Street (c. 1957) and 315 West Main Street (c. 1938; 1947; 1951) are located in the Downtown ADC District.

October 18, 2005 - BAR approves (8-0) demolition of 301 West Main Street. The applicant requested deferral of the 315 West Main Street application in order to have prepared a structural report.

November 15, 2005 - BAR approves (7-2) demolition of 315 West Main Street

<u>September 18, 2006</u> - The Director of Neighborhood Development Services agreed to extend both certificates of appropriateness for one year as permitted by Sec. 34- 280 because the building tenant (RSC equipment rental) exercised their option to renew their lease for another year.

November 28, 2006 – BAR denied (9-0) CVS project based on standards and guidelines especially site plan, massing, scale, and materials.

October 16, 2007 - BAR approves (7-0) demolition of both buildings on consent agenda.

<u>July 15, 2008</u> – BAR approved (6-2) a new mixed-use project including the concept of the massing, general articulation, and disposition of materials, but required the details to be re-studied and returned to the BAR for further approval.

<u>September 25, 2008</u> - The Director of Neighborhood Development Services agreed to extend both demolition approvals for one year, until October 16, 2009.

May 19, 2009 - The BAR approved (8-1) the application for demolition of 301 and 315 West Main Street and asked staff to report back next month regarding the City Attorney's opinion as to when the permit will expire. (The applicant asked the BAR if the one-year approval could begin in October 2009, when the previous permit would expire, rather than the meeting date.) The City Attorney's opinion was that the permit would expire one year from the meeting date, or May 19, 2010.

<u>June 15, 2010</u>- The BAR approved demolition of 301 W Main (8-0); approved demolition of 315 W Main (6-2 with Brennan and Schoenthal opposed).

<u>June 15, 2011</u> - The Director of Neighborhood Development Services agreed to extend the validity of the COA for one year, or until June 15, 2012.

<u>February 21, 2012</u> – The BAR was generally supportive of the preliminary proposal. Suggestions made were to wrap the corner of Building C with Building B; landscaping and screening parking are important; pedestrian access to Main Street is important; give thought to courtyard (trees, access to hotel).

This property is located in the Downtown ADC District. The Guidelines describe the West Main Street sub-area as: increasingly vital commercial district with strong definition of the street edge and moderate pedestrian activity typically medium scaled, turn of the century masonry structures, generally mixed use with commercial/service below and residential above, street parking with small off street lots.

The current zoning is *Downtown Corridor* Mixed Use District, which requires a minimum height of 45 feet and allows a maximum height of 70 feet with stepback requirements. Up to 101 feet may be permitted with a special use permit. The parking zone is "Parking Modified Zone"

The minimum height of the streetwall must be 40 feet, and the maximum height of the streetwall must be 45 feet, containing exactly 3 interior floors. After 45 feet, there shall be a minimum stepback of 25 feet. At least 75% of the streetwall must be built to the property line adjacent a primary street (both Ridge-McIntire and West Main are primary streets). Up to 25% of the streetwall may be set back a maximum of 20 feet, except up to 50% may be set back up to 20 feet if streetscape trees are provided, or if City Council approves a special use permit.

#### **Application**

The applicants seeks approval for a new project on this site, a seven-story hotel with 133 rooms and parking for 122 vehicles, including one level of structured parking (87 spaces) and a surface parking lot (35 spaces). The surface parking lot and the drive-up lobby entrance are accessed from both Ridge-McIntire and 4<sup>th</sup> Street NW entrance/exits.

The West Main Street frontage includes a commercial area (Building A) and a hotel restaurant area with "flex" area (Building B), both with tall ceiling heights, and an interior courtyard. The top two floors of these three-story buildings are hotel rooms. On the Ridge-McIntire frontage there are windows that look into the "flex' area, but become raised above eye-level in the pool area. The top three floors along Ridge-McIntire are hotel rooms.



Two entrances are proposed along West Main Street, in the center of Building A and near the center of Building B. New pedestrian entrances to the hotel have been added from the landscaped courtyard that connects to West Main Street. Since the preliminary discussion, Buildings A and B have been connected above the courtyard entrance. There are no pedestrian entrances along Ridge-McIntire.

The rear section of the hotel (Building C) is 7 stories in height. There is a drive-up/pedestrian entrance under a porte-cochere in the parking lot.



The building materials are manufactured stone veneer, brick veneer, brick cornice (Building A), fiberglass cornice (on base and on Building B), 3/4" stucco - smooth finish (Building C), single-hung aluminum windows, canvas awnings, some brick in-filled window openings.

### Criteria and Guidelines Review Criteria Generally

Sec. 34-284(b) of the City Code states that,

In considering a particular application the BAR shall approve the application unless it finds:

(1) That the proposal does not meet specific standards set forth within this division or applicable provisions of the Design Guidelines established by the board pursuant to Sec.34-288(6); and

(2) The proposal is incompatible with the historic, cultural or architectural character of the district in which the property is located or the protected property that is the subject of the application.

#### Pertinent Standards for Review of Construction and Alterations include:

- (1) Whether the material, texture, color, height, scale, mass and placement of the proposed addition, modification or construction are visually and architecturally compatible with the site and the applicable design control district;
- (2) The harmony of the proposed change in terms of overall proportion and the size and placement of entrances, windows, awnings, exterior stairs and signs;
- (3) The Secretary of the Interior Standards for Rehabilitation set forth within the Code of Federal Regulations (36 C.F.R. §67.7(b)), as may be relevant;
- (4) The effect of the proposed change on the historic district neighborhood;
- (5) The impact of the proposed change on other protected features on the property, such as gardens, landscaping, fences, walls and walks;
- (6) Whether the proposed method of construction, renovation or restoration could have an adverse impact on the structure or site, or adjacent buildings or structures;
- (8) Any applicable provisions of the City's Design Guidelines.

#### Pertinent Design Review Guidelines for New Construction

#### P. 3.3

e. Multi-lot

Often new commercial, office, or multiuse buildings will be constructed on sites much larger than the traditionally sized lots 25 to 40 feet wide. Many sites for such structures are located on West Main Street and in the 14th and 15th Street area of Venable neighborhood. These assembled parcels can translate into new structures whose scale and mass may overwhelm neighboring existing structures. Therefore, while this building type may need to respond to the various building conditions of the site, it also should employ design techniques to reduce its visual presence. These could include varying façade wall planes, differing materials, stepped-back upper levels, and irregular massing.

#### P. 3.4 Setback

- 1. Construct new commercial buildings with a minimal or no setback in order to reinforce the traditional street wall.
- 8. At transitional sites between two distinctive areas of setback, for instance between new commercial and historic commercial, consider using setbacks in the new construction that reinforce and relate to setbacks of the historic buildings.

#### P. 3.5 Spacing

- 2. Commercial and office buildings in areas that have a well-defined street wall should have minimal spacing between them.
- 3. In areas that do not have consistent spacing, consider limiting or creating a more uniform spacing in order to establish an overall rhythm.
- 4. Multi-lot buildings should be designed using techniques to incorporate and respect the existing spacing on a residential street.

#### P. 3.6 Massing & Footprint

4.Institutional and multilot buildings by their nature will have large footprints, particularly along the West Main Street corridor and in the 14th and 15th Street area of Venable Neighborhood.

- a. The massing of such a large scale structure should not overpower the traditional scale of the majority of nearby buildings in the district in which it is located.
- b. Techniques could include varying the surface planes of the building, stepping back the buildings as the structure increases in height, and breaking up the roof line with different elements to create smaller compositions.

#### P. 3.7 Height and Width

- 2. Attempt to keep the height and width of new buildings within a maximum of 200 percent of the prevailing height and width in the surrounding sub-area.
- 4. When the primary façade of a new building in a commercial area, such as downtown, West Main Street, or the Corner, is wider than the surrounding historic buildings or the traditional lot size, consider modulating it with bays or varying planes.

#### P. 3.8 Scale and Orientation

1. Provide features on new construction that reinforce the scale and character of the surrounding area, whether human or monumental. Include elements such as storefronts, vertical and horizontal divisions, upper story windows, and decorative features.

#### P. 3.11 Windows and Doors

- 1. The rhythm, patterns, and ratio of solids(walls) and voids (windows and doors) of new buildings should relate to and be compatible with adjacent historic facades.
- a. The majority of existing buildings in Charlottesville's historic districts have a higher proportion of wall area than void area except at the storefront level.
- 2. The size and proportion, or the ratio of width to height, of window and door openings on new buildings' primary facades should be similar and compatible with those on surrounding historic facades. a. The proportions of the upper floor windows of most of Charlottesville's historic buildings are more vertical than horizontal.
- b. Glass storefronts would generally have more horizontal proportions than upper floor openings.

#### P. 3.13 Street level Design

- 1. Street level facades of all building types, whether commercial, office, or institutional, should not have blank walls; they should provide visual interest to the passing pedestrian.
- 10. Any parking structures facing on important streets or on pedestrian routes must have storefronts, display windows, or other forms of visual relief on the first floors of these elevations.

#### p. 3.14 - Foundation

- 1. Distinguish the foundation from the rest of the structure through the use of different materials, patterns, or textures.
- 2. Respect the height, contrast of materials, and textures of foundations on surrounding historic buildings.

#### **Discussion and Recommendations**

- The BAR may wish to comment on the following general topics:
  - Relationship to historic architecture
  - Height and width in relation to nearby buildings
  - Massing and footprint
  - Scale and orientation
  - Windows and Doors rhythm, patterns, size and proportion
  - Foundation and cornice articulation
  - Site design including courtyard and parking lot landscape plans

- Setbacks and stepbacks
- Street-level design
- Materials preferences

The BAR was previously supportive of the strong preliminary concept. Providing pedestrian access to Main Street from the hotel lobby is a huge improvement.

The BAR will want to see more landscaping details, particularly in the parking area, which is currently under site plan review.

The BAR must review signage for new construction.

The BAR should discuss proposed materials, articulation details of the building facades, and the resolution of the cornice across the courtyard entrance.

#### **Suggested Motion**

Having considered the standards set forth within the City Code, including City Design Guidelines for New Construction, I move to find that the proposed hotel satisfies the BAR's criteria and is compatible with this property and other properties in this district, and that the BAR approves the massing and scale and materials, with the following details to return to the BAR for approval:....

## P12-0070



### Board of Architectural Review (BAR) **Certificate of Appropriateness**

APR 24 2012

Please Return To: City of Charlottesville

NFIGHBORHOOD DEVELOPMENT SERVICES

Department of Neighborhood Development Services

P.O. Box 911, City Hall Charlottesville, Virginia 22902

Telephone (434) 970-3130 Fax (434) 970-3359

Please submit ten (10) copies of application form and all attachments.

For a new construction project, please include \$375 application fee. For all other projects requiring BAR approval, please include \$125 application fee. For projects that require only administrative approval, please include \$100 administrative fee. Make checks payable to the City of Charlottesville.

The BAR meets the third Tuesday of the month.

Deadline for submittals is Tuesday 3 weeks prior to next BAR meeting by 4 p.m.

Owner Name VIM Inc Contract purchase	Applicant Name Clark Gathrigh
Project Name/Description West Main Residen	,
Property Address 315 West Main St.	
Property Address 313 MG1 MRIL ST.	
Applicant Information Address: 100 10th SI NE Swite 200  Email: cgathright @dgarchs.com Phone: (W) 971-8878 (H)  FAX: 296-3040  Property Owner Information (if not applicant)	Signature of Applicant I hereby attest that the information I have provided is, to the best of my knowledge, correct. (Signature also denotes commitment to pay invoice for required mail notices.)  Signature  Date
Address: P.O. Drawer 359  Fryetterill, WV 25340  Email: wend 1948@bellsouth.net  Phone: (W) 843-991-0396 (H)  FAX:	its submission.
Do you intend to apply for Federal or State Tax Credits for this project? No	Signature Date  Clark Gathvich 4/24/12  Print Name Date
Description of Proposed Work (attach separate narra	ative if necessary): 7-story hotel with
List All Attachments (see reverse side for submittal	requirements):
For Office Use Only	Approved/Disapproved by:
Received by: 88W	Date:
Fee paid: 350.60 Cash Ck.# 1088	Conditions of approval:
Date Received: 4(24/2012	



CHARLOTTESVILLE, VIRGINIA




## **SCALE AND MASSING SUBMITTAL PACKAGE**

May 29, 2012

100 10TH STREET NE, SUITE 200 CHARLOTTESVILLE, VA 22902 T 434,971 8848 F 434,296 3040

www.daggettgrigg.com

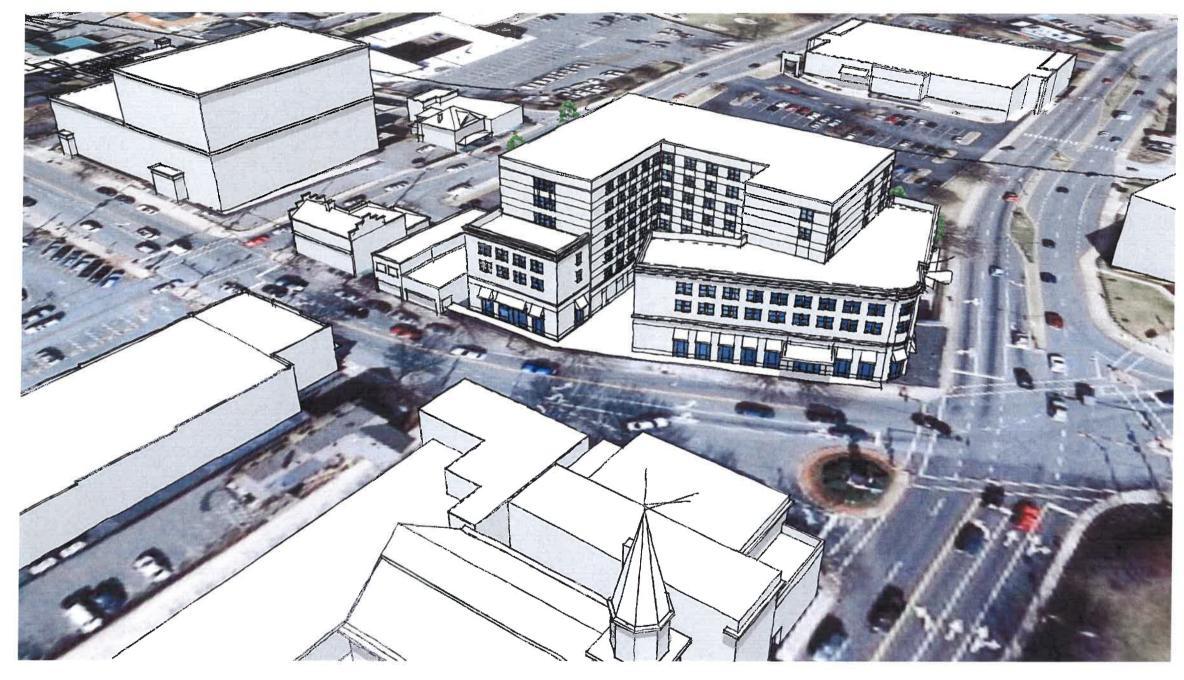

Aerial view looking north from Ridge St.

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View from West Main/Ridge St. intersection

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May 29, 2012 Page 3 of 13



View from West Main/Ridge St. intersection

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**West Main Elevation** 

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View looking west on West Main St.

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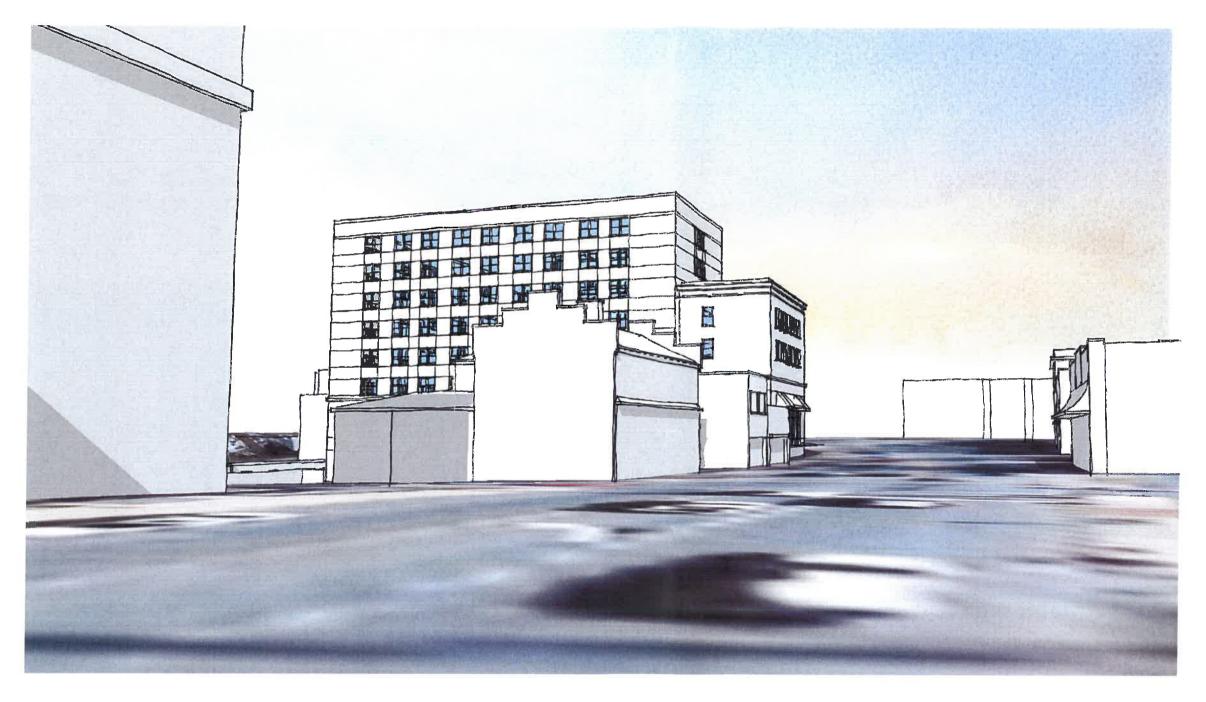


View looking east on West Main St.

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View looking east on West Main St.

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View looking south on Fourth St.

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View from northeast

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View looking south on Ridge St.

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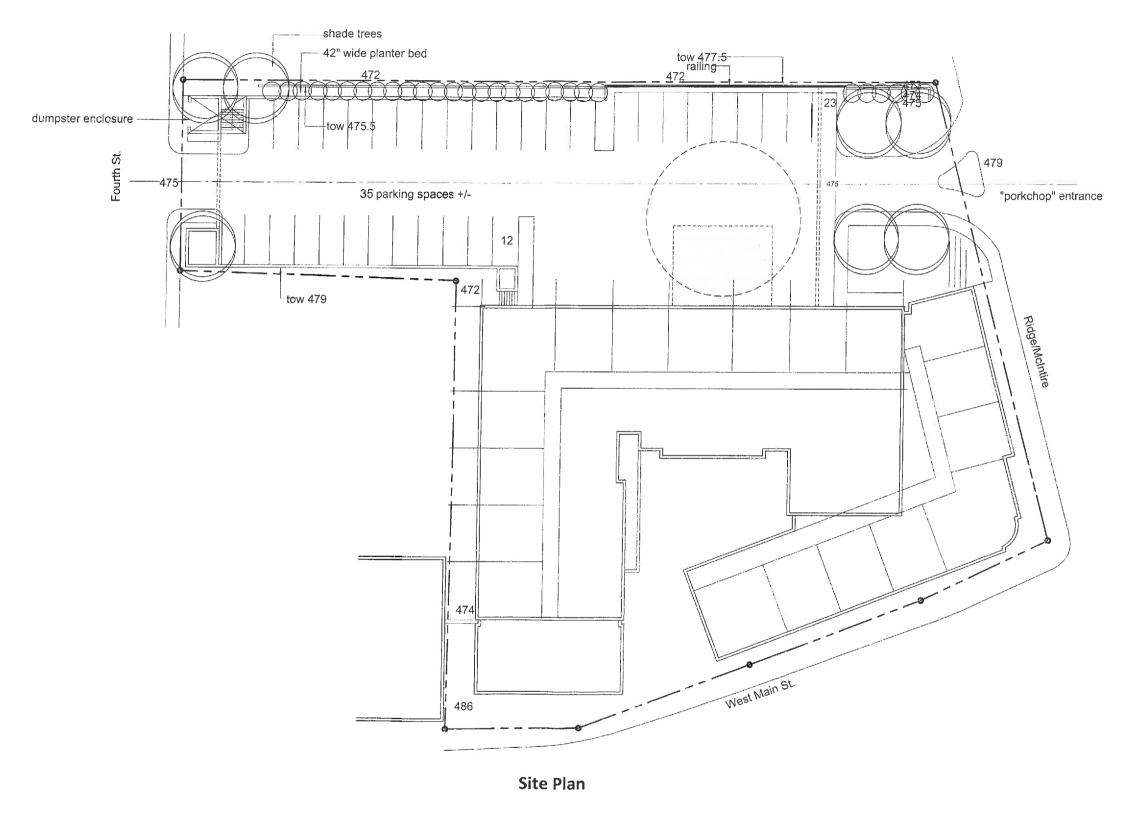
View looking west from Water St.

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- A2.3 Third & Fourth Floor Plans
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  - Architectural Rendering West Main St. & Ridge McIntire Rd.

## **Project Data**

#### SQUARE FOOTAGE:

FLOOR	GROSS SQ	L FOOTAGE
LOWER LEVEL PARKING PLAN	31,769 SQ. FT.	
ARRIVAL LEVEL PLAN		6,13Ø 9Q. FT.
GROUND FLOOR PLAN		21,734 SQ. FT.
SECOND FLOOR / MEZZANINE PLAN		14,690 SQ. FT.
THIRD FLOOR PLAN		20,358 SQ. FT
FOURTH FLOOR PLAN		20,358 SQ. FT
FIFTH FLOOR PLAN		11,957 SQ. FT.
SIXTH FLOOR PLAN		11,957 SQ, FT,
SEVENTH FLOOR PLAN		11,951 SQ. FT.
TOTAL	31,769 9Q. FT.	119,141 SQ. FT.



803 S. MOUNT MORIAL SUITE 100B MEMPHIS, TN 38117 (901) 683-7175 p. (901) 683-2385 f. Ilw@llwarchitects.com

DATE

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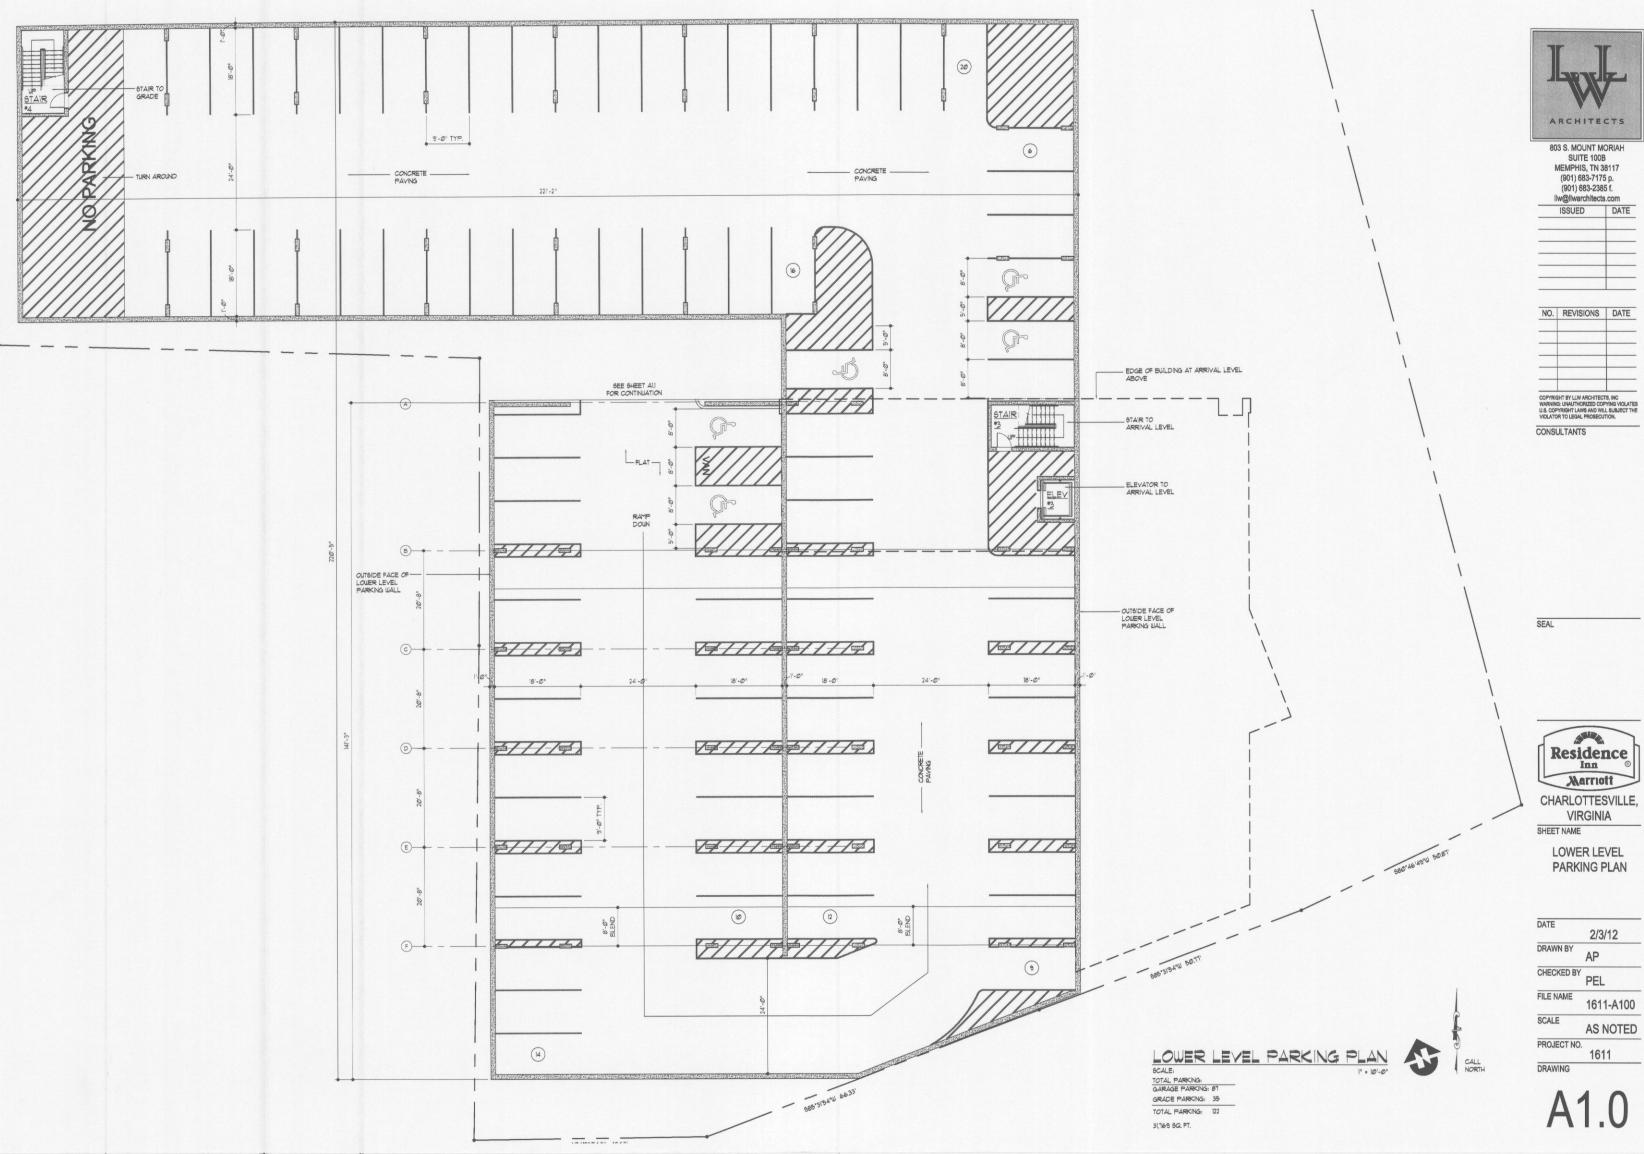



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COVER SHEET WITH PROJECT DATA

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DRAWN BY	PEL
CHECKED BY	PEL
FILE NAME	1611-A000
SCALE	NONE
PROJECT NO.	1611
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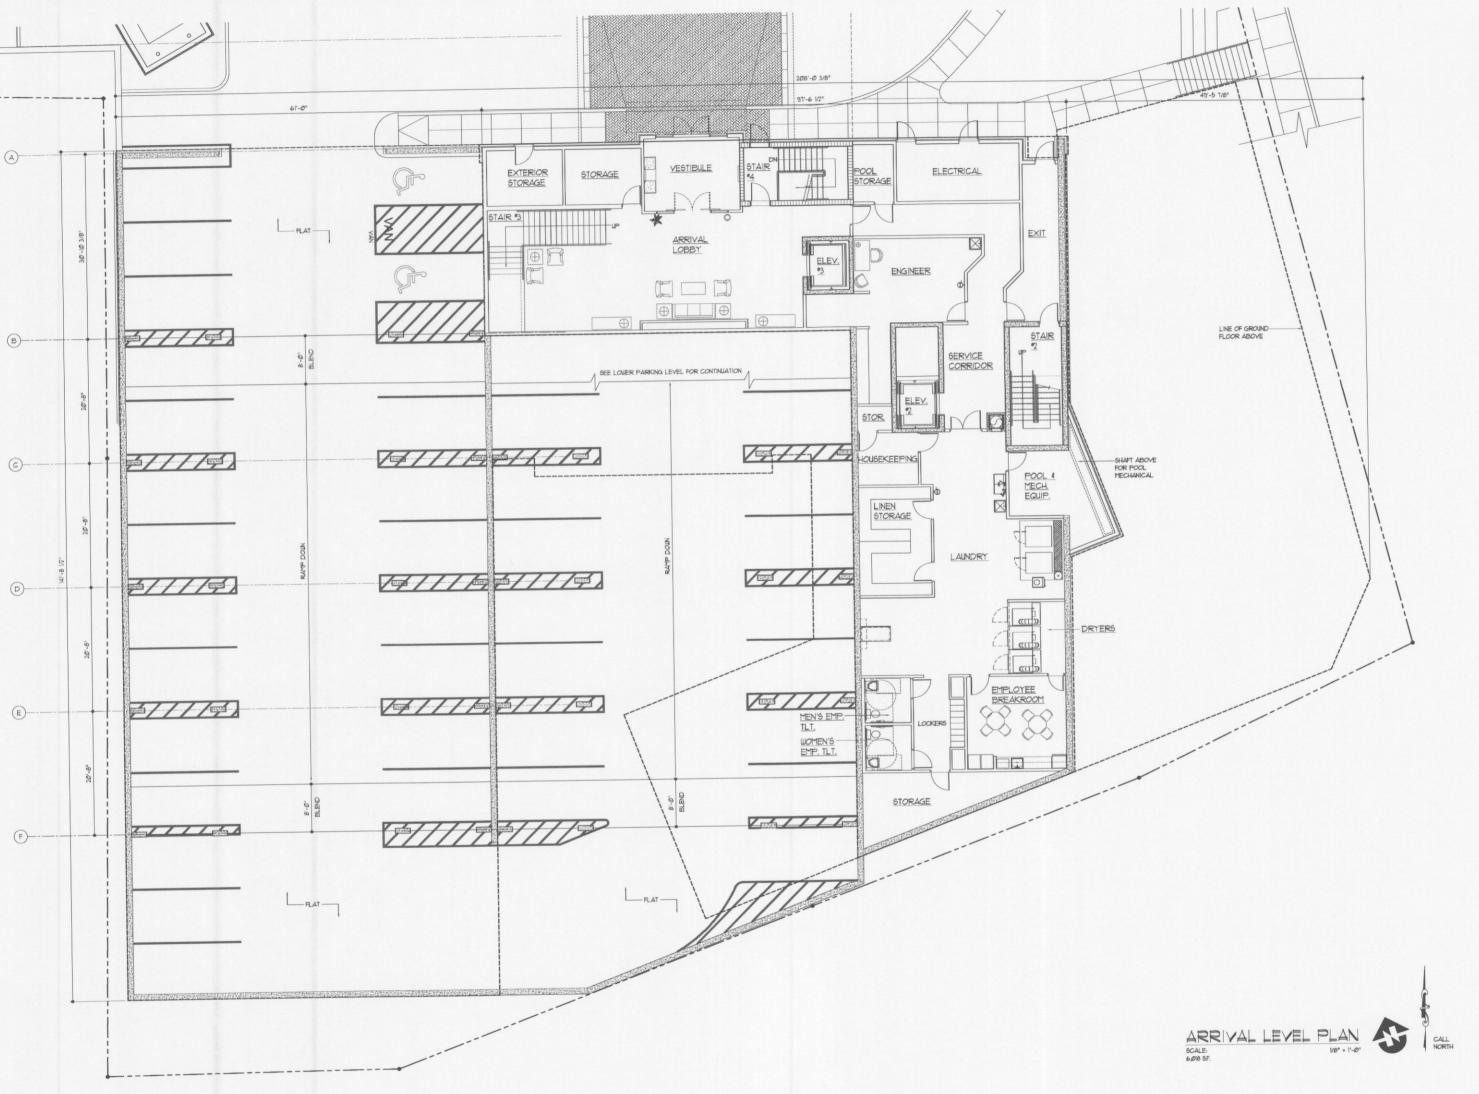
> SITE PLAN / ARRIVAL LEVEL

2/3/12

1611-A101

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1611

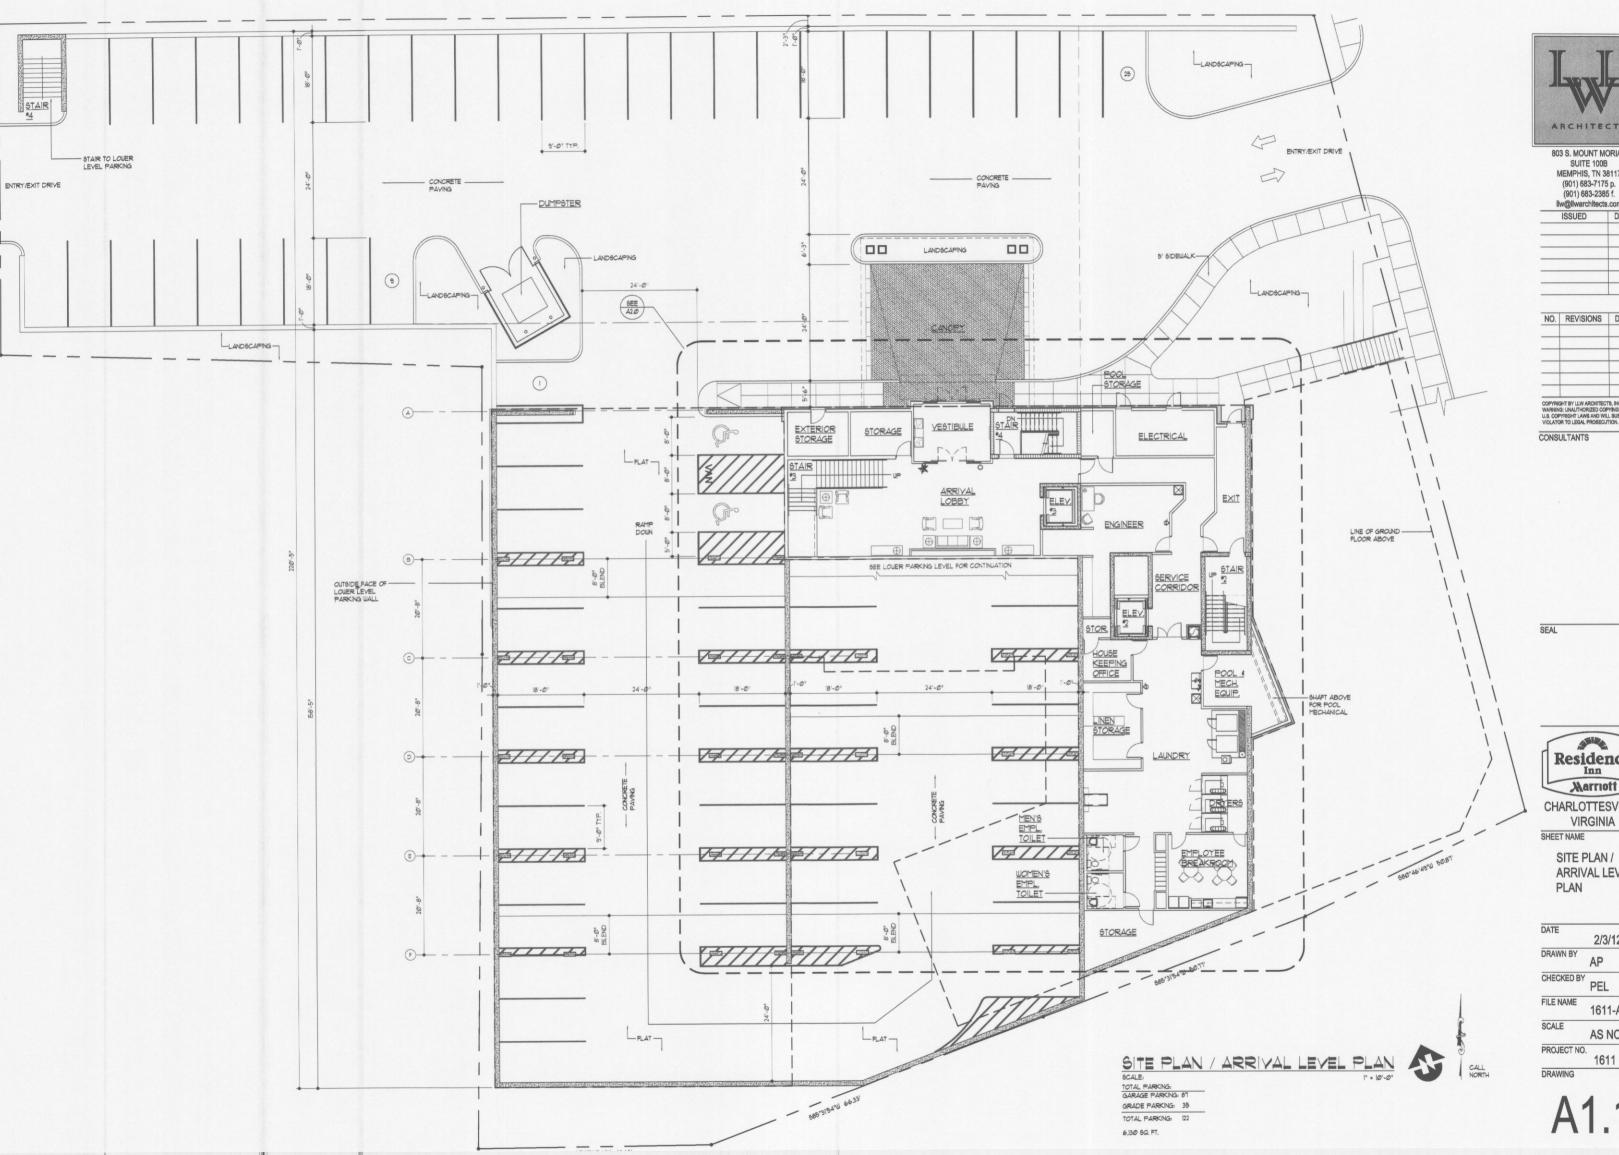



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> ARRIVAL LEVEL PLAN

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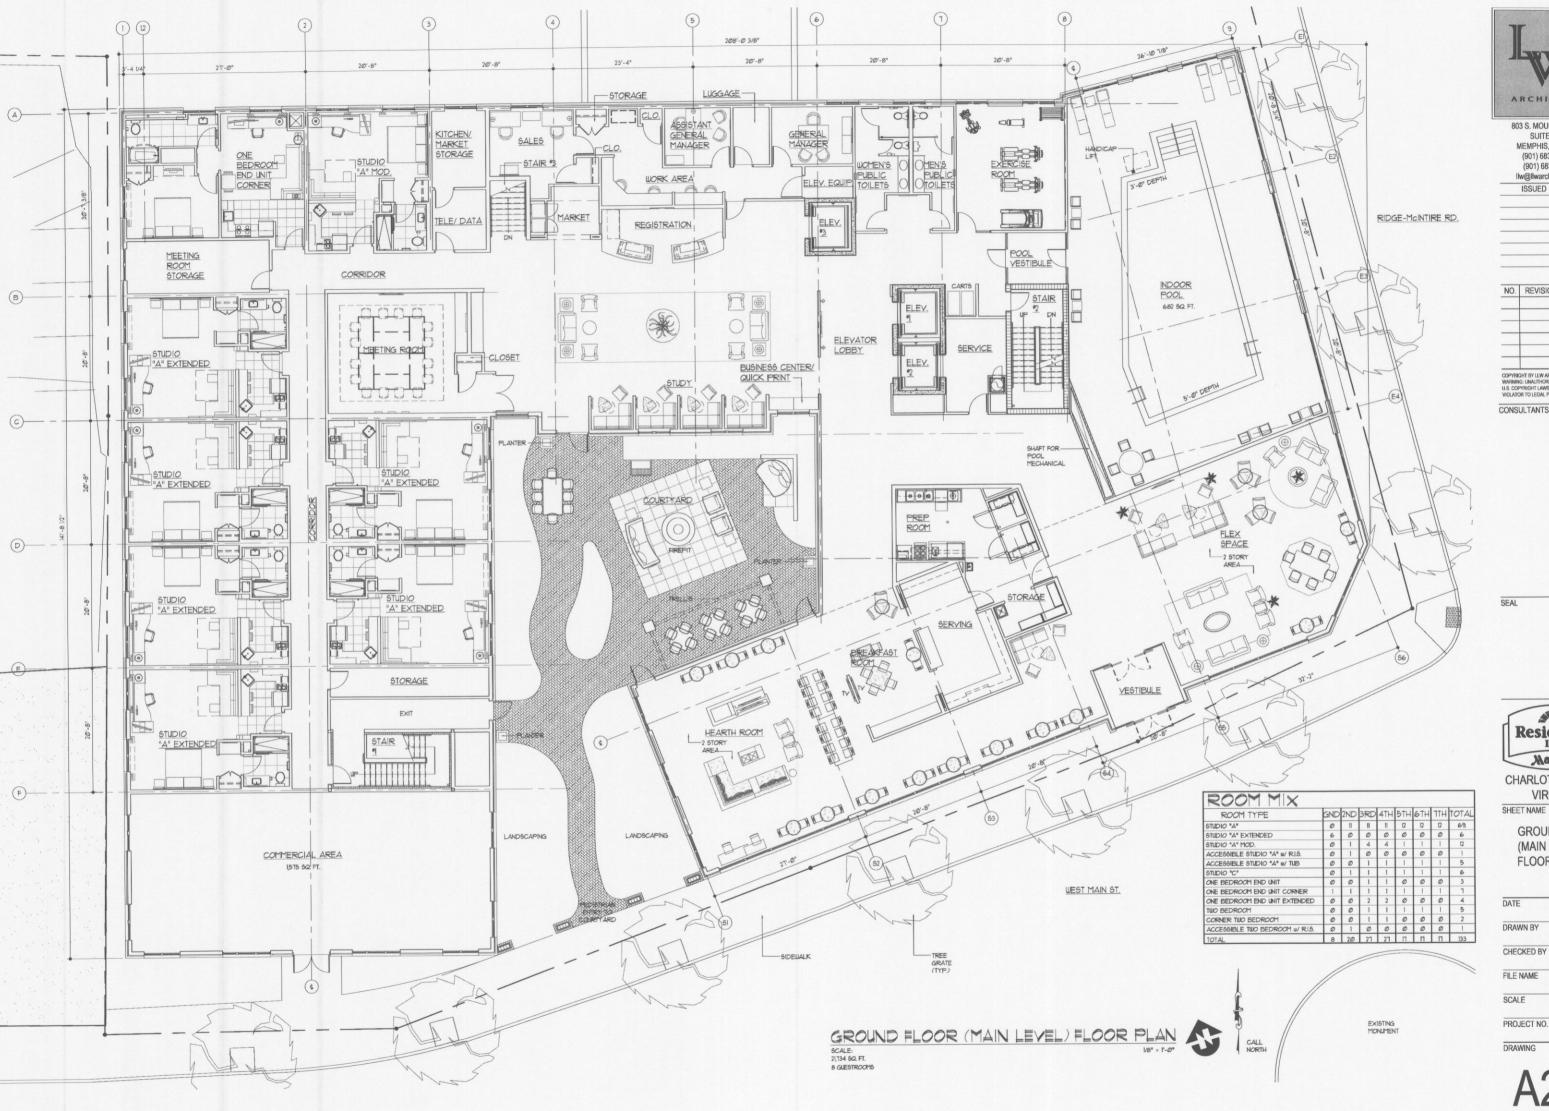
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> **GROUND FLOOR** (MAIN LEVEL) FLOOR PLAN

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1611





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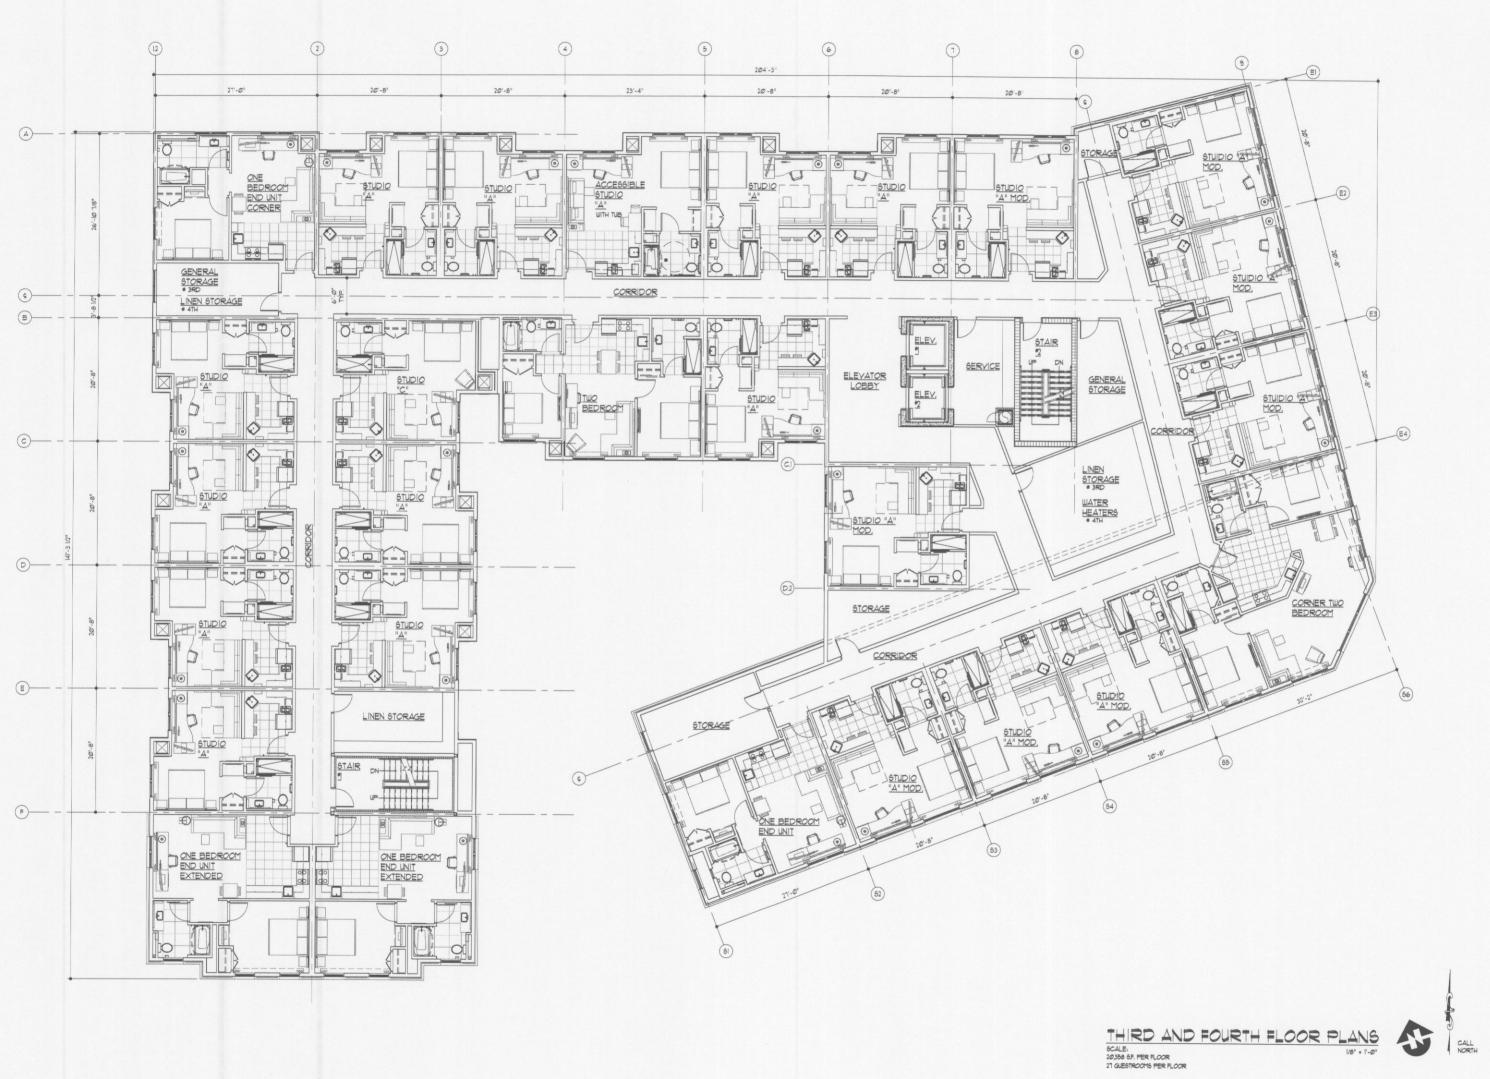
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SECOND & MEZZANINE FLOOR PLAN

A2.2





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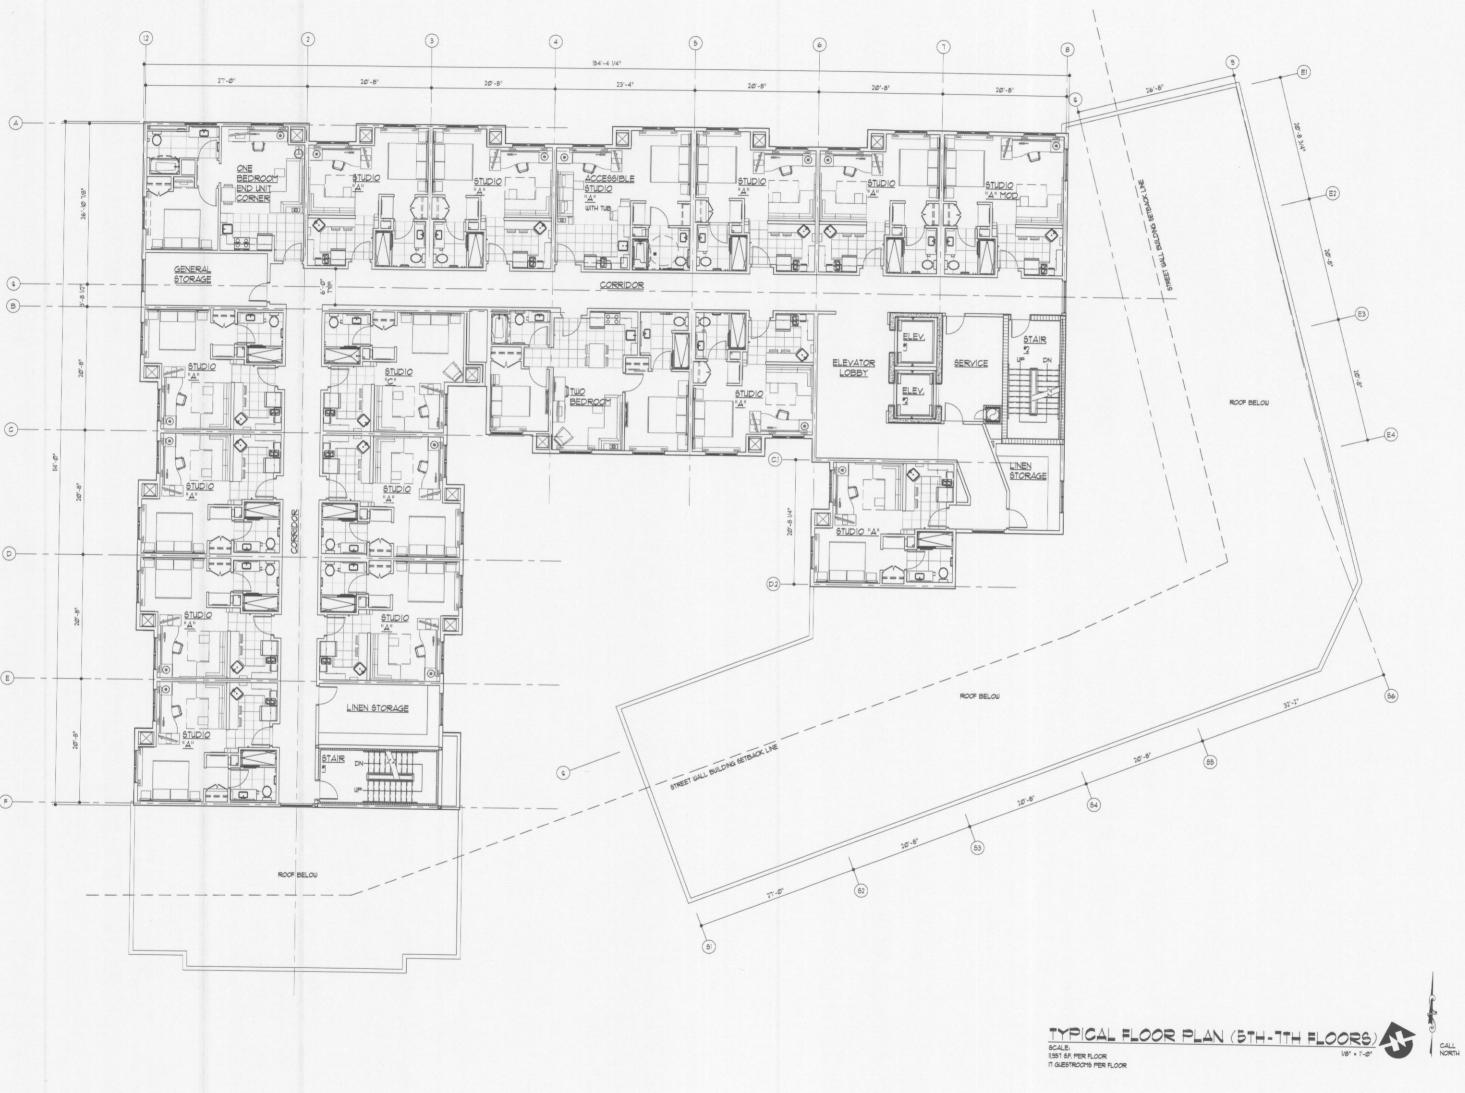
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> THIRD AND FOURTH FLOOR PLANS

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TYPICAL FLOOR PLAN (5TH-7TH) FLOORS

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Residence Inn Marriott


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**EXTERIOR ELEVATIONS** 


SOUTH ELEVATION

EXTERIOR ELEVATIONS
SCALE: 1/0" . 1'-0"

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A3.2

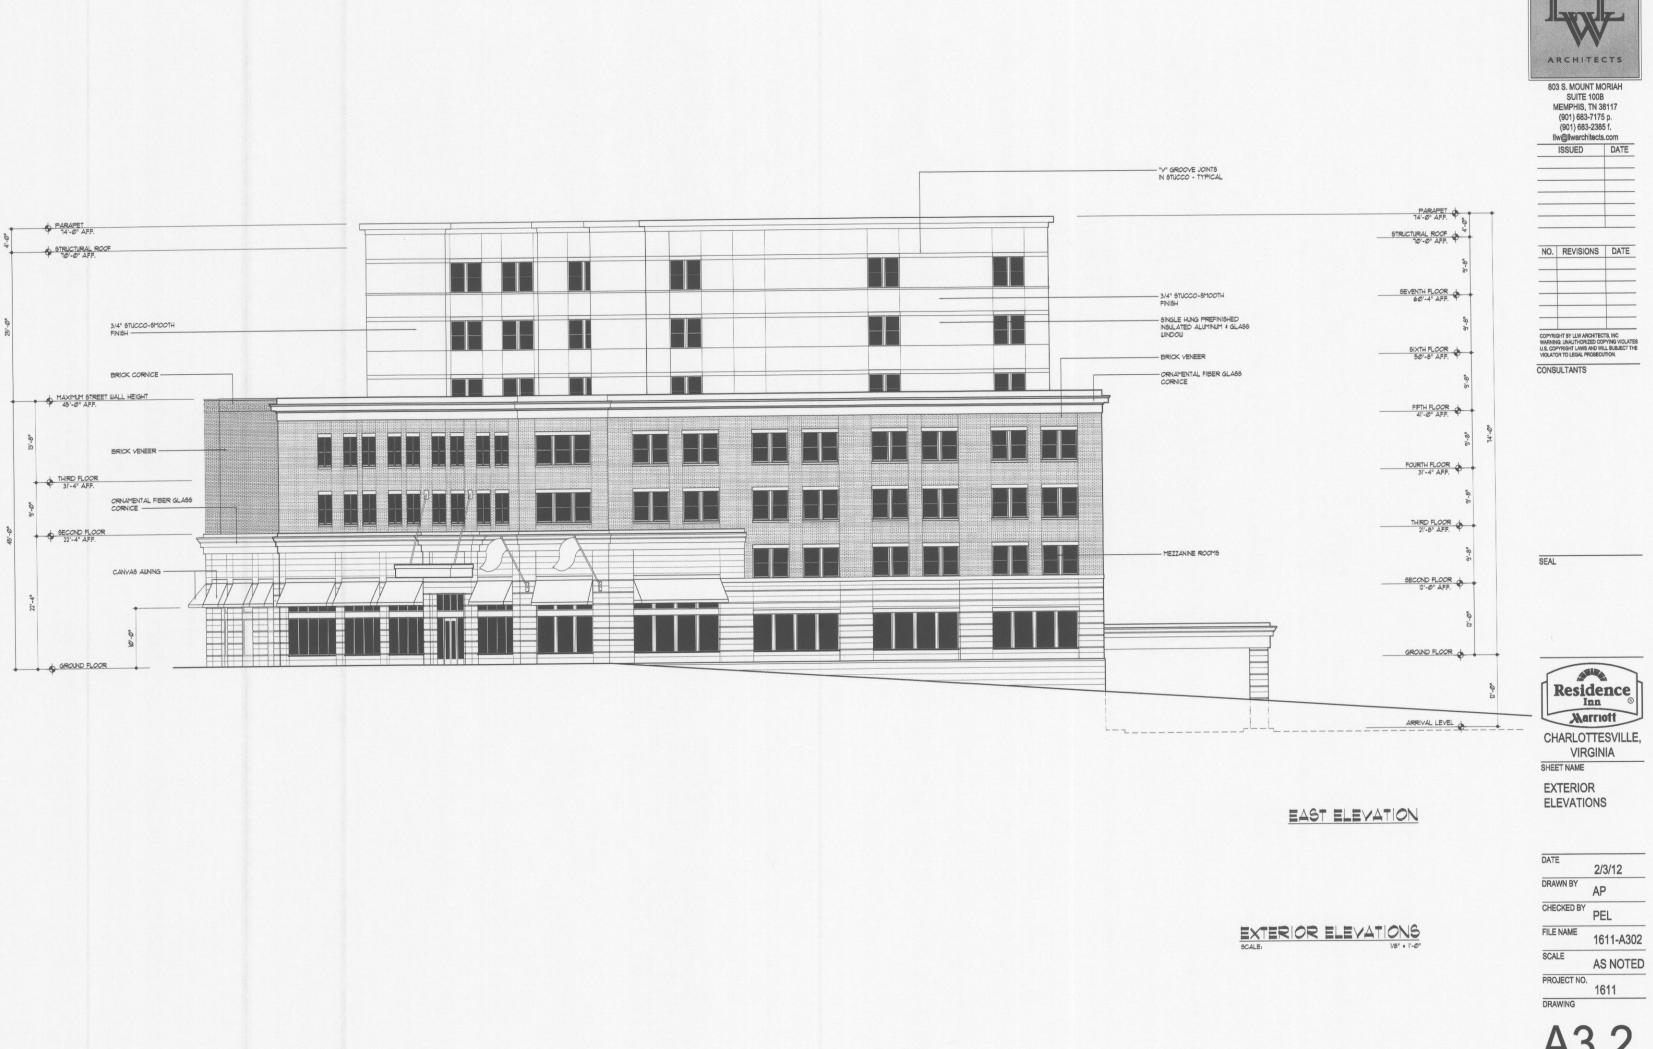

WEST ELEVATION

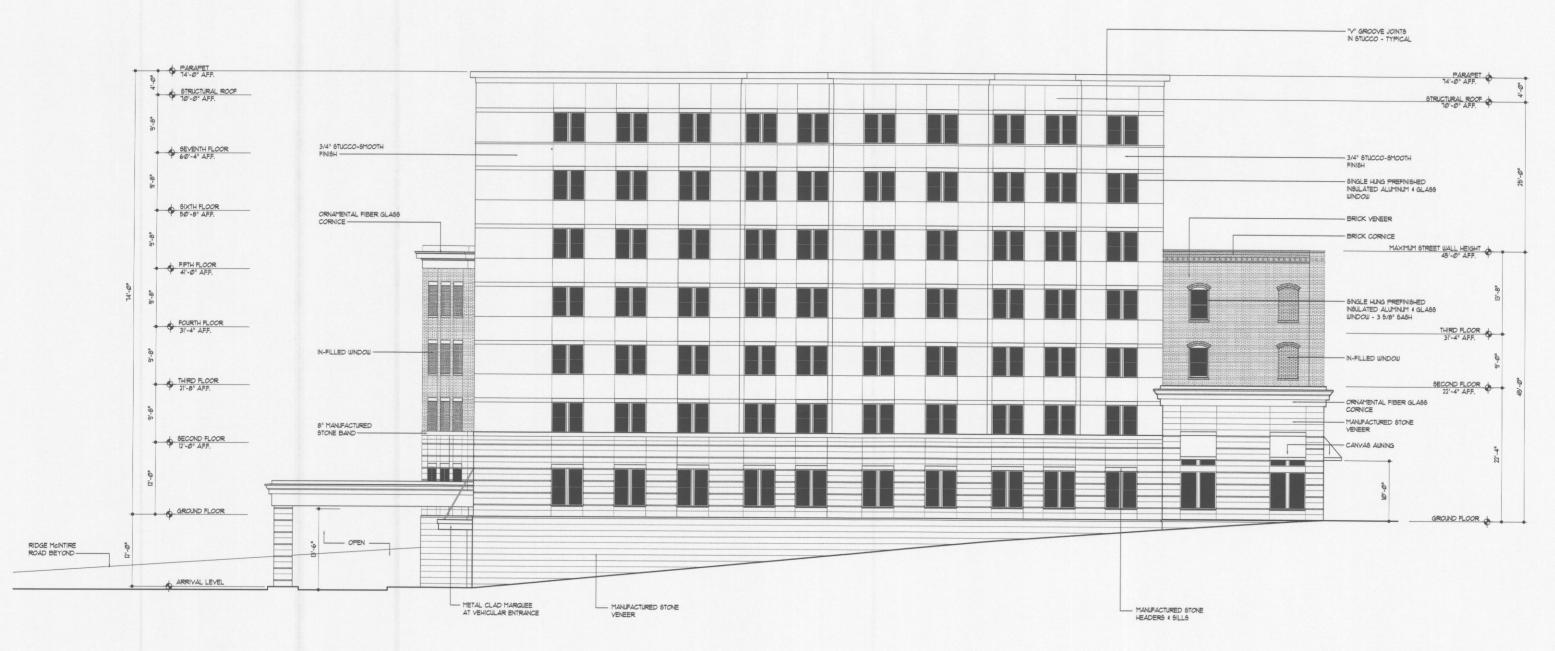EXTERIOR ELEVATIONS
SCALE: 1/8" · 1'-0"



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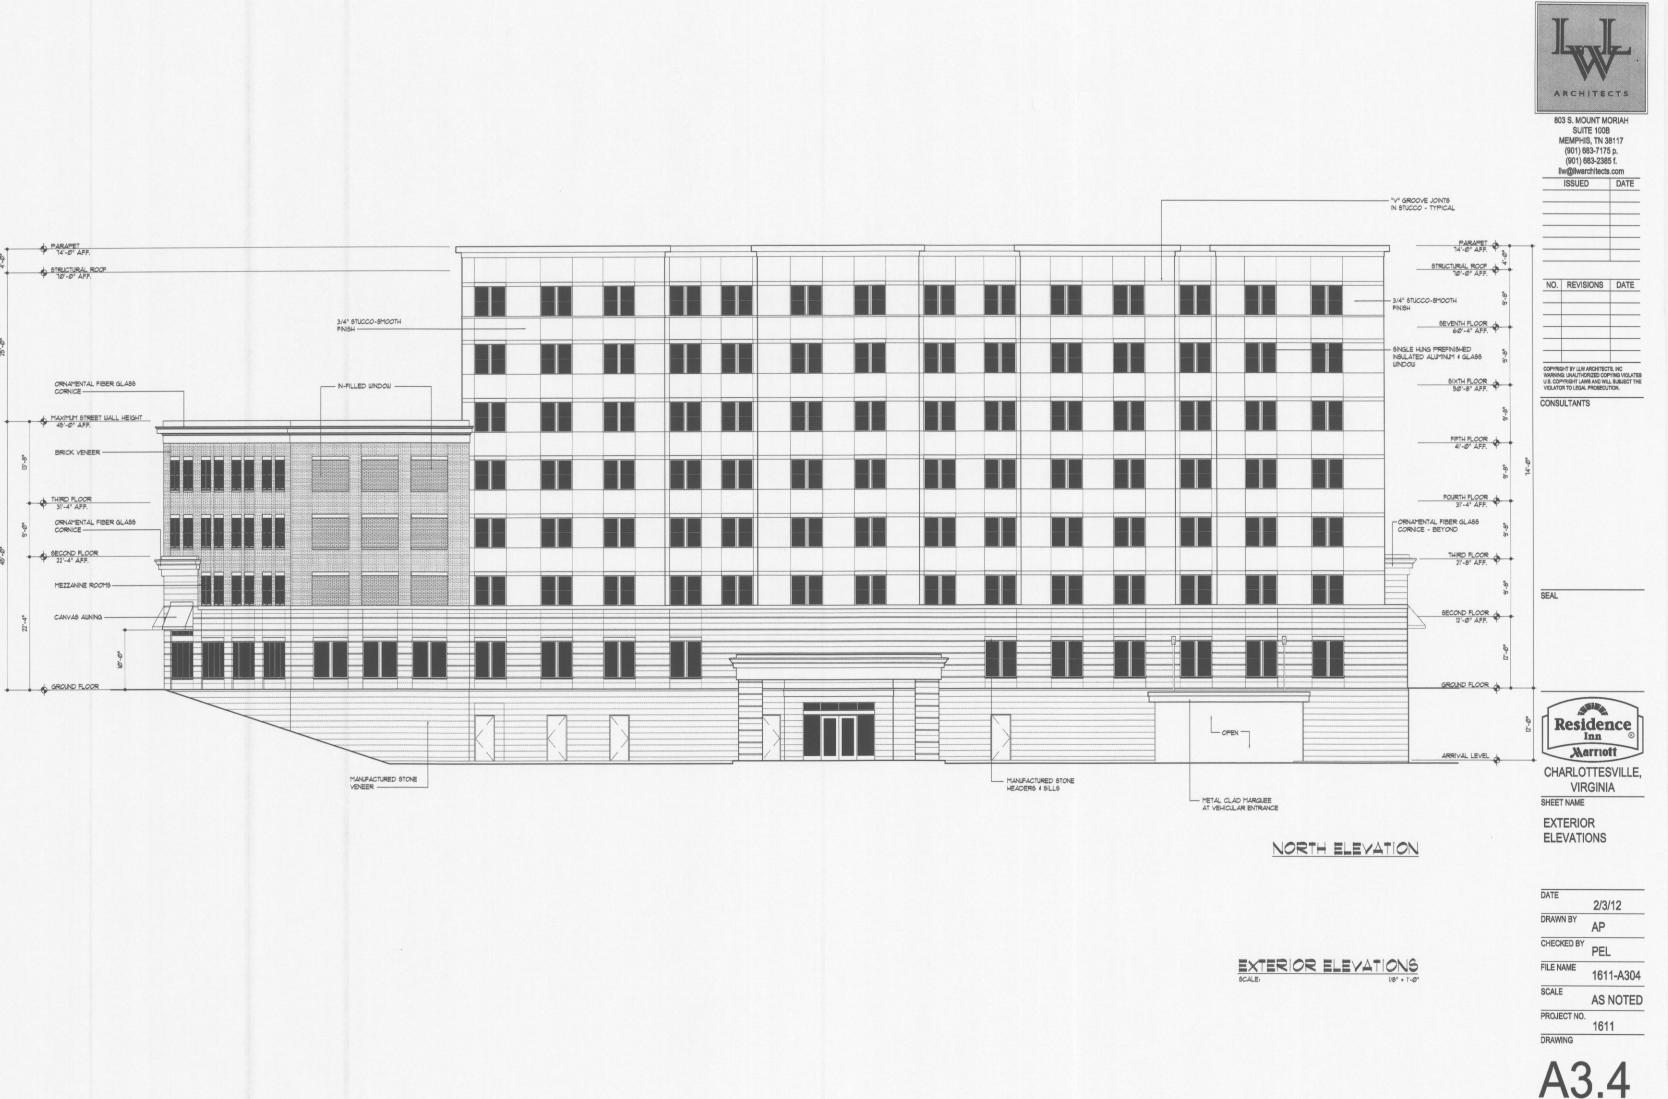



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EXTERIOR ELEVATIONS


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DRAWING





A3.4A

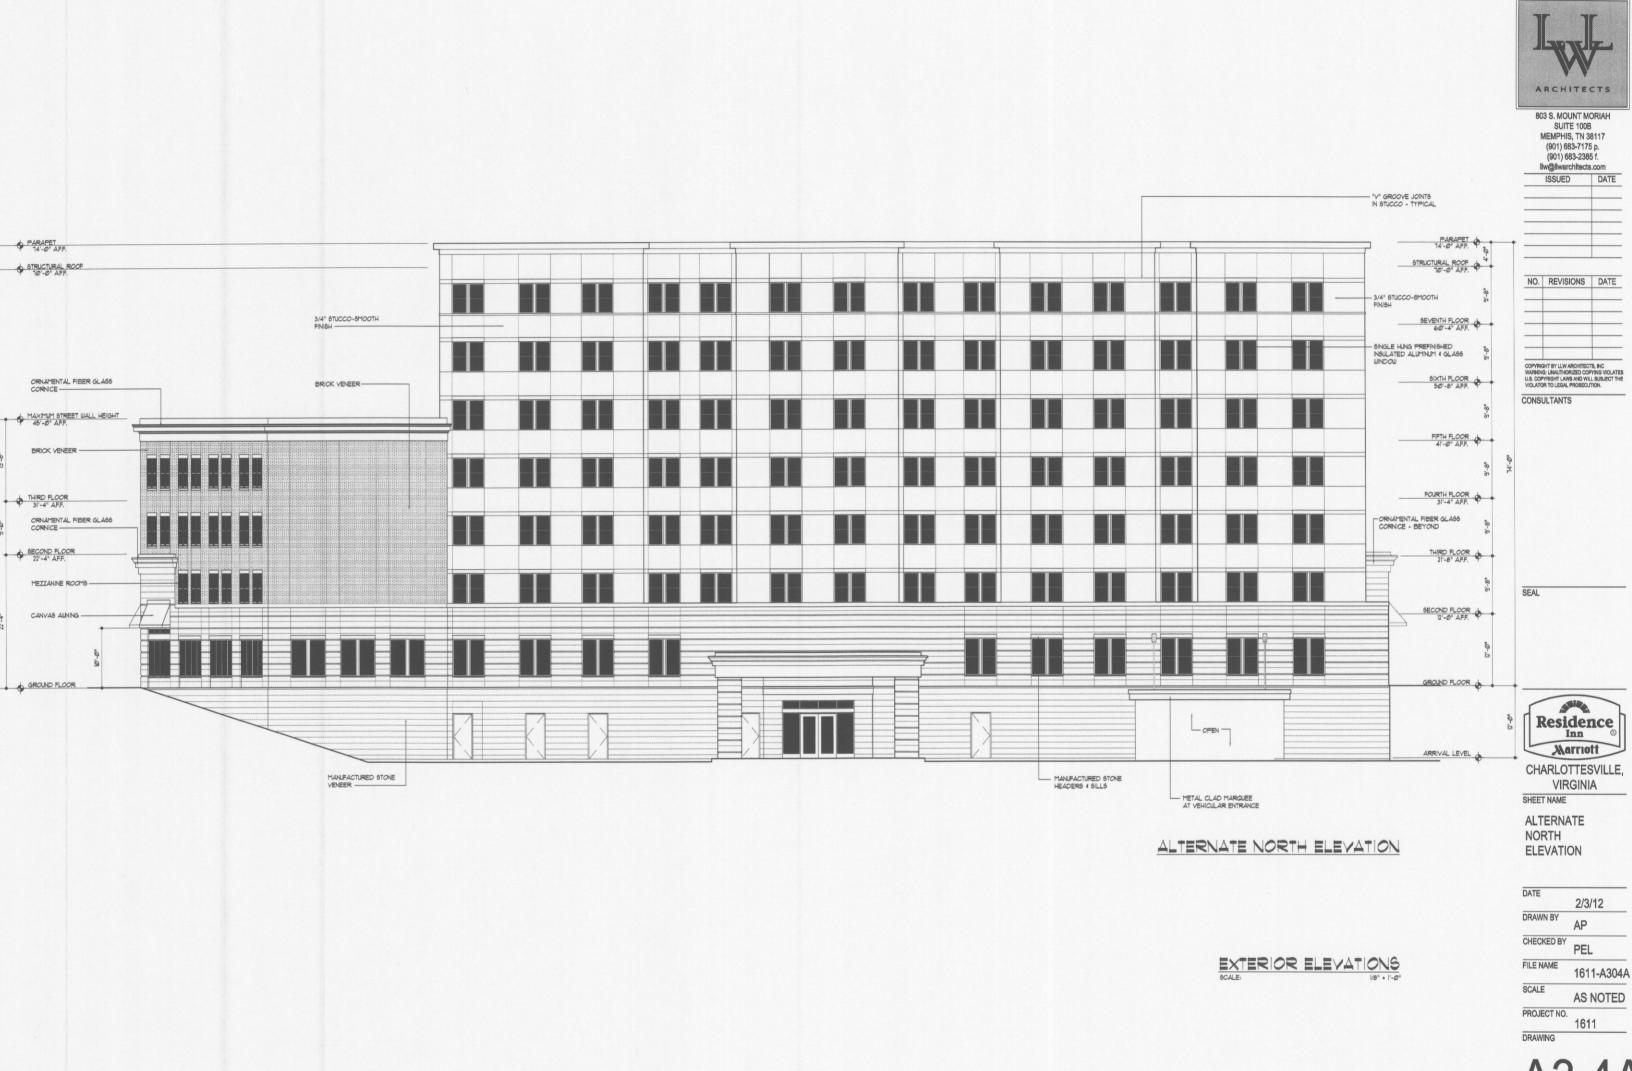

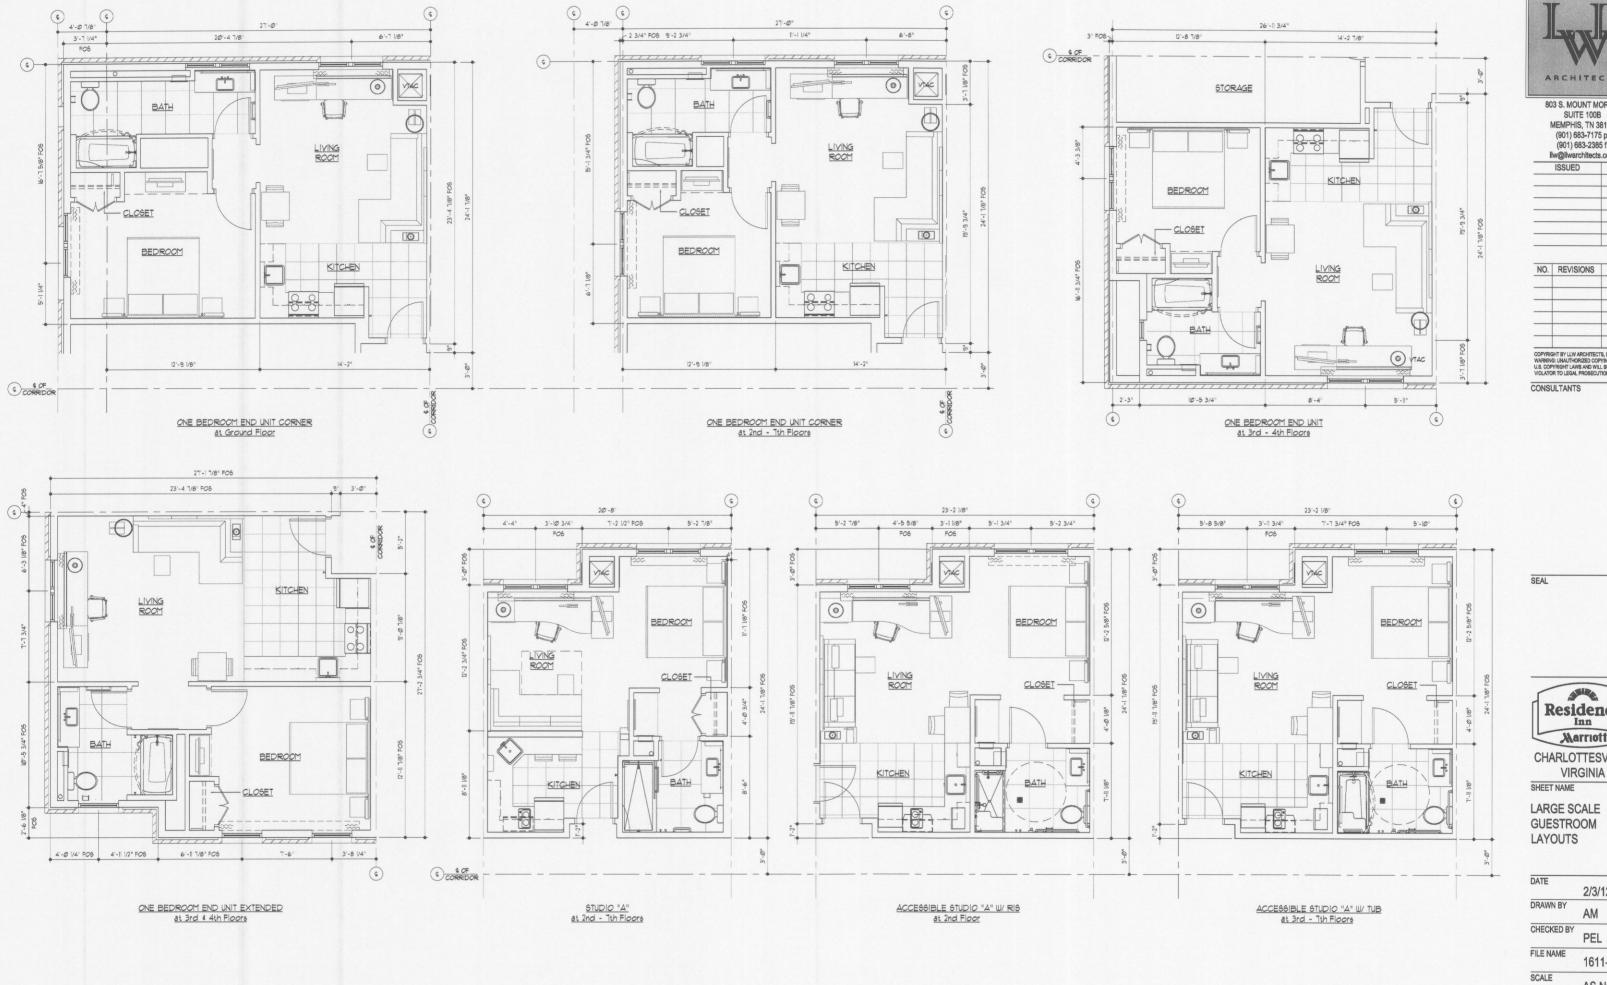LARGE SCALE GUESTROOM LAYOUTS
SCALE: 1/41-1/-07



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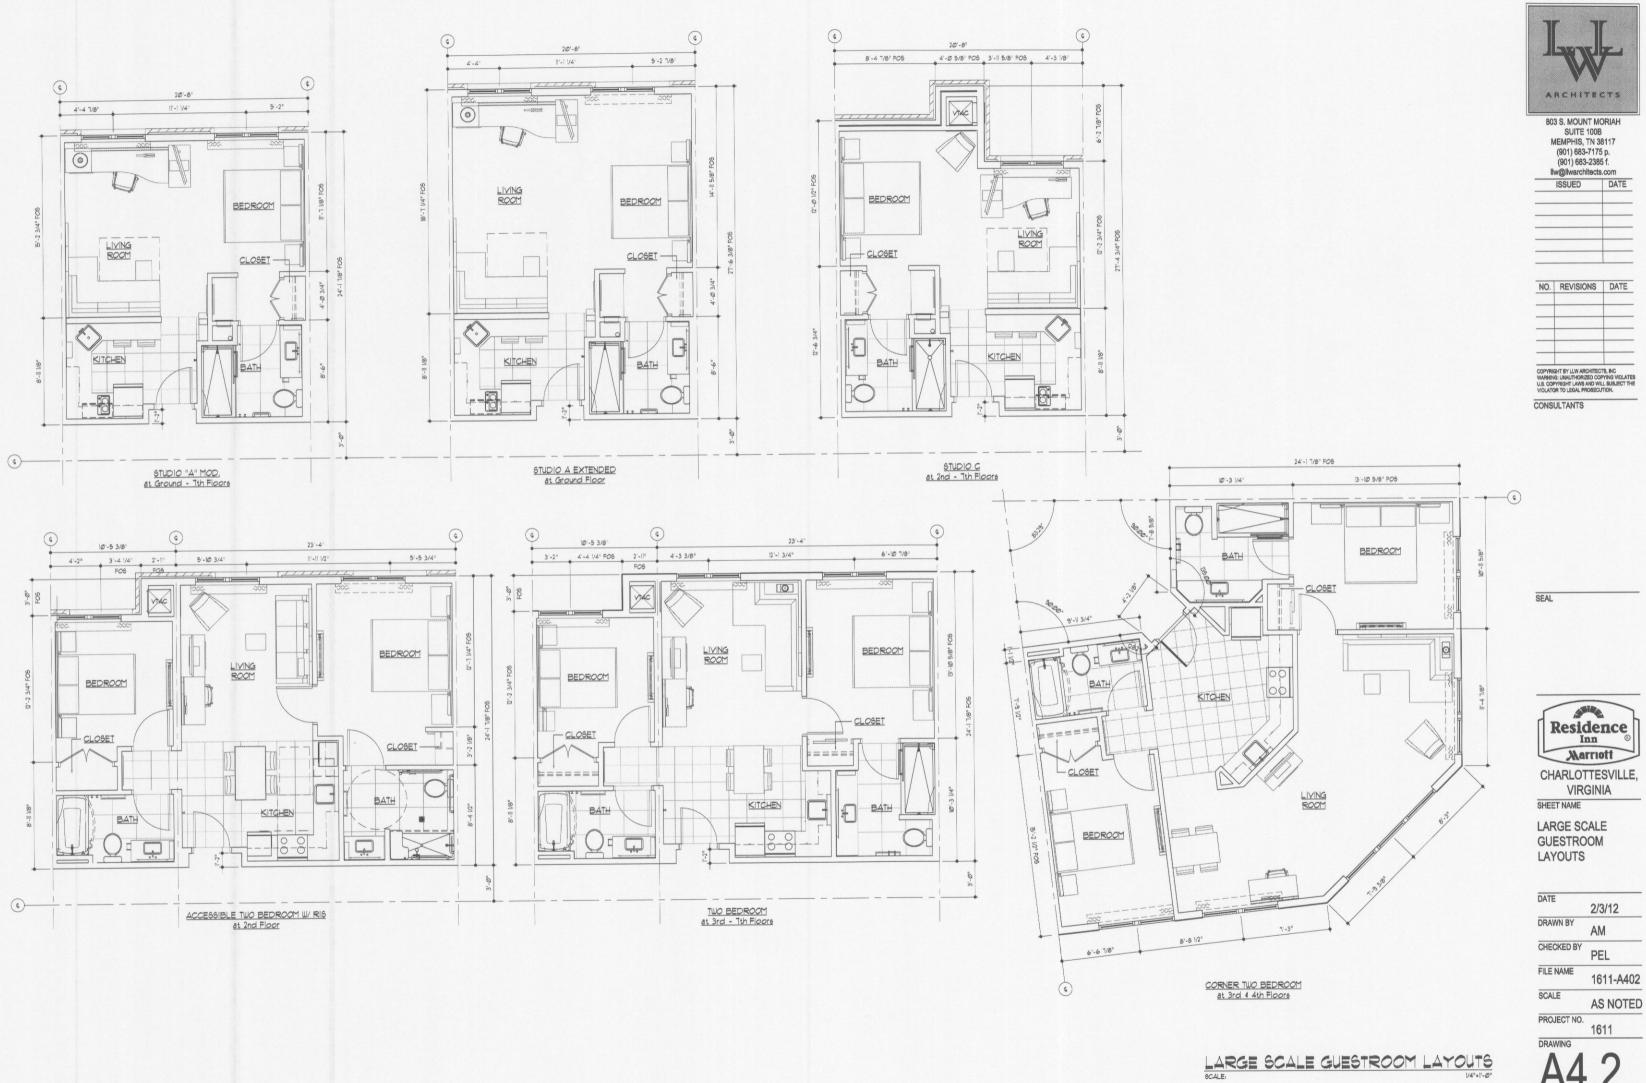
**VIRGINIA** 


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1611-A401

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1611 DRAWING





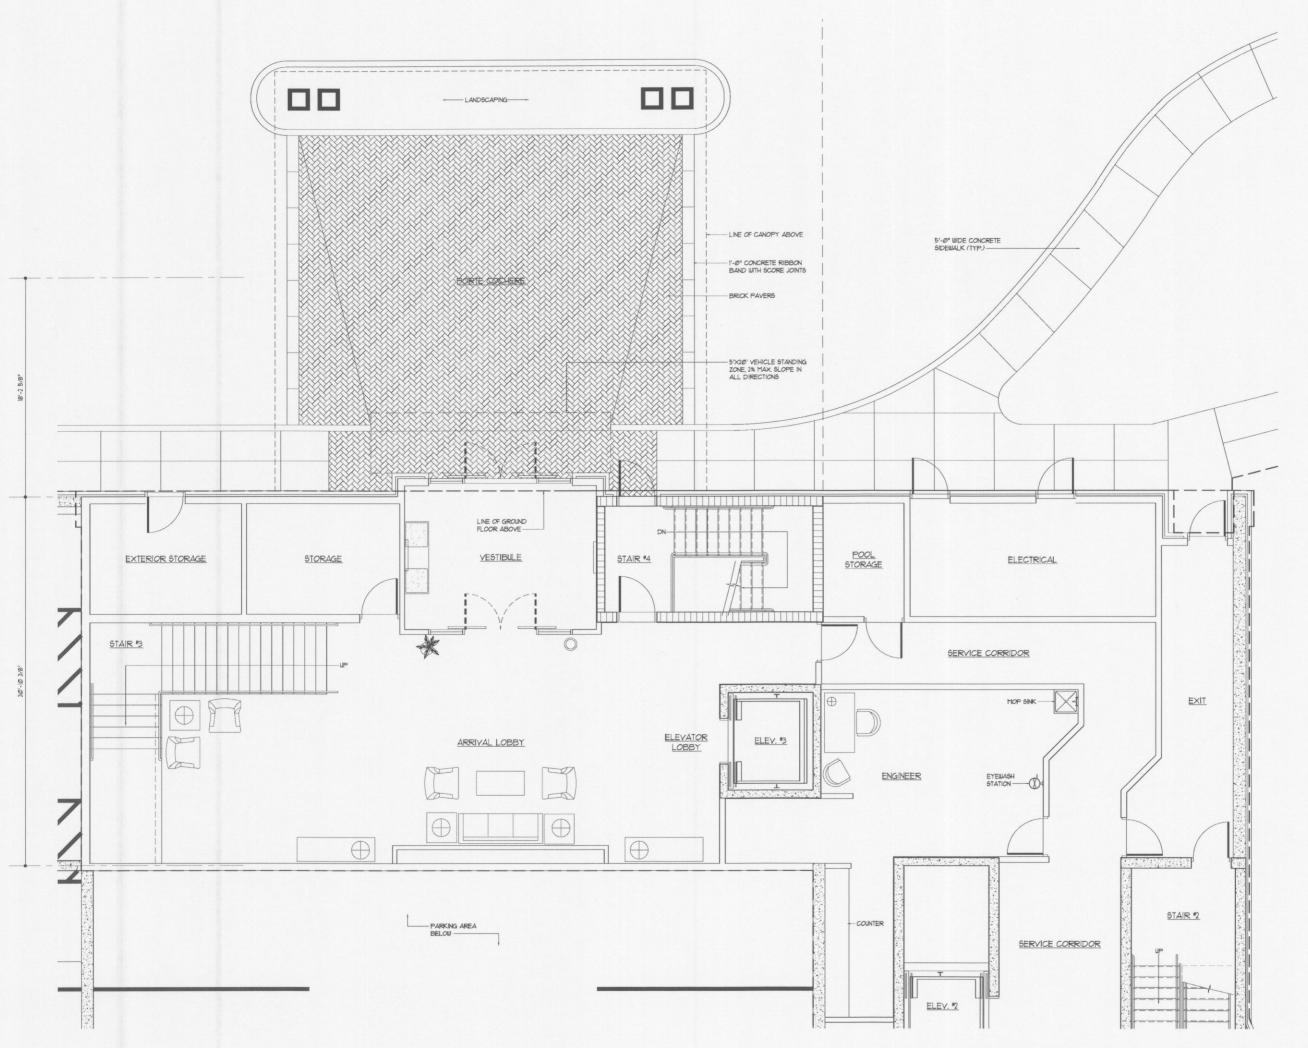

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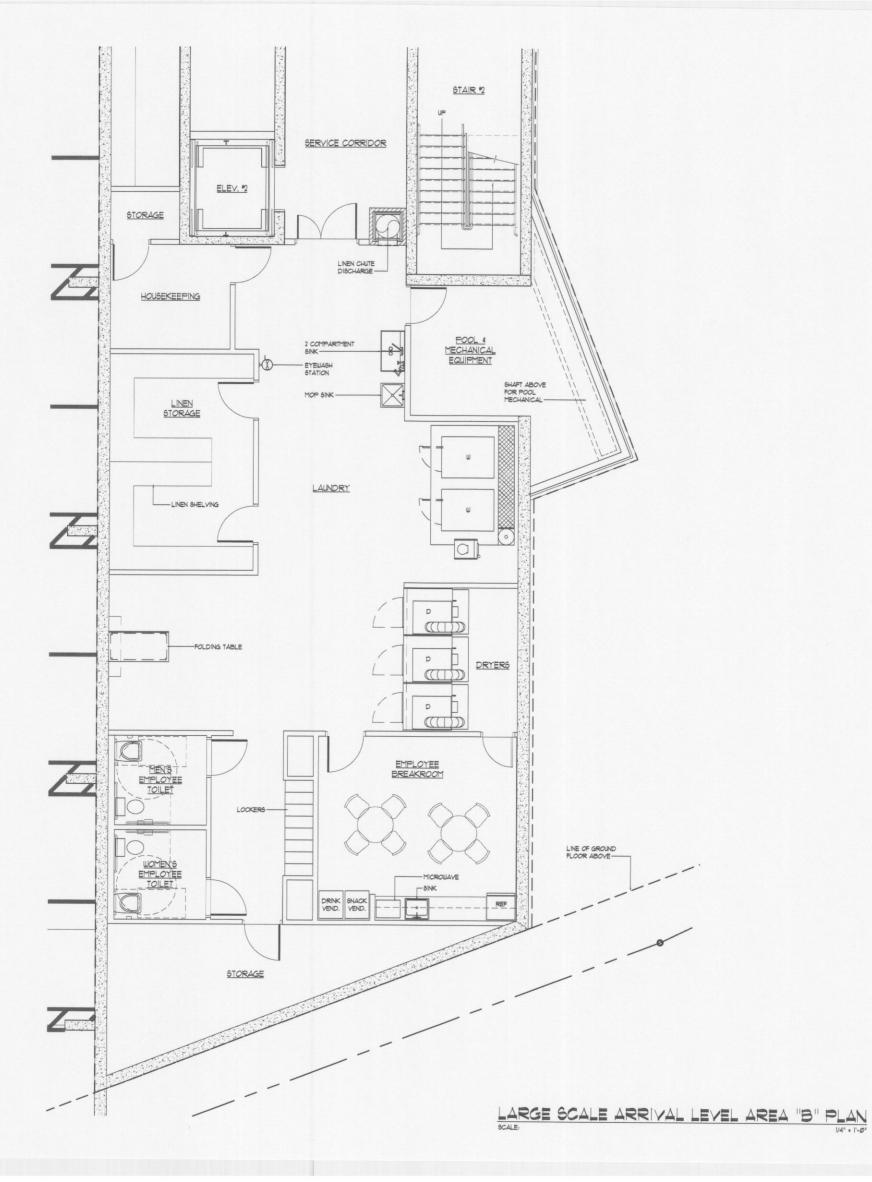


CHARLOTTESVILLE, **VIRGINIA** SHEET NAME

LARGE SCALE ARRIVAL LEVEL AREA "A" PLAN

DATE 2/3/12 DRAWN BY CHECKED BY PEL 1611-A403 AS NOTED

LARGE SCALE ARRIVAL LEVEL AREA "A" PLAN SCALE:





803 S. MOUNT MORIAH SUITE 100B MEMPHIS, TN 38117 (901) 683-7175 p. (901) 683-2385 f. Ilw@llwarchitects.com

iiw@iiwarchited	cts.com
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CHARLOTTESVILLE, VIRGINIA SHEET NAME


LARGE SCALE ARRIVAL LEVEL AREA "A" PLAN


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	1011-A404
SCALE	The second second

AS NOTED PROJECT NO. 1611

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SHEET NAME

LARGE SCALE GROUND FLOOR AREA "B" PLAN

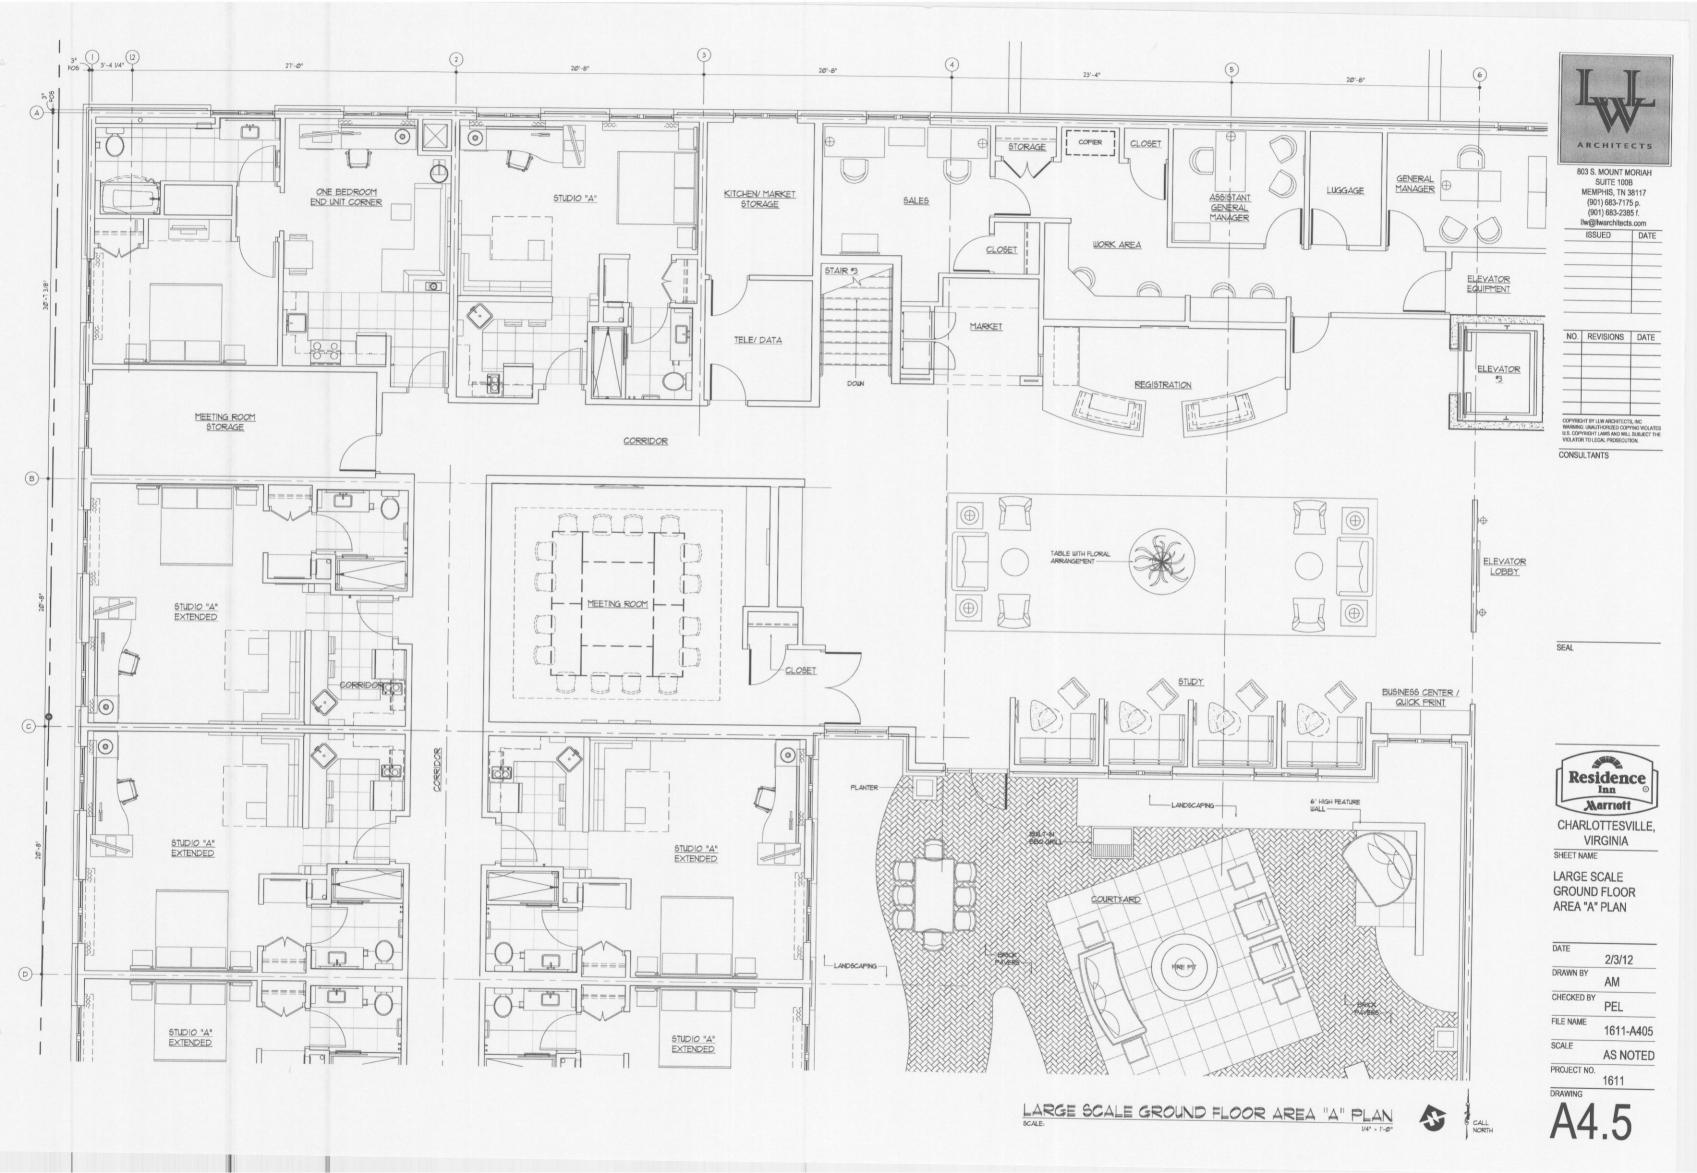DATE 2/3/12
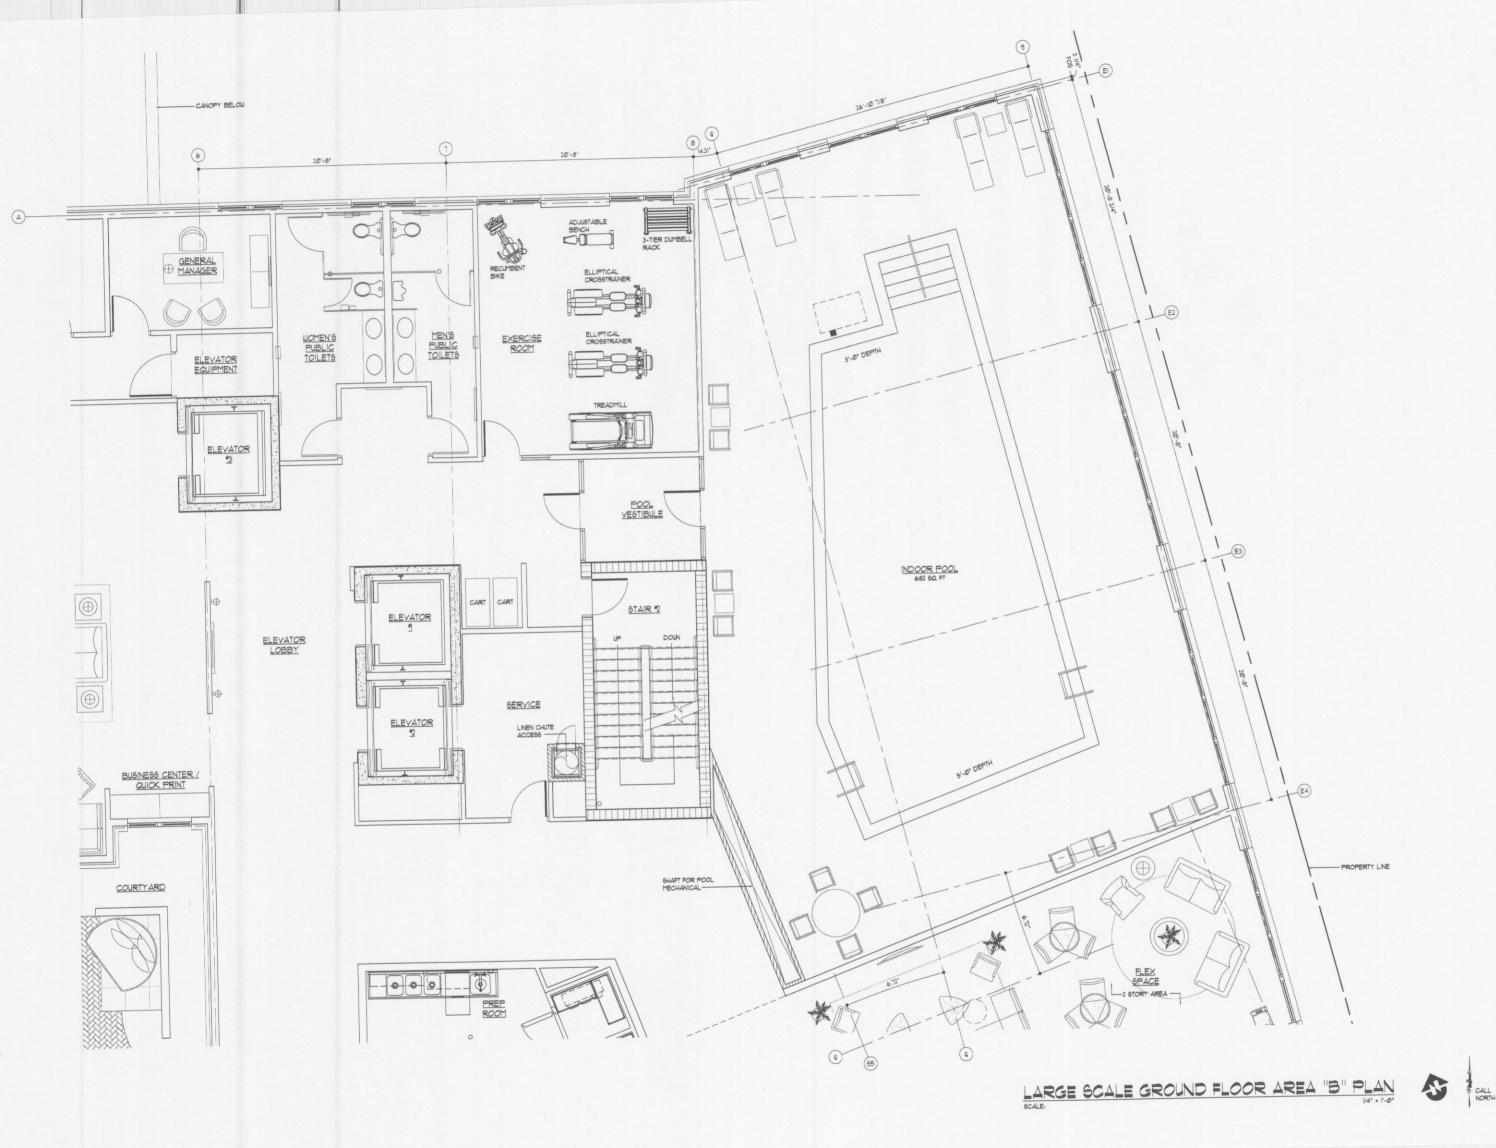
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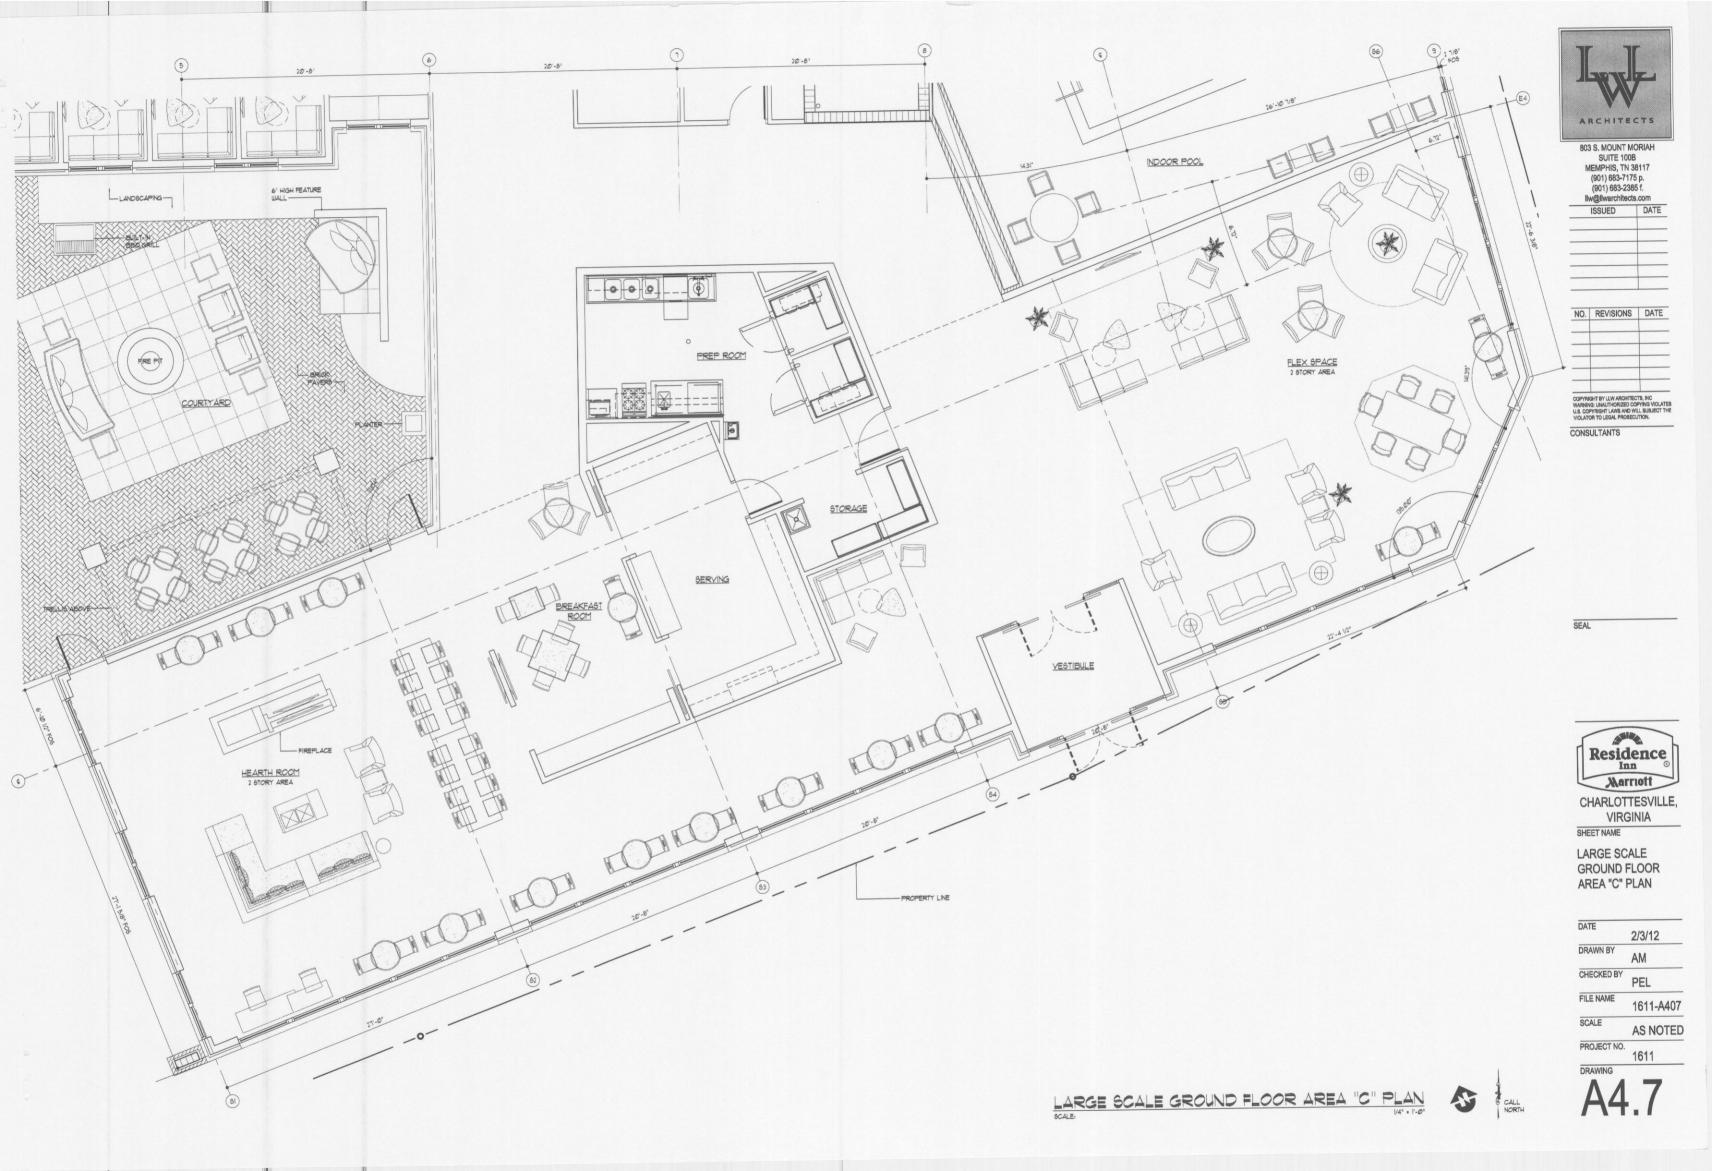
FILE NAME 1611-A406

SCALE AS NOTED

AS NOTED

PROJECT NO.

A4.6





BUILDING SECTION SCALE: 1/8" - 1'-0"



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SECTION

BUILDING

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FILE NAME 1611-A701

SCALE AS NOTED

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A7 1